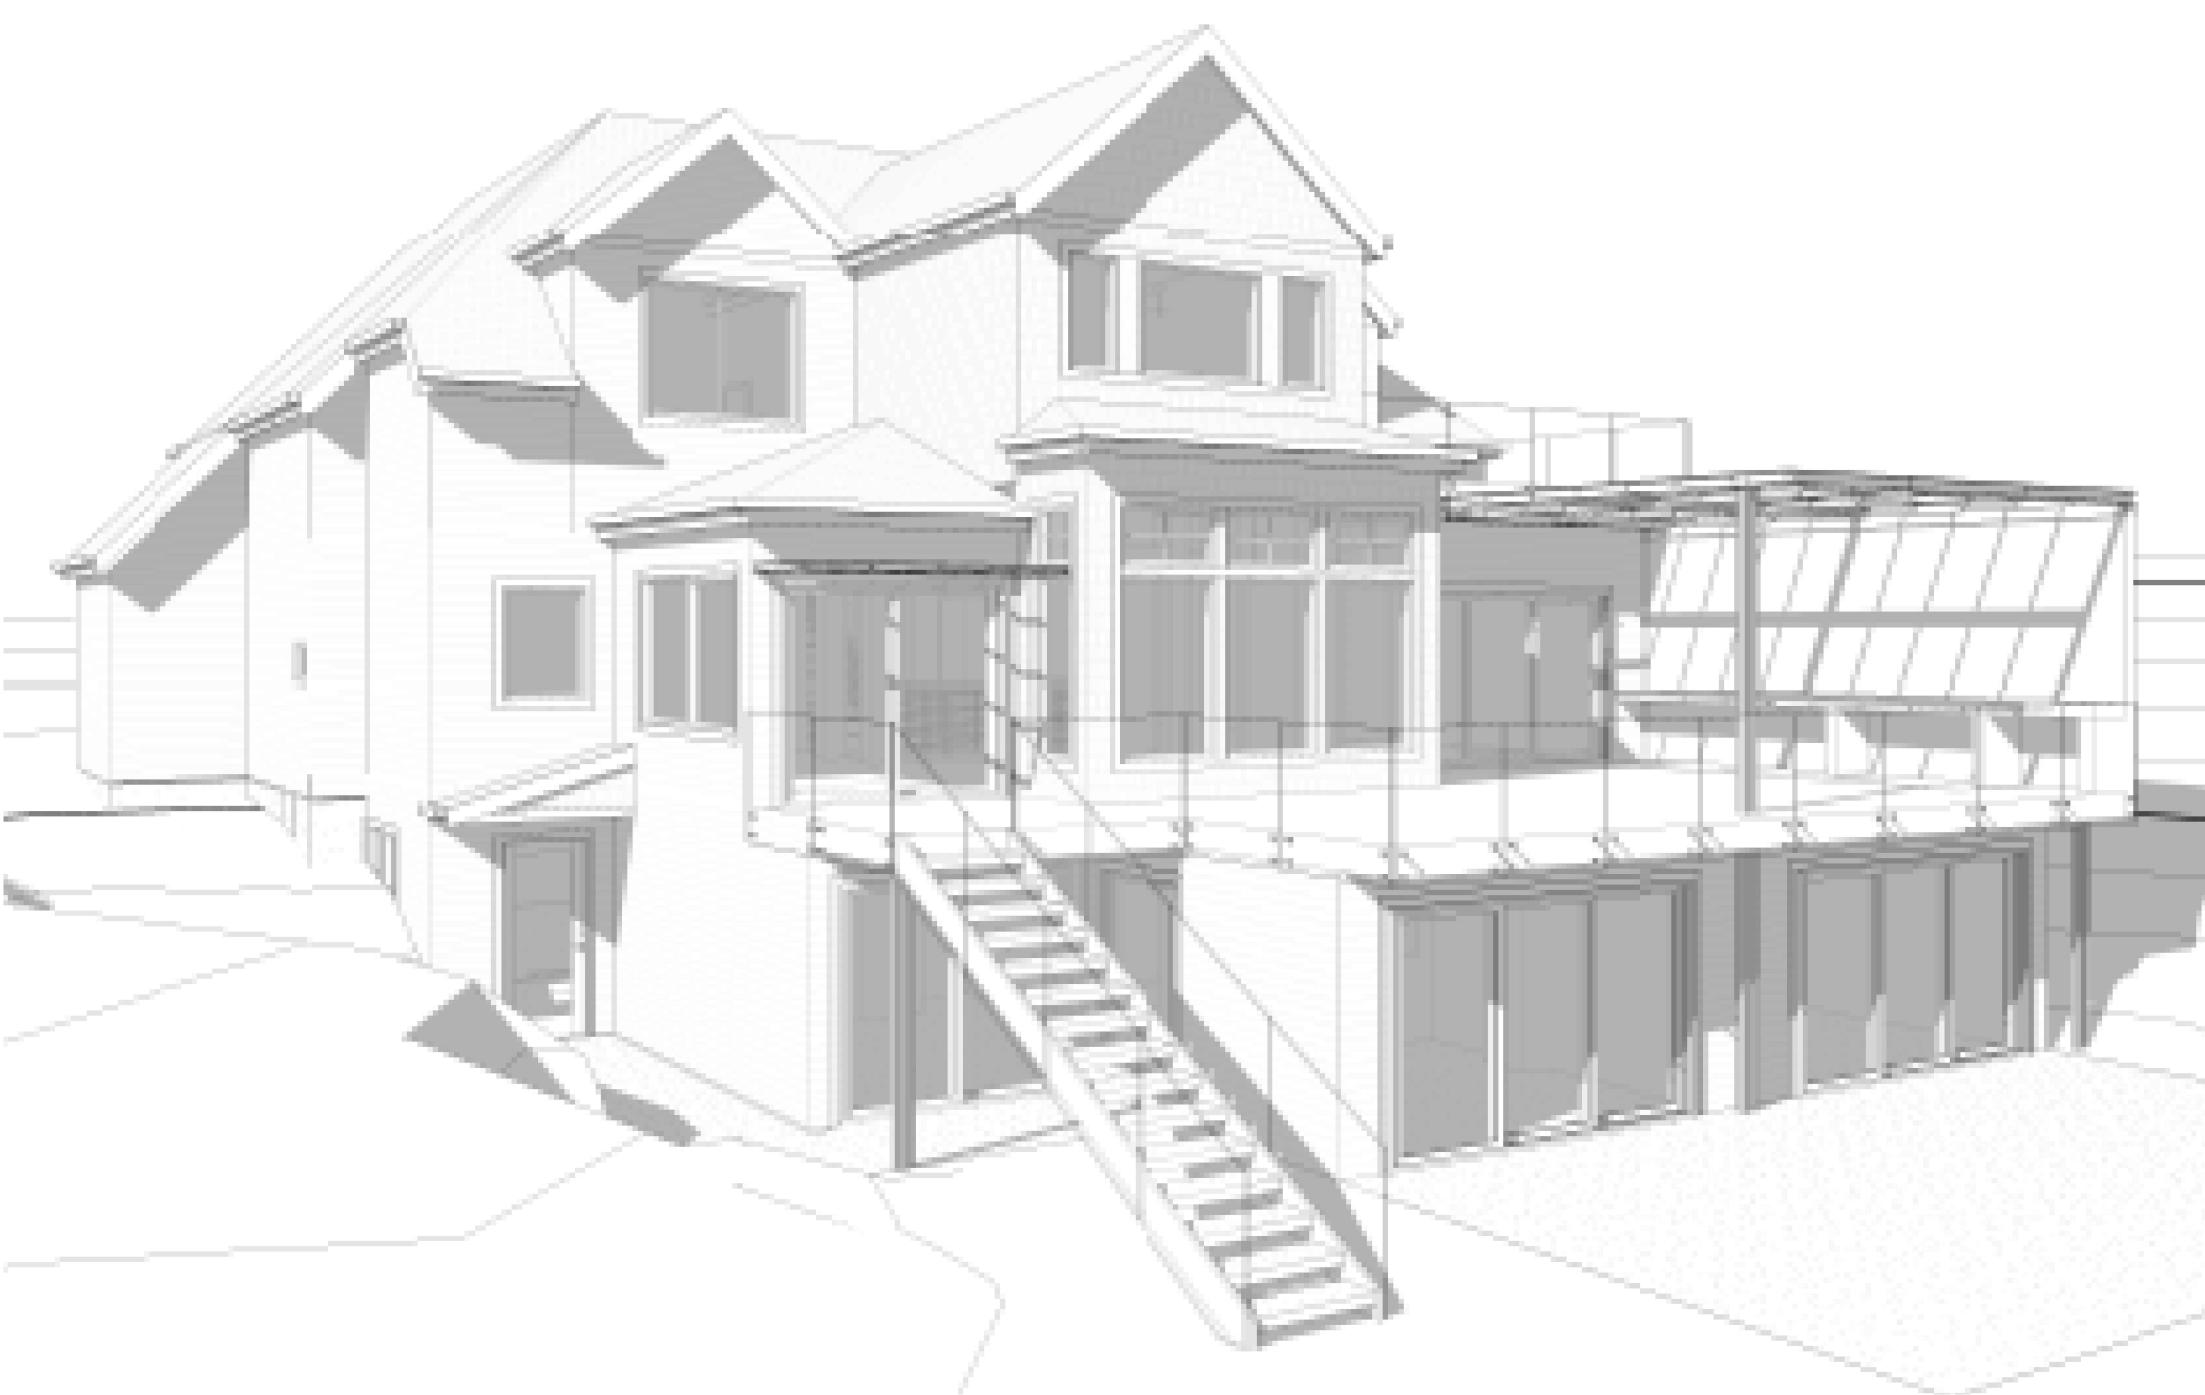
9820 SE 35TH PLACE MERCER ISLAND, WA. 98040



SEE SHEET A0.1

SEE SHEET A0.1

SEE SHEET A0.1

SEE SHEET A0.2

SEE SHEET A0.2

SEE SHEET A0.2

NOTE: 3D RENDERINGS ARE FOR ILLUSTRATIVE PURPOSES ONLY. NOT TO BE USED FOR CONSTRUCTION.

R9.6 BUILDING ZONE REQUREMENTS

LOT COVEREAGE: ALLOWED - 40% HARDSCAPE COVEREAGE: ALLOWED 9% + BORROWED AREA GROSS FLOOR AREA: ALLOWED 8,000 SQ. FT. A.B.E. AND MAX HEIGHT: NEW ADDITION AREA A.B.E. AND MAX HEIGHT: NEW DETACHED GARAGE ALLOWED STRUCTURAL DISTURBANCE: 40%

CODE INFORMATION

ALL MATERIALS, WORKMANSHIP. DESIGN AND CONSTRUCTION SHALL CONFORM TO THE DRAWINGS, SPECIFICATIONS, AND THE FOLLOWING APPLICABLE CODES USED IN THIS DESIGN FOR CITY OF MERCER ISLAND 2015 INTERNATIONAL BUILDING CODE (IBC) 2015 INTERNATIONAL RESIDENTIAL CODE (IRC) 2015 INTERNATIONAL MECHANICAL CODE (IMC) 2015 INTERNATIONAL FUEL GAS COZDE (IFGC) 2015 INTERNATIONAL FIRE CODE (IFC) WASHINGTON STATE ENERGY CODE, WAC 51-11 (WSEC)

2015 UNIFORM PLUMBING CODE (UPC)

2014 NATIONAL ELECTRIC CODE (NEC)

2015 NATIONAL FUEL GAS CODE (NFGC) NFPA 54, WAC

BUILDING CLASSIFICATION

A. OCCUPANCY CLASSIFICATION: SINGLE FAMILY RESIDENCE

B. TYPE OF CONSTRUCTION: 1. AUTOMATIC SPRINKLERS PROVIDED YES X NO SPRINKLER SYSTEM TO BE A FLOW THRU SYSTEM

THIS HOUSE HAS A FIRE ALARM SYSTEM INSTALLED.

ENERGY CODE COMPLIANCE

GENERAL PRESCRIPTIVE METHOD: SEE SHEETS A0.2, A0.3 & A5.0

ENERGY CREDITS PER TABLE 406.2.1: ADDITION TO EXISTING BUILDING GREATER THAN 500sf<1500sf

OPTION 5c EFFICIENT WATER HEATING 1.5 CREDITS - GAS WATER HEATER, MIN. EF 0.91

TOTAL CREDITS REQUIRED SMALL DU: 1.5 CREDITS TOTAL CREDITS PROPOSED: 1.5 CREDITS

ZONING & CODE INFORMATION

JURISDICTION: CITY OF MERCER ISLAND **ZONING:** PARCEL ASSESSOR'S #: 082405-9027

LEGAL DESCRIPTION:

LOT 1 TGW SH LDS ADJ MERCER ISLAND SHORT PLAT NO 82-11-26 REC NO 8303109004 - LESS POR THOF LY NLY AND WLY OF FOLG DESC LN --DIST OF 82.40 FT TO TPOB OF HEREIN DESC LN TH S 01-10-32 W 4.54 FT TH S 64-49-53 W 9.36 FT TH N 88-49-28 W 21.64 FT TH S 64-21-02 W 8.31 FT TH S 51-11-48 W 14.70 FT TH N 88-49-28 W 33.69 FT TO WEST LN OF SD LOT 1 AND THE TERMINUS OF HEREIN DESC LN AKA "LOT 1" OF MERCER ISLAND LOT LINE ADJUSTMENT NO SUB01-009 REC NO 20021125900027 LY IN STR 08-24-05

OCCUPANCY: SINGLE FAMILY

SETBACKS AT REMODEL / ADDITION:

NEW CONSTRUCTION:

REMODEL CHANGES ARE LESS THAN 40% OF THE EXTERIOR (SEE CALCULATION SHT) REFER TO PREVIOUS PERMIT #9908-047 APPROVED SITE PLAN 9-10-99

PER PRE-APPLICATION PREMIT #PRE20-038 EXISTING SETBACKS ARE VESTED 2 CAR DETACHED GARAGE-FRONT YARD: 20'-0"

2.0 IN NEW DETACHED GARAGE

SIDE YARD: 10'-0" PARKING REQUIRED: 2.0 PER DWELLING UNIT PARKING PROVIDED: 2.0 IN ATTACHED GARAGE

> ADDITION AND REMODEL TO SINGLE FAMILY RESIDENCE +

PROJECT CONTACT INFOMATION

MARY & ACHIH CHEN

9820 SE 35TH PLACE MERCER ISLAND, WA. 98040 P: 706-726-3333

DETACHED 2 CAR GARAGE

E: maryrwchen@yahoo.com

T.B.D. CONTRACTOR:

ARCHITECT:

MEDICI ARCHITECTS EMILY BUCHWALTER, AIA 11711 SE 8TH ST., SUITE 100 BELLEVUE, WA 98005

P: 425-453-9298 E: priscilla@mediciarchitects.com

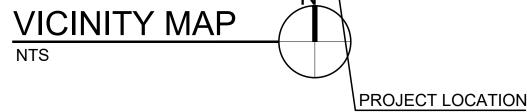
EVAN WAHLSTROM P. O. BOX 5137

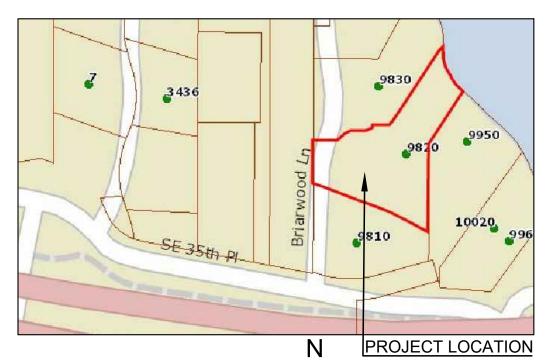
TACOMA, WA. 98415 P: 253-627-2070 E: ewahlstrom@i-landsurvey.com

GEOTECHNICAL ENGINEER: GEO GROUP NW

ADAM GASTON 13705 BEL-RED ROAD BELLEVUE, WA. 9005 P: 425-649-8757 E: agaston@geogroupnw.com







DRAWING SHEET INDEX

QT. SECT. MAP

CITY OFMERCER ISLAND COVER SHEET TITLE SHEET A0.1.0 SITE PLAN

SITE PLAN CALCULATIONS **GENERAL NOTES** SCHEDULES **DEMOLITION PLANS** FOUNDATION PLAN A1.1 BASEMENT PLAN

A2.0 1ST FLOOR CONSTRUCTION PLAN A2.1 2ND FLOOR CONSTRUCTION PLAN A3.0 **ROOF PLAN** A4.0-A4.1 **ELEVATIONS** A5.0 SECTIONS

DETAILS DETACHED GARAGE FLOOR & ROOF PLAN

TESC DETAILS C2.0 DRAINAGE / CIVIL PLAN C3.5 BMP DETAILS

SURVEY: TOPOGRAPHIC SURVEY INCLUDED

CONSTRUCTION DOCUMENTS

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DRAWING NAME:

TITLE SHEET

Drawn By: JMG,RB

Checked By: EB

Owner Approval:

MEDICI ARCHITECTS

DATE:

DATE:

ARCHITECTURE I PROGRAMMING

www.mediciarchitects.com

11711 SE 8TH STREET, SUITE 100

BELLEVUE, WA 98005

TEL: (425) 453-9298

REGISTRATION:

INTAKE:

REVISIONS

PROJECT / CLIENT:

ACHIN & MARY CHEN

9820 SE 35TH PLACE

9820 SE 35TH PLACE

PARCEL # 082405-9027

JOB ADDRESS:

9820 SE 35TH PLACE

MERCER ISLAND, WA 98040

MERCER ISLAND, WA 98040

ACCESSIBLE DESIGN | INTERIOR DESIGN

APPROVED FOR CONSTRUCTION:

PROJECT No.: 2020 007

12-22-2020

A7.1 **DETACHED GARAGE ELEVATIONS** STRUCTURAL ENGINEER: FOSSATTI PAWLAK STRUCTURAL ENGINEERS PETE PAWLAK 1735 WESTLAKE AVE N., SUITE 205 SEATTLE, WA 98109 STRUCTURAL SHEET INDEX P: 206-456-3071 E: ppawlak@fossatti.com S2.1 FOUNDATION PLAN S2.2 1ST FLOOR FRAMING PLAN **CIVIL ENGINEER:** CIVIL ENGINEERING SOLUTIONS NO EXCAVATION BEYOND FOUNDATIONS S2.3 2ND FLOOT FRAMING PLAN ELLIS DUFFY, PE S2.4 102 NW CANAL STREET ROOF FRAMING PLAN CALL 48 HOURS SEATTLE, WA. 98107 S3.1 CONCRETE DETAILS BEFORE YOU DIG P: 206-930-0342 S4.1 SECTIONS 811 OR 1-800-424-5555 E: duffy@cesolutions.us S4.2 SECTIONS ARBORIST: OLYMPIC NURSERY, INC. TOM QUIGLEY **CIVIL SHEET INDEX** ISA CERTIFIED ARBORIST PN0655A **EROSION CONTROL PLAN** P: 206-850-2643 E: tlquigley@msn.com TREE RETENTION PLAN C1.2 TESC & CITY NOTES SURVEYOR: INFORMED LAND SURVEY

DEFERRED SUBMITTAL:

THE FOLLOWING ITEMS ARE CONSIDERED TO BE A DEFERRED SUBMITTAL UNDER SECTION 107.3.4.1 OF THE IBC AND MUST BE SUBMITTED TO THE ENGINEER FOR REVIEW. THESE ITEMS WILL THEN BE FORWARDED TO THE BUILDING OFFICIAL FOR APPROVAL. THE DEFERRED SUBMITTAL ITEMS SHALL NOT BE INSTALLED UNTIL THE DESIGN AND SUBMITTAL DOCUMENTS HAVE BEEN APPROVED BY THE BUILDING OFFICIAL *PRE-ENGINEERED INTERIOR STEEL STAIRS, HANDRAILS, BALCONY GUARDS, EXTERIOR STEEL STAIRS, STEEL FRAME CANOPY. ELECTRICAL, MECHANICAL AND PLUMBING.

DATE:

TREE PROTECTION GUIDELINES

All remaining trees are to have a tree protection zone (TPZ) established before commencement of any construction or delivery activities. The following guidelines are to be observed and practiced during all construction activities.

- Access is to be restricted into TPZ's with readily visible temporary tree fencing along the LOD which completely surrounds the protected areas of retained trees. Fences shall be constructed of chain link and be at least 4 ft tall, constructed using pier block, and
- major roots should be avoided while staking. • Highly visible signs spaced no further than 15 feet shall be placed along sides of the TPZ fencing.
- Construction materials or supplies, soil, debris, vehicles, and equipment are not to be parked or stored within TPZ.
- TPZ fences must be inspected prior to the beginning of any construction activities.
- Assess crew and contractor penalties, if necessary, to keep the TPZ's intact.
- Check the integrity of TPZ fences weekly, and repair or replace as Wood chips should be used if possible to spread above root zones
- within the TPZ's to a depth of 6-8 inches for temporary protection.
- Cement trucks must not deposit waste or rinse out trucks in the TPZ.

Avoid grade changes or trenching within or near the TPZ. If it is

- unavoidable, then follow the guidelines below. TPZ's may only be moved or accessed with permission from City Officials, and any work done within TPZ's must be done with a
- certified arborist present. • If roots need to pruned, they should be cut with pruning saws, made
- flush with the side of the trench.
- Trees should be watered twice a week if construction is to take place during hot summer months.

If excavation occurs within the driplines of trees scheduled for retention, the following procedures must be followed to protect **LOT COVERAGE**

EXISTING LOT COVERAGE

NEW LOT COVERAGE

HARDSCAPE COVERAGE

EXISTING HARDSCAPE COVERAGE

NEW HARDSCAPE COVERAGE

GROSS LOT COVERAGE CHANGE

539

728

1267

1062

314

1376

SF

SF

LOT COVEREAGE ZONE % - RS 9.6 <15%

MAIN STRUCTURE ROOF AREA

TOTAL EXISTING LOT COVERAGE

MAIN STRUCTURE ROOF AREA

COVERED PATIOS/DECKS

TOTAL LOT COVERAGE AREA

BORROWED FROM LOT COVEREAGE

HARDSCAPE AREA ALLOWED = 9%+

% HARDSCAPE AREA ALLLOWED

ROCKERIES/RETAINING WALLS

HARDSCAPE AREAS REMOVED

TOTAL NEW HARDSCAPE COVERAGE

TOTAL HARDSCAPE AREA

GROSS LOT COVERAGE %

EXISTING LOT COVERAGE

EXISTING HARDSCAPE COVERAGE

REMOVED EXIST. LOT COVERAGE

REMOVED EXIST. HARDSCAPE

TOTAL REMOVED COVERAGE

NEW HARDSCAPE COVERAGE

NET GROSS COVEREAGE CHANGED

TOTAL NEW COVERAGE

NEW LOT COVERAGE

TOTAL EXISTING GROSS COVERAGE

TOTAL HARDSCAPE %

HARDSCAPE COVERAGE

UNCOVERED DECKS

UNCOVERED PATIOS

DOCK PATH

STAIRS

NEW LOT COVERAGE

BORROWED AREA

UNCOVERED DECKS

UNCOVERED PATIOS

WALKWAYS

EXISTING LOT COVERAGE REMOVED

ACCESSORY STRUCTURE ROOF AREA

LOT SIZE

SLOPE - 40%

VEHICULAR USE

VEHICULAR USE

LOT SIZE

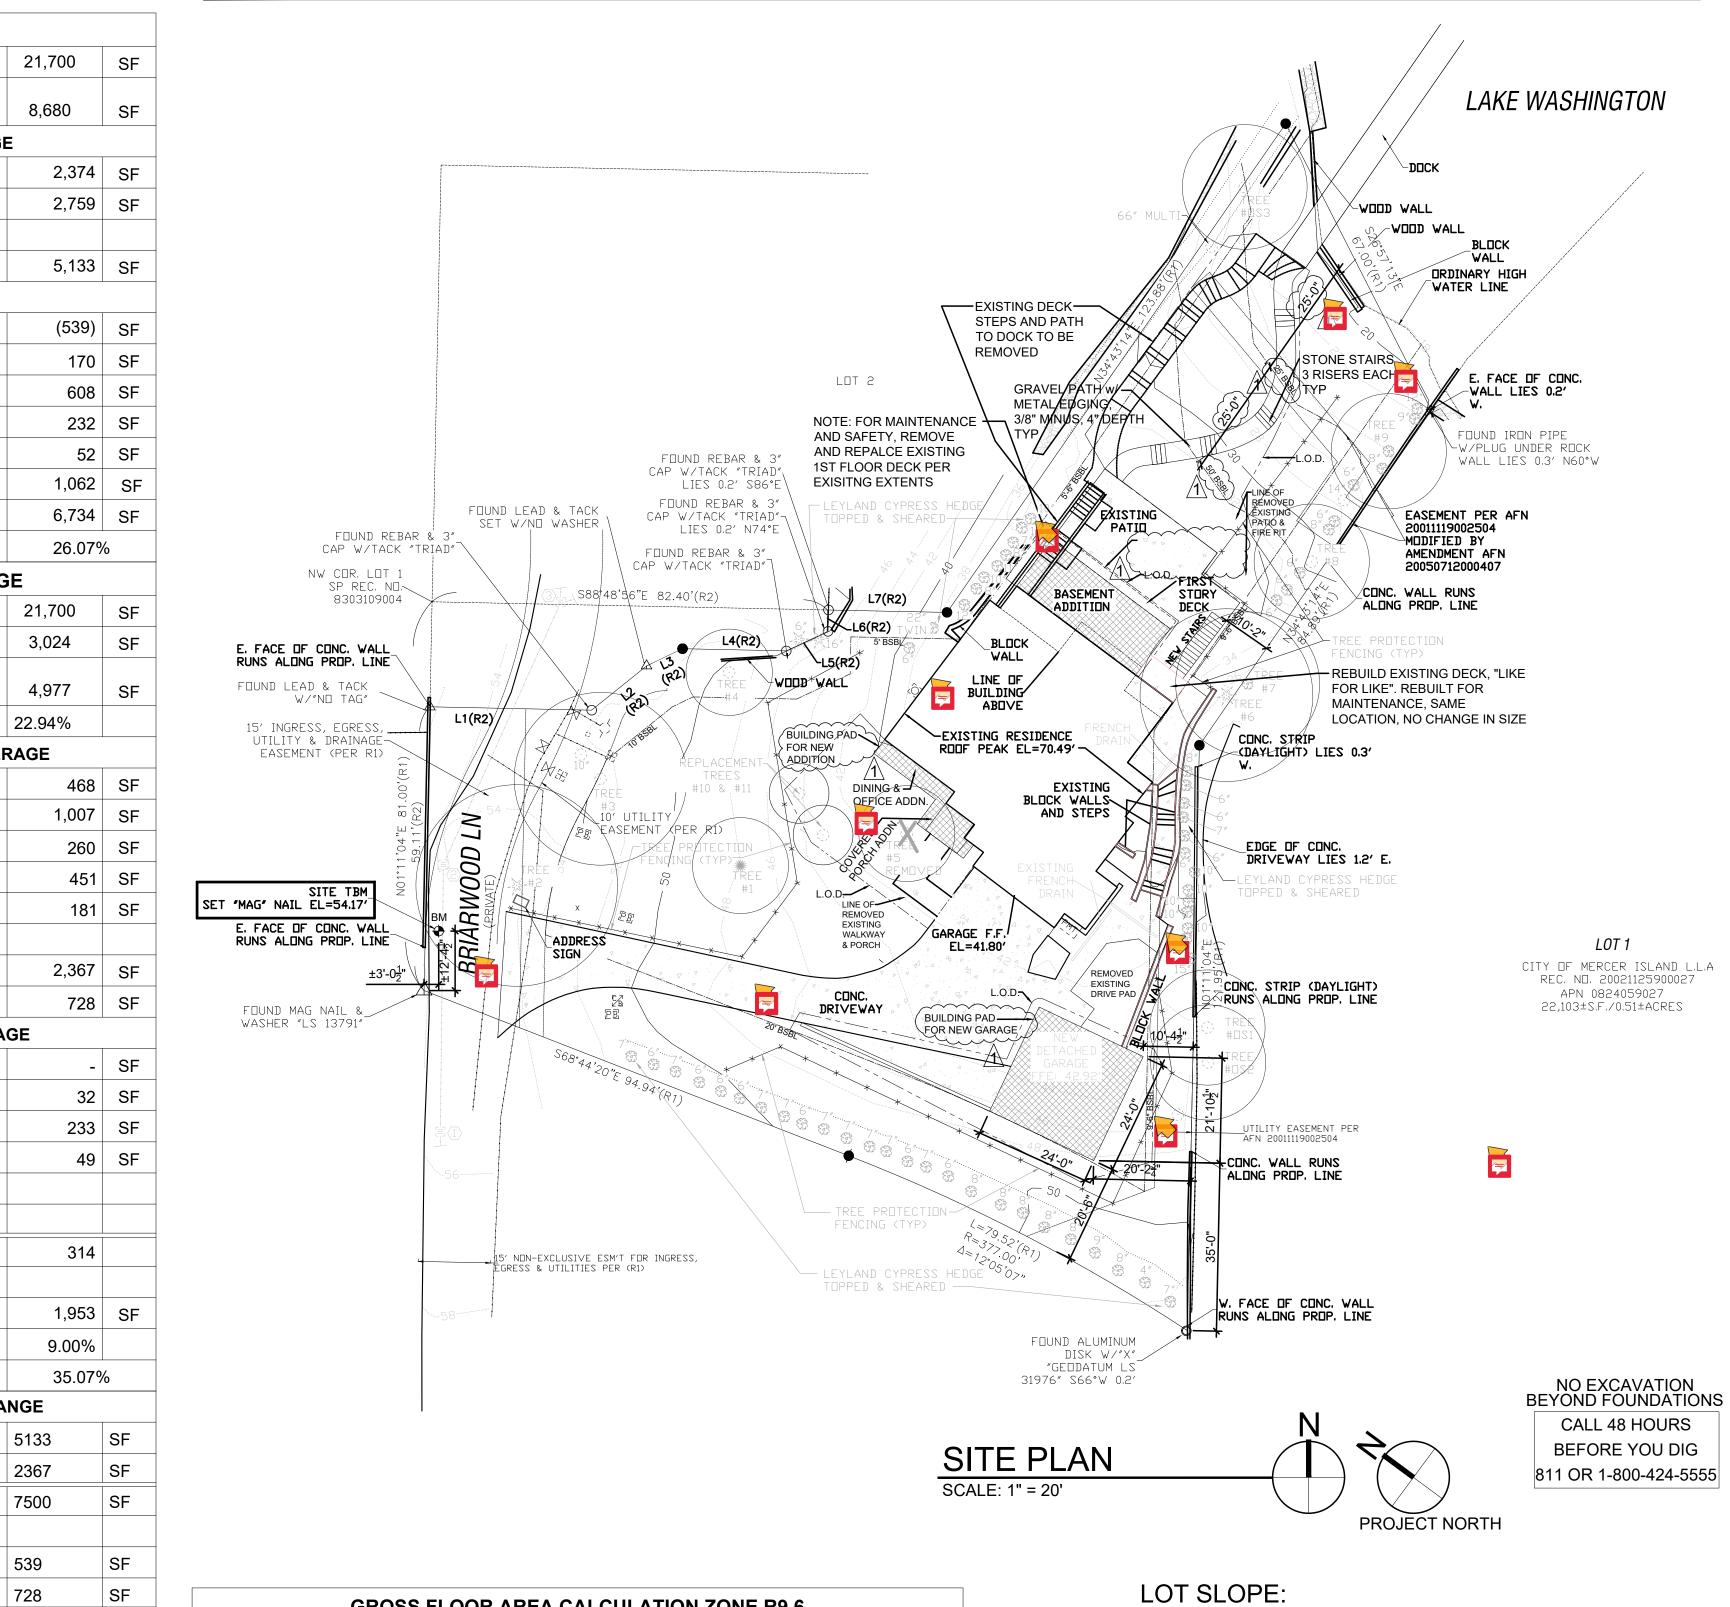
 The contractor shall verify the vertical and horizontal location of existing utilities to avoid conflicts and maintain minimum clearances; adjustment shall be made to the grade of the new utility as required.

• The inner root zone shall not be disturbed or cut (inner root zone =

- half the drip line radius). ISA Certified arborist must work with equipment operators during trenching/ excavation. The Arborist should have a shovel, hand
- pruners, loppers, handsaw, and a sawsall. If roots one inch or larger are damaged by equipment, the Arborist shall stop the equipment and have the dirt excavated by hand until the root can be cleanly cut. A clean straight cut shall be made to remove the damaged portion of root, and if possible the roots should
- be covered in moist burlap until recovered with dirt the same day. Boring or tunneling under roots of existing trees is a viable alternative to trenching through roots. It shall be performed under the supervision of an ISA Certified Arborist, and no roots 1 inch in diameter or larger shall be cut.
- The grade shall not be elevated or reduced within the critical root zone of trees to be preserved without the Planning Official's authorization based on recommendations from a qualified professional. The Planning Official may allow coverage of up to one half of the area of the tree's critical root zone with light soils (no clay) to the minimum depth necessary to carry out grading or landscaping plans, if it will not imperil the survival of the tree. Aeration devices may be required to ensure the tree's survival.

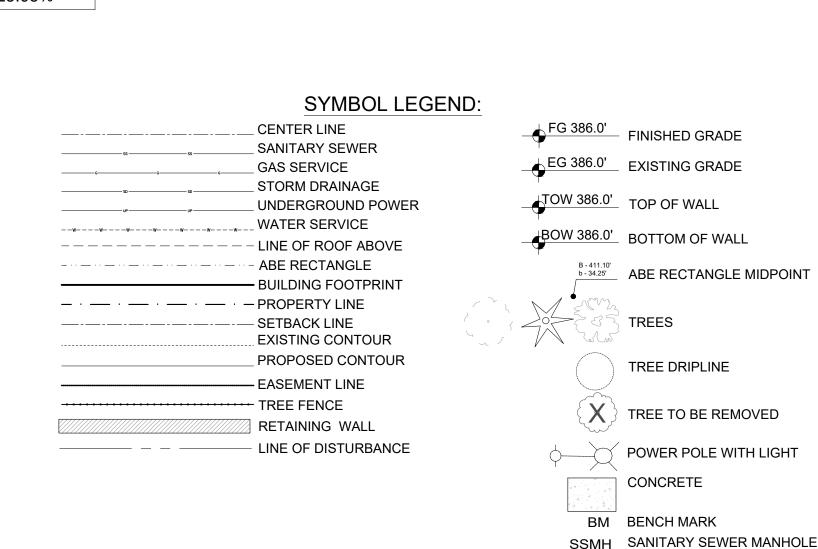
EXISTING ON-SITE 1	REES	RETAIN	REMOVE	DBH	CREDIT
TREE #1	FLOWERING CHERRY	Х		12"	2
TREE #2	Cedrus Atlantica, Atlas Cedar	Х		29.5"	10
TREE #3	Quercus, Pin Oak	Х		24.8"	8
TREE #4	Acer palmatum, Japanese Maple	Х		12.5"	2
TREE #5	Acer palmatum, Japanese Maple		Х	11.0"	1
TREE #6	Cedrus Atlantica, Atlas Cedar	Х		26.0"	9
TREE #7	Acer Macrophyllum, Big Leaf Maple	Х		17.4"	4
TREE #8	Fraxines, Ash	Х		21.0"	6
TREE #9	Fraxines, Ash	Х		14.0"	3
NEW TREES TO REF	PLACE REMOVED				
TREE #10	Amelanchier Alnifolia, Western Serviceberry	X (NEW) REPLACEME NT		2"	
TREE #11	Amelanchier Alnifolia, Western Serviceberry	X (NEW) REPLACEME NT		2"	
EXISTING OFF-SITE	TREES w/ OVERHANGING LIMBS				
TREE # OS 1	Cuppreseocyparis Leylandii, Layland	x		est 18"	
TREE # OS 2	Cuppreseocyparis Leylandii, Layland	х		est 21"	
TREE # OS 3	Populus Nigra, Black Cottonwood	Х		est 44"	
TOTAL CREDITS PROPOSE					45
LOT SIZE				0.50	ACRES
TREES PER ACRE	PER KZC 95.33			30.0	
TOTAL CREDITS REQUIRED				1	5.0

9820 SE 35TH PLACE, MERCER ISLAND, WA. 98040



GR	OSS FLOOF	R AREA CALCULATI	ON ZONE R9.6	
(FRC	M OUTSIDE	PERIMETER OF THE E	XTERIOR WALLS)	
FLOOR	EXIST. AREA	REMOVED AREA	NEW/ADD AREA	TOTAL
UPPER FLOOR	1,430		100	1,530
MAIN FLOOR	1,677		67	1,744
GROSS BASEMENT AREA	1,290	681	380	989
GARAGE	505			505
STAIR CASE GFA MODIFIER			92	92
TOTAL BUILDING AREA	4,902	681	639	4,860
ACCESSORY BUILDING			576	576
LOT AREA	ZONE	ALLOWED GROSS FLOOR AREA (SF)	ALLOWED GROSS FLOOR AREA (%)	
21,700	R9.6	8,000	36.87%	
PROPOSED GROSS FL	OOR AREA S	QUARE FOOTAGE;		5,436
PROPOSED GROSS FL	OOR AREA F	PERCENTAGE:		25.05%

FIRE A	REA CALC	ULATION	
(FROM INSIDE PERI	METER OF T	HE EXTERIOR	R WALLS)
AREA			SQ. FTG.
BASEMENT			1,623
st FLOOR			1,663
2nd FLOOR			1,756
ATTACHED GRAGE			486
COVERED PORCH			64
COVERED DECKS			363
COVERED PATIO			126
ΓΟΤΑL FIRE SF:			6,081



S 88° 52' 32" E 296.84' BEARING

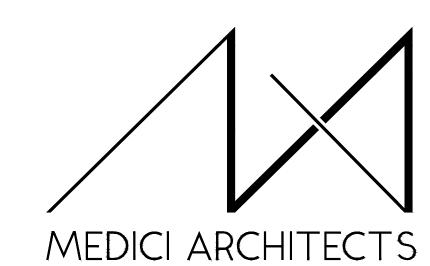
HIGHEST ELEVATION POINT OF LOT:

LOWEST ELEVATION POINT OF LOT:

HORIZONTAL DISTANCE BETWEEN POINTS: 254.7 FEET

ELEVATION DIFFERENCE:

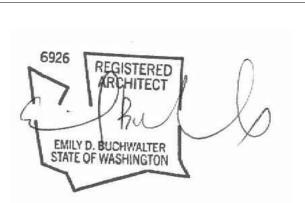
LOT SLOPE: 14.3%



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REGISTRATION:



INTAKE:	DATE:
REVISIONS:	DATE:
1. Robin Proebsting comments	12-04-20
2.	
3.	
4.	
5.	

9820 SE 35TH PLACE

PROJECT / CLIENT:

ACHIN & MARY CHEN MERCER ISLAND, WA 98040

JOB ADDRESS: 9820 SE 35TH PLACE MERCER ISLAND, WA 98040 PARCEL # 082405-9027

DRAWING NAME:

54.4 FEET

18.0 FEET

36.4 FEET

SITE PLAN

Drawn By: JMG,RB Checked By: EB Owner Approval:

CONSTRUCTION DOCUMENTS

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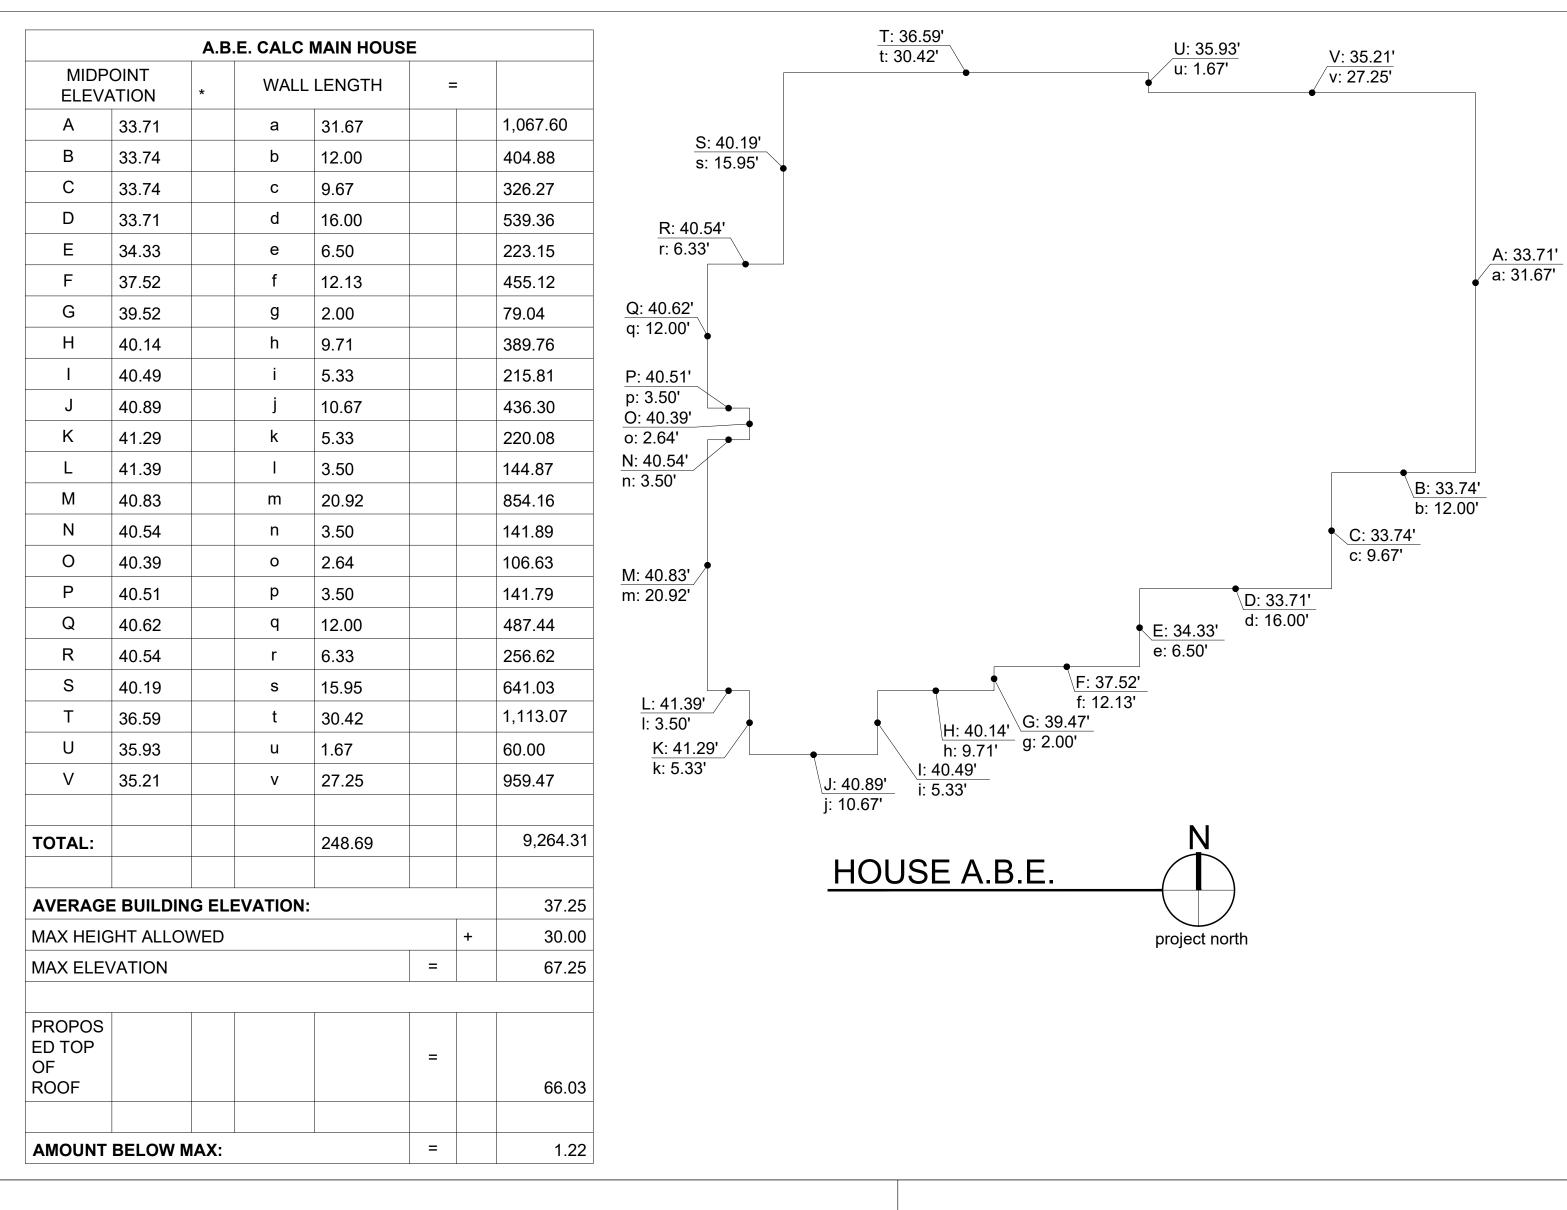
PROJECT No.: 2020 007

12-22-2020

DATE:

9820 SE 35TH PLACE, MERCER ISLAND, WA. 98040

WALL



1,808 SF

EAST ELEVATION

WEST ELEVATION

656 SF

492 SF

1,355 SF

1,848 SF

NORTH ELEVATION

SOUTH ELEVATION

NORTH ELEVATION

EAST ELEVATION

SOUTH ELEVATION WEST ELEVATION

ALTERED EXTERIOR AREA

304 SF

40% EXTERIOR STRUCTURAL THRESHOLD:

ALL EXTERIOR SURFACE AREA 6,931 SF X 40%=2,772.4 SF

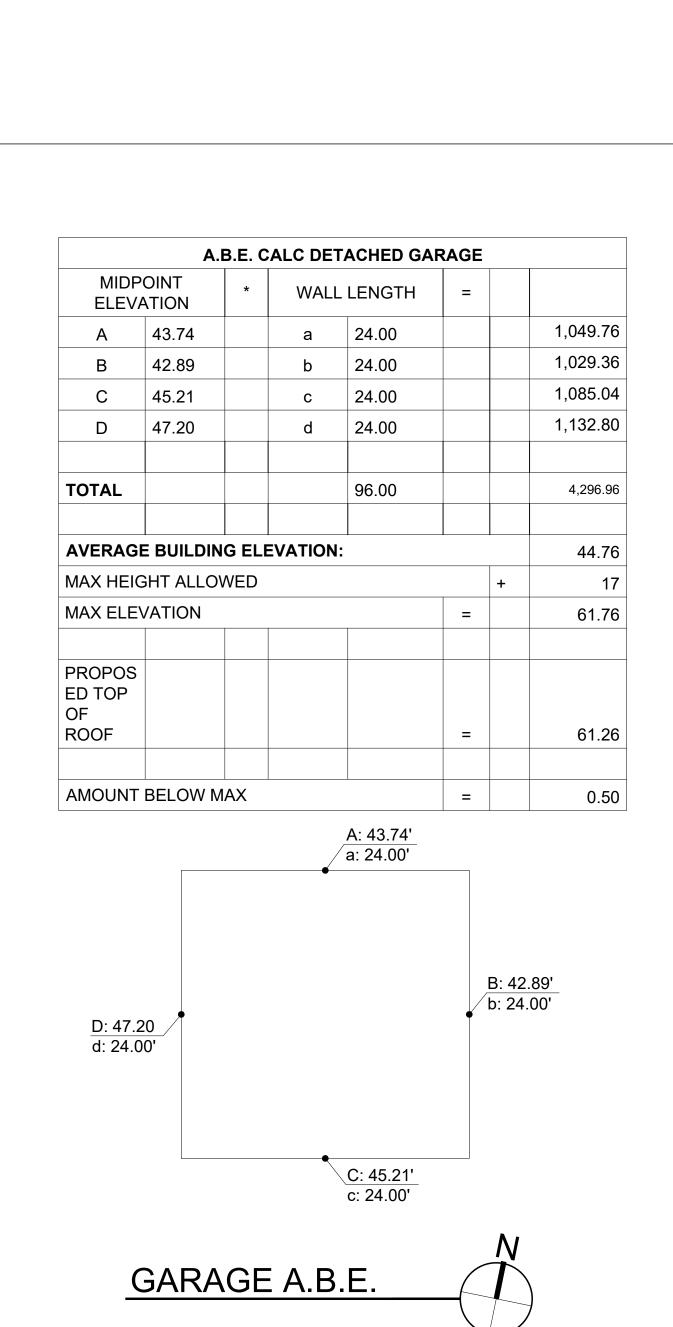
STRUCTURAL DISTURBANCE

639.0 SF 492.0 SF 304.0 SF

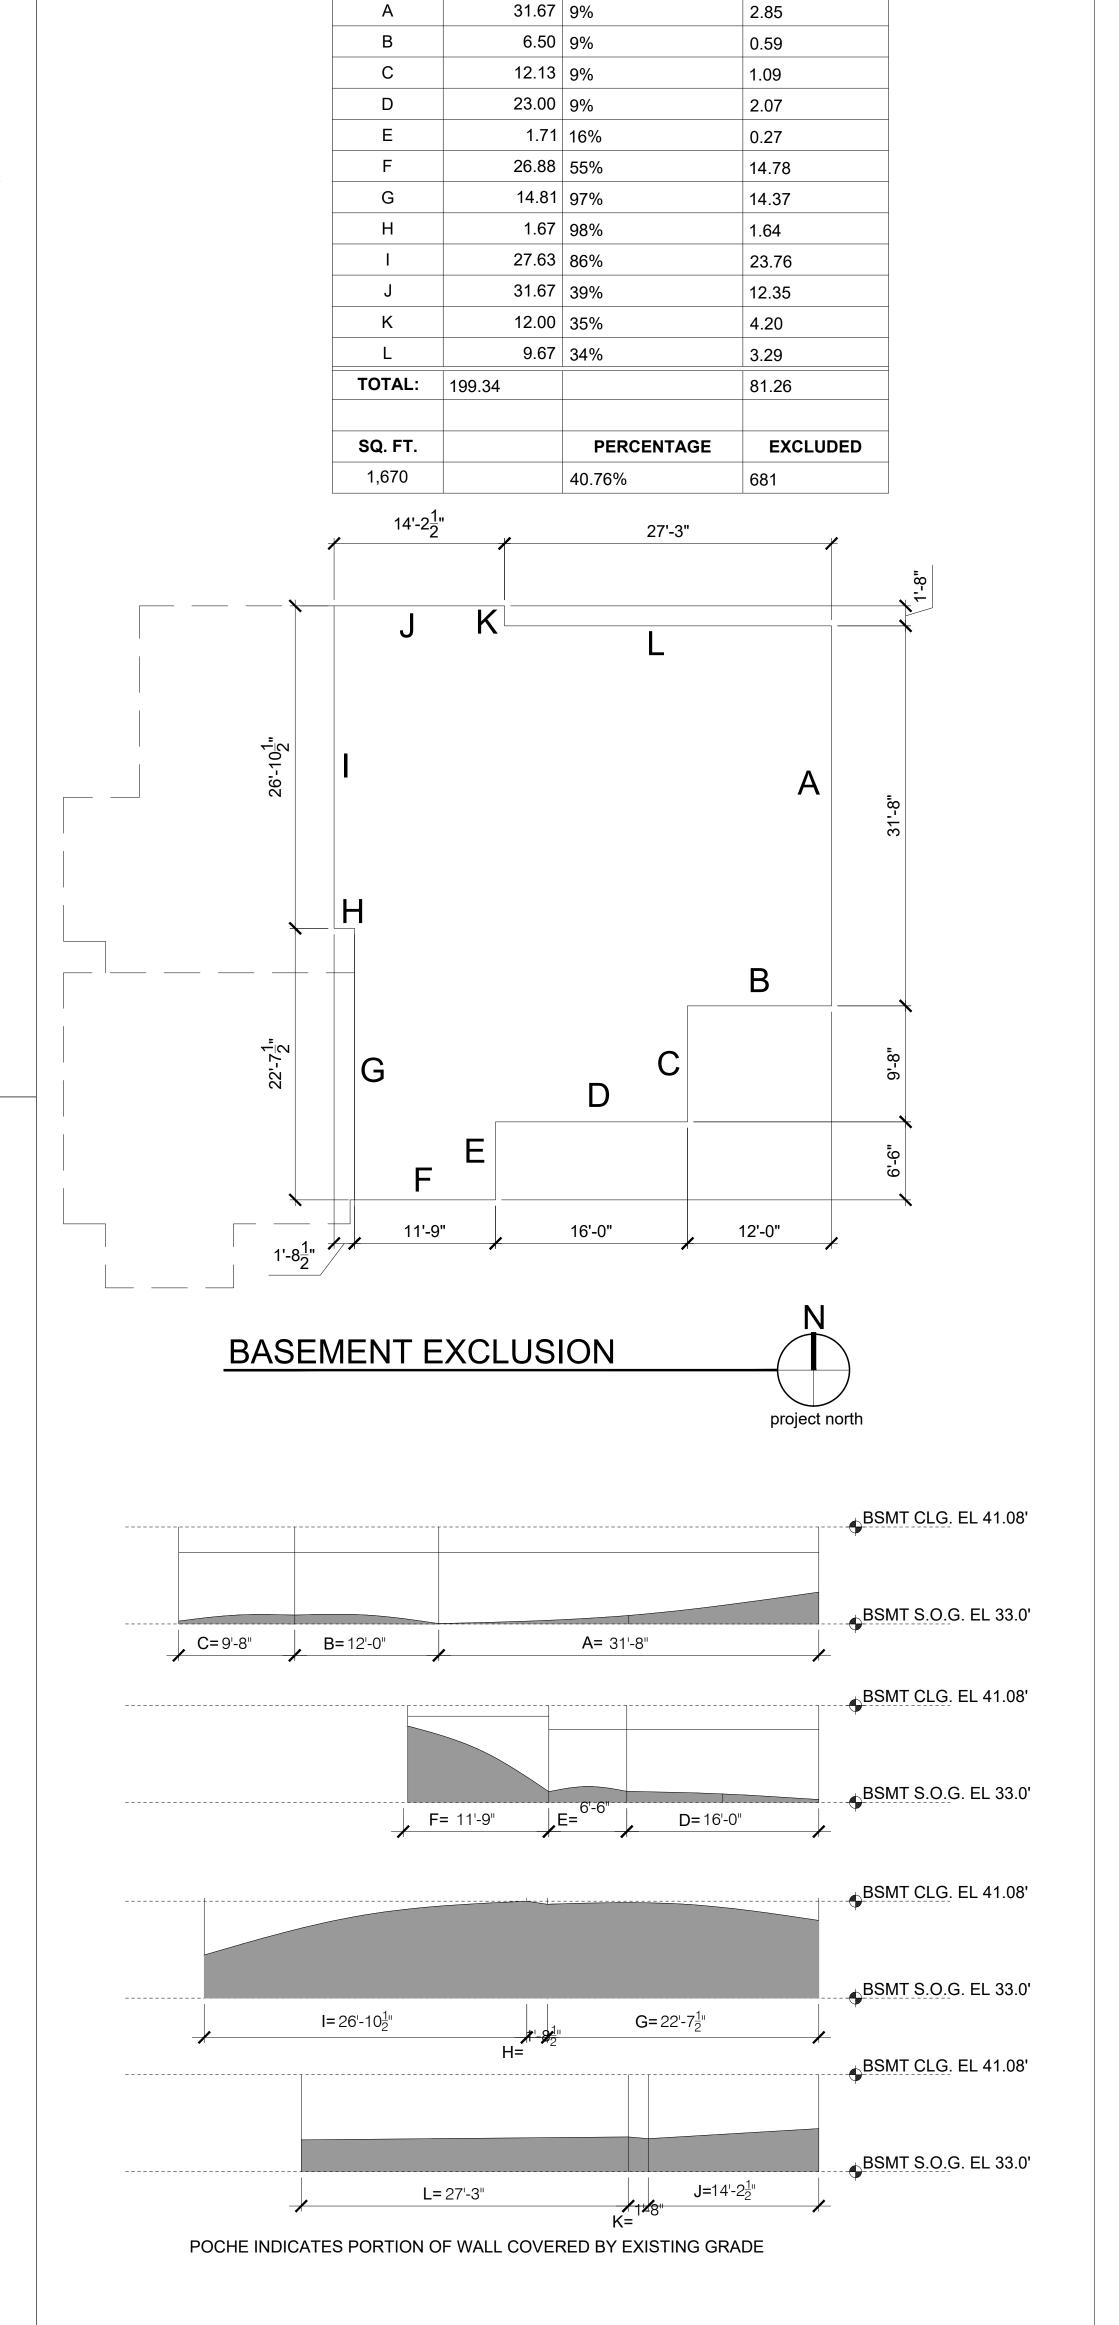
2,091.0 SF < 2,772.4 SF

1,920 SF

639 SF



project north



BASEMENT FLOOR AREA EXCLUSION

COVERAGE

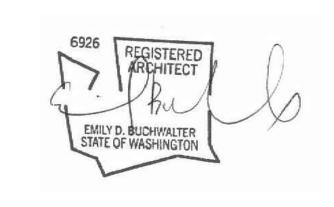
RESULT



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REGISTRATION:



INTAKE:	DATE
REVISIONS:	DATE
1.	
2.	
3.	
4.	
5.	

9820 SE 35TH PLACE ACHIN & MARY CHEN

PROJECT / CLIENT:

9820 SE 35TH PLACE
MERCER ISLAND, WA 98040

JOB ADDRESS:

9820 SE 35TH PLACE MERCER ISLAND, WA 98040 PARCEL # 082405-9027

DRAWING NAME:

SITE PLAN

CALCULATIONS

Drawn By: JMG,RB

Checked By: EB

Owner Approval:

CONSTRUCTION DOCUMENTS

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APPROVED FOR CONSTRUCTION:

PROJECT No.: 2020 007

DATE: 12-22-2020

The General Contractor shall review the Construction Documents to complete the Work and notify the Architect of resolution for all discrepancies between architectural drawings and structural drawings prior to construction.

DO NOT SCALE DRAWINGS - notify Architect of dimensions in question.

The General Contractor is responsible for checking and reviewing the Building Department approved set of Construction Documents. The Architect shall be promptly notified of required changes; at that time, the Architect will initiate appropriate action.

The General Contractor is responsible for disseminating all information contained in the Drawings, Specifications and Bid Documents to each Subcontractor.

INSTALLATION OF MATERIALS:

All products in the Drawings or Interior Specifications shall be installed in strict accordance with the manufacturer's current published instructions. Manufacturer's instructions in conflict with the Contract Documents shall be brought to the attention of the Architect prior to commencement of the work. Products not provided with installation instructions shall be installed in accordance with the best trade practices of the industry. In any case, workers experienced and skilled in the installation of these items shall install all products.

APPROVAL OF SUBSTITUTIONS:

The General Contractor shall support substitution requests for specified materials with complete data, drawings and samples as necessary for review by the Architect and Owner. Allow time for investigation before a decision must be made. When the Architect approves a substitution, it is with the understanding that the General Contractor guarantees the substituted article to be equal or better than the one specified. Any changes to the Contract shall be done by Change Order.

DIVISION 2 - SITE WORK:

The General Contractor shall verify all dimensions and conditions before proceeding. Any variation from the Drawings and dimension discrepancies shall be brought to the attention of the Architect. Prior to any field changes there must be approval from the Architect.

SITE EXCAVATION, BACKFILL, AND FINISH GRADING:

Excavation site to grades as shown on Drawings (notify Architect of any deviations). Remove all excess material from site. Do not assume on-site material acceptable for backfill. Place washed gravel as shown. Provide compact fill under slabs per structural engineers specifications. Finish-grade site for lawn.

Provide new concrete as indicated on Drawings. Prepare grade, fill, and compact any soft areas. Place 4" paving over 2" crushed rock and slope to drains as indicated on SITE PLAN, Sheet A0.0.

Relocate existing utilities as required to accommodate new residence as indicated on Drawings. Coordinate disconnection of utilities with Owner & City of Mercer Island. The side sewer must be capped in the presence of a Utility inspector. Contact City of Mercer Island Utilities. The capping must be at the property line; or at the sewer main if on the property. Any test tees must be removed. A Side Sewer Permit is required for reconnection. A Water Service Application is required to upgrade existing meter

Connect all downspouts to storm system per civil drawings. Small Project Type II Option 4. Permeable Pavers.

DIVISION 3 - CONCRETE:

Patch rock packets when above grade with sack finish. See STRUCTURAL GENERAL NOTES for supplemental

CAST-IN-PLACE ARCHITECTURAL CONCRETE: All concrete shall be mixed, proportioned conveyed, and placed in accordance with IRC Sections R402.2 and R403. Provide new concrete patio and walkway with control joints as indicated on Drawings. Prepare grade, fill, and compact and soft areas. Pour 4" concrete slab-on-grade with #4 bars at 18" o.c. each way over 2" crushed rock and slope to drains as indicated. Finish shall be exposed aggregate.

DIVISION 4 - MASONRY: Color & style to be selected by owner. Construct brick veneer per IRC 606.

DIVISION 5 - METALS:

Custom-fabricated metal items including exterior and interior railings and handrails to be approved by Owner and Architect, installed by Contractor. All exposed structural metal connectors to be powder coated, unless noted

Provide neoprene gasket at all dissimilar metal connections, typ. Structural steel and metal fabrication refer to and comply with structural engineering notes, specification and drawings. Provide shop drawings showing details of fabrication, assembly and installation including templates for anchor bolt placement. Grind smooth exposed welds. Steel Finishes:

Exterior steel unless noted otherwise - Galvanized, including all bolts, nuts and washers. Interior Steel - See shop

DIVISION 6 - WOODS & PLASTICS:

Refer to and comply with structural engineering notes, specification and drawings. Provide blocking for plumbing fixtures, bath accessories and electrical devices. Per R317.4 Wood/plastic composites used in exterior deck boards, stairs treads, handrails and guard rail systems shall bear a label indicating the required performance levels and demonstrating compliance with the provisions of ASTM D 7032.

TREATED WOOD:

Pressure treated lumber and plywood with water-born preservatives for wood to masonry, wood to structural steel contact and as specifically noted in the drawings. Structurally glued laminated units: refer to and comply with structural engineering notes, specification and drawings. Seal all surfaces, including cut ends and drilled bolt holes prior to placing members. All exposed to weather units to be treated.

FINISH CARPENTRY: Comply with AWI quality standards "custom", unless indicated otherwise. Use only seasoned lumber. Conceal fasteners wherever possible, except where exposed fasteners are show. Hot-Dip galvanized or stainless steel fasteners for work exposed to exterior and high humidity. Install exterior trim with minimal possible number of joints. Center joints over vertical members wherever possible. Stagger joints in adjacent related members. Coping to return, miter at corners to produce tight fitting joints. Use scarf joints for end to end joints, install with flush appearance. Kerf backs as required to avoid warping. Hand select lumber for interior trim of similar grain and

coloration. Pre-stain seal and finish per owner.

STAIRWAY CONSTRUCTION: Construct all stairs in accordance with IRC Section R311.7, and as detailed on the drawings.

Install fire blocking in wall/ceiling line of concealed soffit spaces and 10-foot intervals both vertical and horizontal, per IRC Section R302.11.

DRAFTSTOPS:

Install draftstops (in common walls separating living units and attics) per IRC Section R302.12.

Install dwelling unit rated penetrations per IRC R302.4.

DIVISION 7 - THERMAL & MOISTURE PROTECTION:

FOUNDATION WALL DAMPROOFING: Apply asphaltic emulsion to all below-grade foundation walls. All below-grade foundation walls greater than 48" high shall also be protected with drainage matting (Mirrodrain, Delta-Drain, Enkadrain, or approved equal).

FOUNDATION WALL WATERPROOFING:

MOISTURE CONTROL: Per WSEC R301.7

All below-grade foundation walls to be sprayed with Graywall waterproofing by Rubber Polymer Corporation. The membrane shall be applied to a minimum thickness of 40-mils to exterior surfaces which are clean and dry, and the ambient air temperature is 15° F or above. Fill honeycombed areas, cracks, and tie-holes with non-shrinking grout before applying the membrane.

All foundation walls greater than 48" high (below grade) shall also be protected by Delta-Drain dampproofing membrane by Cosella-Dorken Products, Inc. Supply all system components including Delta-MS sheet barrier, Delta termination bar, Delta molding strip, Delta plug-and-nail, and all applicable sealants.

THERMAL INSULATION: (per WSEC 2015 table R402.1.1 1 & 402.1.3, Refer to table footnotes for additional information)

Fenestration U-Factor Skylight U-Factor Glazed Fenestration SGHC NR

Ceiling R-Value 38 single rafter/joist ceiling 49 @ truss framing & attics Wood Frame Wall R-Value 21 standard framing @ 16" o.c., R-10 min. @ headers, typ.

Mass Wall R-Value 21 / 21 Floor R-Value Below Grade Wall R-Value

21 int (furred wall standard framing @ 16" o.c., + Thermal Break between slab and basement wall.) Slab R-Value & Depth (For heated slabs, insulation turned up sides &

continuous under entire slab).

R-19 acoustic batt insulation

Provide acoustic insulation at all ceilings and outer walls of bedrooms, bathrooms and laundry rooms. R-19 acoustic batt insulation in 2x6 walls R-13 acoustic batt insulation in 2x4 walls

Ceilings:

Wrap entire building with 15 lb asphalt-impregnated felt or EnviroDri weather-resistant barrier, field membrane apply in roll, spray or brush; application temperature min.: 0° f; max.: 130° f, application thickness 15 wet mils or more, typical cure time1 <30 min., dry to touch; <8 hours, (wall temp) (110 – 130 sq. ft. / gal) or other product approved by siding manufacture for specific siding material such as Hardie Panel siding.

Hardie plank horizontal siding with 6" exposure & hardie panel. Pre-Stain with 2-coats minimum Benjamin Moore, both sides. Horizontal Corrugated Metal Rib height $\frac{7}{8}$ ". Deck and Siding Stain or equal. Color to be determined. Verify w Architect / Owner, use latex paint only on exterior of siding.

Exterior soffit to be 4" T&G tight knot cedar, rough side out. Stain with 2-coats minimum Benjamin Moore "Moorwood" Alkyd Semi-transparent Deck and Siding Stain or equal. Color to be determined. EXTERIOR STRUCTURAL WOOD SEALER:

Stain exposed wood beams, outlookers, columns, knee braces, rafter tails, etc. with 2-coats minimum Benjamin

Moore "Moorwood" Alkyd Semi-transparent Deck and Siding Stain or equal. Color to be determined. Verify w Architect / Owner. WATERPROOF DECK:

At decks - Plywood surface, 1/4" acx pine or doug fir plywood over 3/4" plywood; primer, tufflex tuff-poxy primer #1;

basemembrane, tufflex, tufflex solvent free "tuff" with rubber texture granules; top coat, tufflex color-coat al-ester,

ROOFING MATERIAL Architectural: Manufacturer: Verify and match existing. TBD by owner

Wood shake Color: Match Existing. Fasteners:

color - rocky gray. Installation per manufacturer's specification.

Install 36" wide across all hips and valleys, and (2) 36" Ice & Water Shield: wide courses at all eaves Type 30 per ASTM D-226 Underlayment: Valley Flashing: 28 gauge, enameled, min. 24" "W"-flashing Wall Trays: 26 gauge, enameled, min. 6" trough Roof to Wall Flashing: 26 gauge, enameled, min. 4" comp. coverage 26 gauge, enameled, min. 12" skirt

Chimney & Skylight Flashing: 26 gauge, enameled saddle with diverter where width exceeds 2 feet In-Wall counter flashing: 26 gauge, enameled 7-bar flashing

* DELIVER AND INSTALL PER IRC SECTION R905

GUTTERS AND DOWNSPOUTS

Pipe Flashing:

Lap eave flashing into galvanized 4" half round or square gutters with matching galvanized downspouts connected to 4" diameter rigid PVC tightline and run to approved discharge. Custom fabricated rake at gutter end - soldered seam - 4" or 6" O galvanized downspouts with custom fabricated attachments. Verify with Architect & Owner for downspout locations. Roof/Deck drains and scuppers shall be installed per IRC Section R903.4; concealed piping shall be installed in accordance with the UPC.

Per IRC Section R806, IECC CHP 4. R38 batt insulation in single rafter vaulted & low slope ceilings, R38 batt insulation in ceilings with advanced framing, and R49 batt insulation in standard framing provide 1" air gap at top. Use Best Materials brand TPO/PVC Roof Vent model S-VS08 where drawn. Provide eave and rake venting where shown. Un-vented cavity: 5.5" icynene closed-cell water-based spray foam insulation R-7 per inch. Spray-in where

metal with v-crimp typical. Roof-to-masonry conditions shall have enameled stepflash and counterflash.

Provide flashing and other weather protection per IRC Sections R903 and R905. Valley flashing shall be enameled

Taylor Metal Products Inc. Use manufacturer recommended or equal or greater performing

DIVISION 8 - DOORS AND WINDOWS: EXTERIOR DOORS:

All exterior doors shall be selected by owner. Color to be determined. Provide continuous interlocking metal weather-stripping, brass anodized metal threshold, cylinder entry lock access and deadbolt drilling. Double-glazed safety glass, with low-E (color to match windows), as indicated on Drawings. U-Value of doors to be 0.30 or better; doors with more than 50% glazing to have a U-Value of 0.30 or better. Provide screens at sliding doors only when indicated on Drawings. Provide Loewen, Sierra Pacific, Weathershield or equal as approved by Owner.

All swinging interior doors to be solid core, clear coated (both sides) wood veneer or painted both sides. Color to be determined. Verify w Architect / Owner. All pocket-doors premium track and roller hardware. Verify w/Owner.

See elevations for panel pattern, Coplay Aluminum with clear coat, style to be selected by owner.

Exterior Doors: To be selected by owner, key lock exterior, knob lock interior, with separate dead bolt to match. To be determined by owner.

Interior Doors: To be selected by owner. Provide privacy locks at all bathrooms and bedrooms; passage latch at all

others unless noted otherwise; matching hinges to match latch sets. Verify w/Owner. Provide 2 pair butts on all 8'-0" high doors, 1-1/2 pair butts on 6'-8" or 7'-0" doors. Provide door-stops to match hardware.

All windows to be double-paned, vinyl - white finish, with insulated low-E glazing. Window performance and construction to conform with IRC Section R609. Simulated divided lites shall have 1" bead stop profile. Hardware finish shall match door hardware. All casement openings shall have roto hardware. All openings weather-stripped by manufacturer; General Contractor shall install "Z"-flashing at heads of all windows and seal window perimeter per manufacturer's specifications. Provide insect screens at all operable locations. Egress shall be provided from all sleeping rooms per IRC Section R310. General Contractor shall review all tempered glass and egress locations. Provide safety glazing per IRC Section R308.4. U-Value of all new window glazing to be 0.30 or better. Provide Loewen, Sierra Pacific, Weathershield or equal, as approved by Architect/owner.

SKYLIGHTS: Install skylights and sloped glazing per IRC 308.6.

DIVISION 9 - INTERIOR FINISHES:

Smooth finish 1/2" GWB on walls and ceilings; 5/8" GWB on any ceilings with framing @ 24" o.c. Provide gypsum drywall construction fire resistant ratings indicated install water- resistant backing board in bathrooms and other similar "wet" areas not otherwise indicated to revive "wonderboard" and tile. Install compound in 3 coats (prefill of cracks recommended by manufacture); sand after last 2 coats.

Attachments: Screw (absolutely no nails) Accessories and tape: As recommended by gypsum board manufacture and as indicated In the drawings. Joint compound: United states Gypsum Co. use water-resistant joint compound with water resistant backing board.

Finish: Smooth-walls Reglets and beads: verify with Architect & Owner as required.

HARDWOOD FLOORING: To be selected by owner. Apply (3) coats Swedish finish. Install flush wooden floor grilles per mechanical

requirements for air venting. Verify location of grilles with Architect & Owner. Foyer. Install flush wooden floor grilles per mechanical requirements. Verify location of grilles w/Owner.

BUILT-IN CABINETRY: Verify w/Owner.

NTERIOR STONE WORK/ HARD SURFACE COUNTERTOPS

Comply with recommendation contained in national Granite Quarries Assoc., INC. (NBGQA). Stone Slab: Not yet determined, verify with owner. Grout: Hydroment, color as selected by owner. Sealants: as recommended by

All interior wood trim to be MDF unless noted otherwise. Verify w/Owner.

Entire residence First Floor shall have a 1/2 x 5 Verify w/Owner MDF baseboard trim. Rooms with ceramic tile flooring shall have a ceramic tile base. Verify w/Owner.

Comply with mortar and grout materials and installation standard of the American National Standee Institute (ANSI) standard specification for ceramic tile and manufacturer's instructions for glass mesh mortar units (wonederboard) per manufacture's requirement at bathrooms. Verify exposed edge of the tile meeting carpet, wood, or resilient flooring, unless otherwise indicated. Grout: Hydroment, color as selected by owner.

Sealants: one -part mildew-resistant silicone sealants per manufacture.

PAINT SPECIFICATIONS:

Verify all finish with owner prior to proceeding. Colors will be selected by owner from standard color available for the coatings required. Apply required prime coat to materials. Provide barrier coats over incompatible primers where required. Provide finish coats which are compatible with primers. Sand lightly between lacquer coats. Apply additional cats until paint film is of uniform finish, color and appearance.

Primed and painted metal: first coat: Poly-amide epoxy second coat: aliphatic polyester finish coat: urethane Galvanized steel: exposed exterior galvanized steel left unpainted.

Exterior: decking, siding, exterior cedar trim and soffit boards: see specification - division 6 - wood and plastics

Wood painted doors: prime and two coats Benjamin Moore Imprevo. Color to be selected by owner. Wood lacquer doors: Two coats tinted semi-transparent UV resistant lacquer. - color to be selected by owner.

Interior wood trim: Two coasts clear semi-gloss transparent UV resistant lacquer or prime and tow coast oil based semi-gloss enamel. Review with owner locations of paint versus lacquer. GWB: first coat: PVA sealer-primer second coat: interior flat latex (semi-gloss latex enamel in wet locations) third

coat: Interior flat latex (semi-gloss at wet locations). Interior wood panels: two coats shop applied clear tinted semi-transparent UV resistant lacquer. Touch up field cuts as required. Verify w/Owner.

DIVISION 10 - SPECIALTIES:

TOWEL & BATH ACCESSORIES: Existing - Not Applicable

Verify w/Owner specs. for all mirrors, towel bars, toilet paper dispensers and any other accessories, whether shown on plans or not. Provide blocking for all accessories as indicated on drawings.

Consult with Owner on closet storage systems.

DIVISION 11 - EQUIPMENT

GARAGE DOOR OPENERS: PROVIDE 2 MIN. EACH

DIVISION 12 - FURNISHINGS: N/A

DIVISION 13 - SPECIAL CONSTRUCTION: N/A

DIVISION 14 - CONVEYING SYSTEMS: N/A

DIVISION 15 - MECHANICAL:

HEATING AND VENTILATION: Existing HVAC system to remain Navien Model: NPE-240A-NG Tankless water heater, 199,900 Btu/hr Max, UEF rating .96

meeting option 5c of WSEC for 1.5 credits. SOURCE SPECIFIC EXHAUST FANS:

All existing exhaust fans shall remain. No new fans added.

METAL DUCTS: Joints taped, insulated per WSEC 403.2.

GARAGE/ CARPORT DUCTS:

GAS APPLIANCE FIREPLACES:

Ducts in the garage/carport and ducts penetrating the walls or ceilings separating the dwelling from the garage/carport must be a minimum of 26 gauge sheet metal with no register outlets into the garage. Ducts outside the protected envelope are excluded from these regulations.

EXHAUST FANS: Existing: Not applicable Provide exhaust fans where shown on Floor Plans A2.0, A2.1

THERMOSTAT(S):

Provided by Mechanical Contractor; verify location(s) w/Owner.

Drawings. Provide insulation foam at all floor, roof, and wall plumbing penetrations.

Outdoor Lifestyles, by Hearth & Home Technologies, Lanai ODLANAIG51 outdoor gas fireplace- verify w/Owner fireplaces.com (800) 927-6841.

All plumbing to be installed per the UPC. Existing, gas-fired, (verify capacity) water heaters with R-12 insulation. Provide seismic straps per the UPC. Drain hot water tank pressure-relief valve to outside of building or to floor drain (provide 1" minimum air gap) using hard-drawn copper piping. Provide reticulating pump and plumb for instant hot water. Sources of ignition must be kept at least 18" above floor line. Provide plumbing to all fixtures shown on

To achieve WSEC Credit Option 5a per Table 406.2 all showerhead and kitchen sink faucets shall have maximum flow of 1.75 GPM. All other lavatory faucets shall be rated at 1.0 GPM or less.

SPRINKLER SYSTEM:

Type: Flow-through protection systems. N/A

Automatic sprinklers are required per NFPA 13D and City of Mercer Island Fire Department Standards. Provide a 1" minimum meter connection. Sprinkler system to provide coverage throughout structure, including decks and garage. Designed by a Washington State Certified Engineer. Construction shall conform to the requirements of International Fire Code chapter 14. The system shall be installed, inspected, tested, and approved prior to framing inspection approval. A separate permit may be required. All sprinkler heads shall be recessed. Coordinate locations with lighting plan, typical. Verify with General Contractor & Architect.

DIVISION 16 - ELECTRICAL:

All work shall conform to current and applicable codes and shall be coordinated with the General Contractor. Electrical Contractor shall verify requirements to wire and hook up all exhaust fans, appliances, furnaces, air conditioners and all other equipment requiring electrical service. Electrical Contractor shall verify and acquire approval of panel distribution and service from Owner and General contractor prior to installation.

Provide insulation foam at all floor, roof, and wall electrical penetrations.

LIGHTING FIXTURE LAMPS:

Provide and install GE or Sylvania lamps. All incandescent lamps recessed into insulated areas shall be approved for zero-clearance insulation cover All fluorescent lamps shall be full-spectrum.

ATTIC SPACES:

Required access opening in all concealed attic areas that exceed 30 sf and have a vertical height of 30" or greater measured from top of ceiling framing members to the underside of the roof framing members. See floor plan for location. Attic access rough-frame opening shall not be less than 22"x30" and shall be located in hallway or accessible location. Section R807.1

SMOKE & CARBON MONOXIDE DETECTORS:

ee Sheets A2.0, A2.1, A2/2. Provide and install smoke detectors per IRC Section R314. Hardwire 110-volt unit with battery backup. In alterations, repairs and additions provide and install additionally per IRC Section R314. Provide and install Carbon Monoxide detectors per IRC section R315.

bottom light valence, light fixture shall be mounted at +84" and top of mirror shall be at +80".

All wall mounted fixtures shall be mounted +80" from finish floor to centerline of fixture, unless noted otherwise. At

Provide waterproof duplex outlets under the eaves where shown in drawings. Color shall be approved by Architect

BUILT-IN IRONING BOARD: N/A

WALL MOUNTED LIGHT FIXTURES:

Provide wired Dimango door chime and push button; style and color to be determined. Verify w/Owner.

Verify and provide telephone, cable, and Internet requirements per Owner.

SOUND SPEAKERS: Provide recessed sound speakers per Owner.

GROUND FAULT CIRCUIT INTERRUPTER PROTECTION: Ground fault interrupter required in all bathrooms, on or above countertops within six feet of any sink, in all accessible garage areas, in all crawl spaces, all outdoor areas, and any other locations as required by the NEC.

SWITCHES/OUTLETS AND COVER PLATES: All switches and outlets shall be blocked out from openings such that cover plates will not conflict with door and window trim or decorative molding, unless noted otherwise. Supply and install cover plates on all electrical,

telephone, and cable outlets. All cover plates shall be Decora or equal; color to be determined.

manufacturer's air handler enclosure. All register boots shall be taped or otherwise

ENERGY CODE COMPLIANCE NOTES:

1. Duct leakage test results shall be provided to the building inspector and home owner prior to the approved final inspection. Ducts shall be leak tested in accordance with WSU RS-33, using the maximum duct leakage rates specified. Duct tightness shall be verified by either of the following:

1. Postconstruction test: Total leakage shall be less than or equal to 4 cfm (113.3 L/min) per 100 square feet (9.29 m2) of conditioned floor area when tested at a pressure differential of 0.1 inches w.g. (25 Pa) across the entire

sealed during the test. Leakage to outdoors shall be less than or equal to 4 cfm (133.3 L/min) per 100 square feet of

2. Rough-in test: Total leakage shall be less than or equal to 4 cfm (113.3 L/min) per 100 square feet (9.29 m2) of conditioned floor area when tested at a pressure differential of 0.1 inches w.g. (25 Pa) across the system, including the manufacturer's air handler enclosure. All registers shall be taped or otherwise sealed during the test. If the air handler is not installed at the time of the test, total leakage shall be less than or equal to 3 cfm (85 L/min) per 100 square feet (9.29 m2) of conditioned floor area. The test results shall be posted on the Residential Energy Compliance Certificate (WSEC 401.3). This shall be present to the inspector as a signed affidavit documenting the duct leakage testing results.

thermal envelope. Ducts located in crawl spaces do not qualify for this exception.

Exception: The total leakage test is not required for ducts and air handlers located entirely within the building

3. Minimum 75% of all interior luminaries shall be high efficacy luminaries and all exterior lighting shall be high efficacy luminaries. 4. Per Requirement for Additions greater than 500 sf, 1.5 energy credit points must be met per table R406.2.

2. A Residential Energy Compliance Certificate complying with WSEC 401.3 is required to be completed by the design professional or builder and permanently posted within 3' of the electrical panel prior to the final inspection.

Options 5c (Efficient Water Heating) are to be used. 5. Each dwelling unit is required to be provided with at least one programmable thermostat for the regulation of

6. Per WSEC R402.4, the building thermal envelope shall be constructed to limit air leakage. The results of the

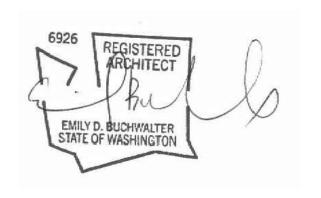
test shall be signed by the party conducting the test adn provided to the code official. (R402.4.1.2)

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REGISTRATION:



DATE: INTAKE: **REVISIONS:** DATE: PROJECT / CLIENT:

ACHIN & MARY CHEN 9820 SE 35TH PLACE MERCER ISLAND, WA 98040

9820 SE 35TH PLACE

JOB ADDRESS: 9820 SE 35TH PLACE MERCER ISLAND, WA 98040 PARCEL # 082405-9027

DRAWING NAME:

GENERAL NOTES

Checked By: EB

Owner Approval:

from the Architect.

Drawn Bv: JMG.RB

CONSTRUCTION DOCUMENTS

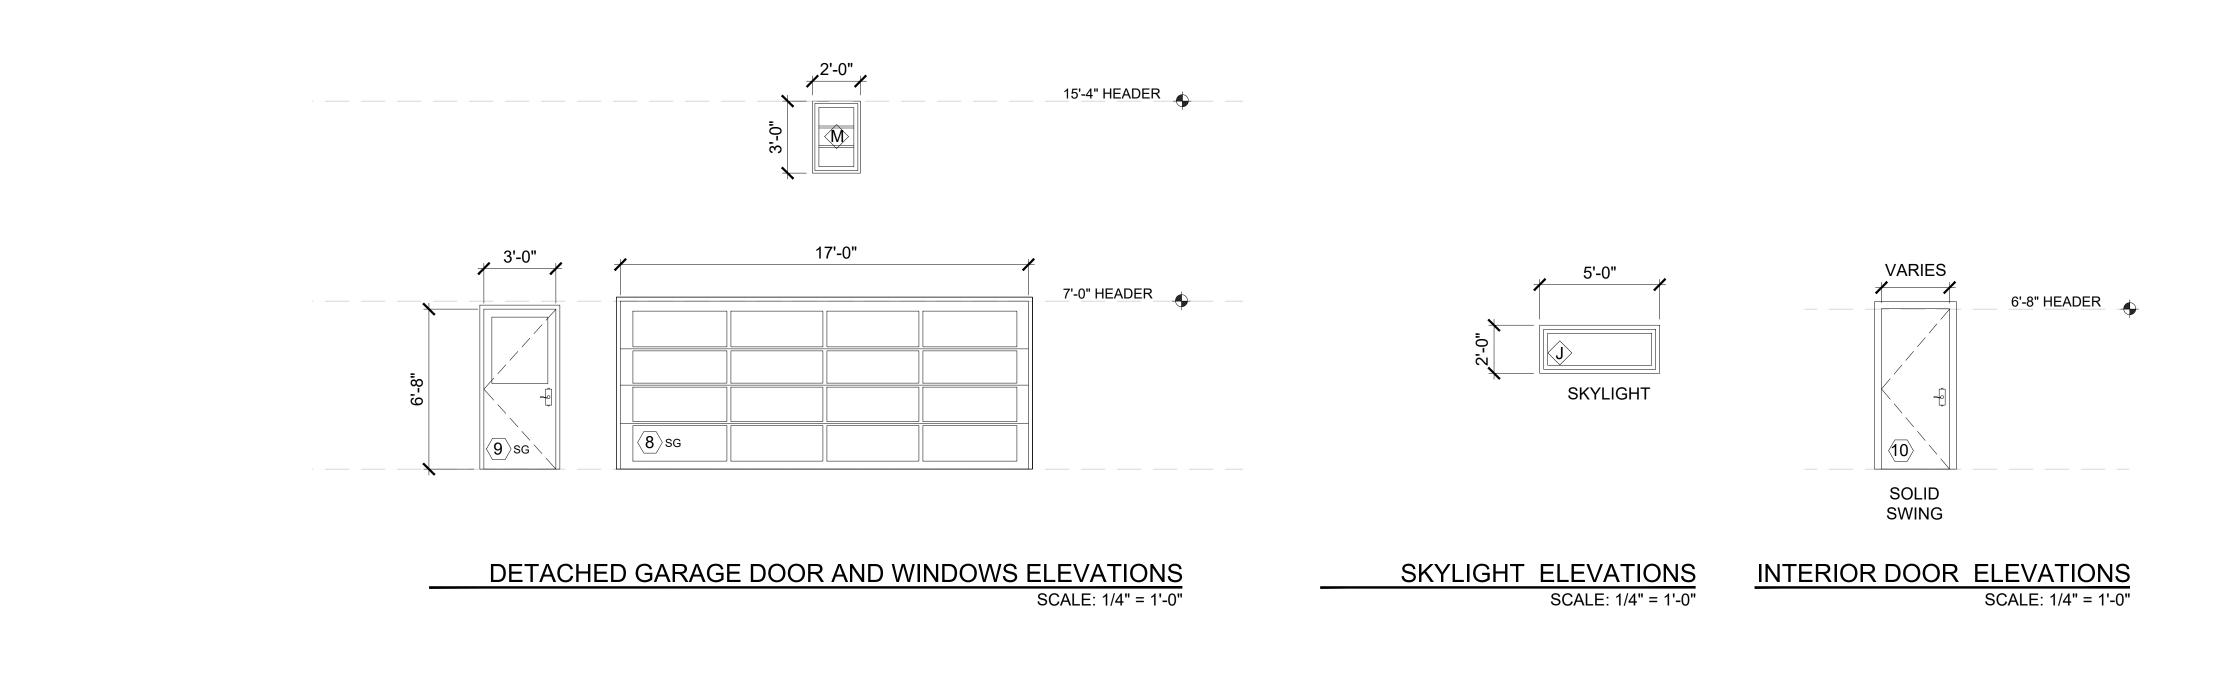
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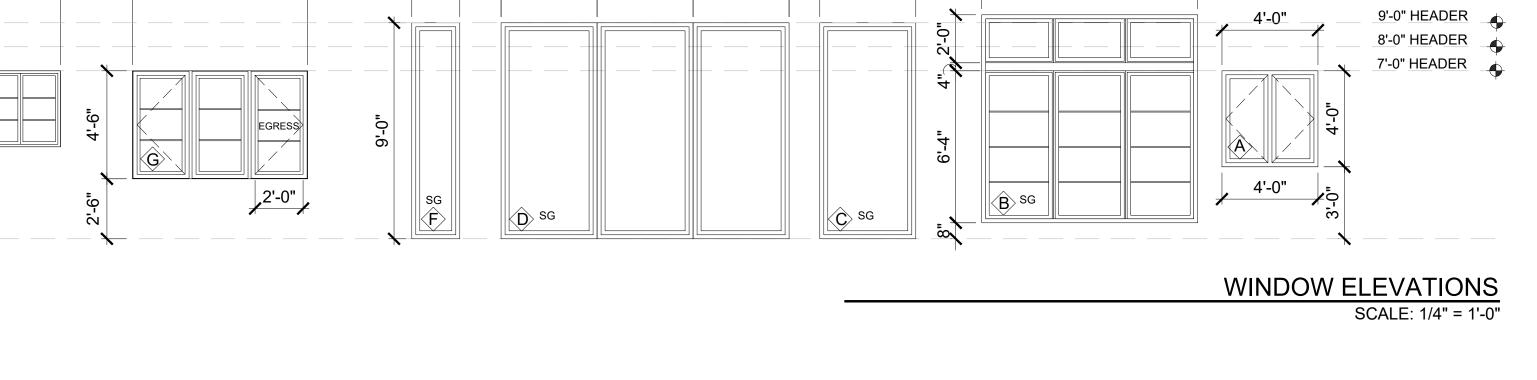
APPROVED FOR CONSTRUCTION

PROJECT No.: 2020 007

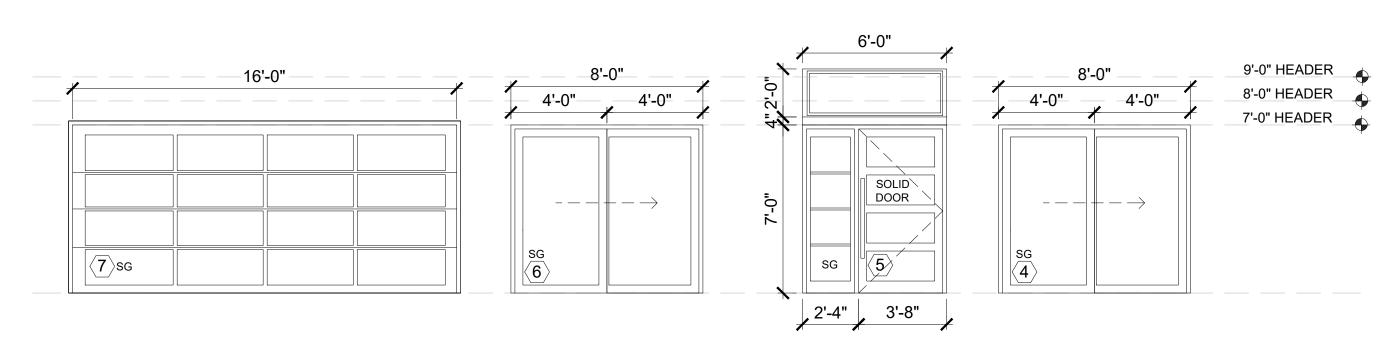
PLOT SCALE: 1:1

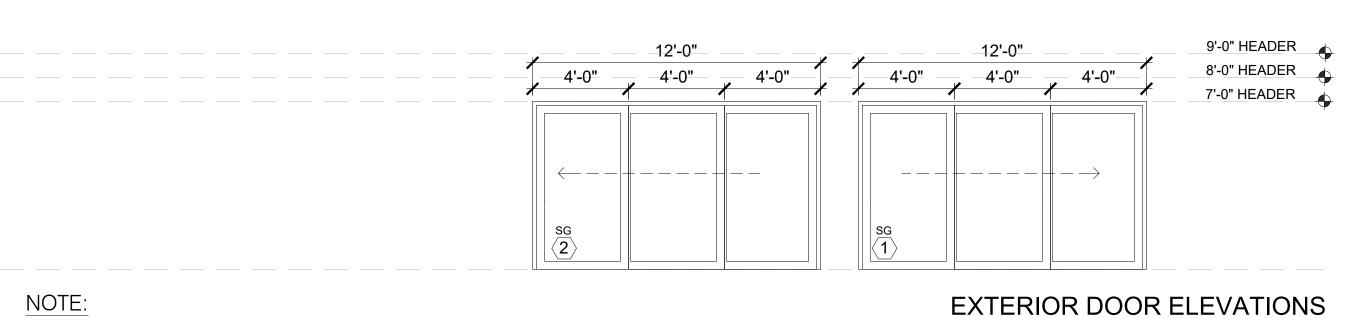
DATE: 12-22-2020





9'-0"





DIMENSIONS INDICATE ROUGH OPENINGS. MANUFACTURER TO SIZE WINDOWS ACCORDINGLY. FIELD MEASURE PRIOR TO ORDERING. VERIFY SIZE REQUIREMENTS FOR EGRESS.

NO	Qty.	LOCATION	W	Н	MANUF	TYPE	HARDWARE	REMARKS
10	1	OFFICE	2'-8"	6'-8"	TBD	SOLID SWING		
							ALL HARDWARE TO BE	
							BRUSHED NICKEL FINISH 2-	
							PAIR OF BUTT HINGES FOR 8'-0" DOORS	
	1	DOOR COUNT						
NOTES:								
		4 0 T 0 D 0 U 1 L D 0 U 1 D 1 U 1 D 1 U 1 D 1 U 1 D 1 U 1 D 1 U 1 U	. D.A.T.A. ONL. ALL			2000	(AQUINOTON STATE ENERGY GORE	
I. GENER	AL CONTRA	ACTOR SHALL PROVIDE MANUFACTURER'S	DATA ON ALL	WINDOWS	SHOWING CO	OMPLIANCE WITH THE 2015 W	ASHINGTON STATE ENERGY CODE.	
2. ALL EX	ERIOR TR	UE DIVIDED FIXED TRANSOM GLAZING TO	BE POSITIONE	D AT UPPE	ER SASH LOCA	ATION.		
3. VERIFY	ALL DOOF	R TYPES & HARDWARE W/OWNER PRIOR TO	ORDERING.					
4 0000		IG UN-HEATED FROM HEATED SPACE TO B	□	DED WEEC	2015			

					WINDO	DW SCH	1EDUL	<u>.</u>			
NO	Qty.	LOCATION	WIDTH	HEIGHT	AREA	MANUF.	U-VAL	TYPE	SCREEN	HARDWARE	REMARKS
Α	1	NEW EXERCISE ROOM	4'-0"	4'-0"	16.00	TBD	0.28	CSMT/CSMT	Υ	TBD	
В	1	FORMAL DINING ROOM	9'-0"	8'-4"	74.70	TBD	0.28	FIXED	N	TBD	TRANSOM,GRIDS
С	1	FAMILY ROOM	4'-0"	9'-0"	36.00	TBD	0.28	FIXED	N	TBD	SAFETY GLASS
D	1	FAMILY ROOM	12'-0"	9'-0"	18.00	TBD	0.28	FIXED	N	TBD	SAFETY GLASS, MULLED
E	1	EXISTING WINDOWS									
F	1	FAMILY ROOM	2'-0"	9'-0"	18.00	TBD	0.28	FIXED	N	TBD	SAFETY GLASS
G	1	BEDROOM 3	7'-3.5"	4'-6"	32.85	TBD	0.28	CSMT/CSMT/CSMT	Υ	TBD	EGRESS, GRIDS
Н	1	ABOVE FOYER	5'-0"	3'-2"	15.50	TBD	0.28	FIXED	N	TBD	GRIDS, SAFETY GLASS
I	1	NOT USED	0	0	0.00						
J	1	FOYER	2'-0"	5'-0"	10.00	TBD	0.43	SKYLIGHT	N	TBD	SKYLIGHT
K	1	NEW OFFICE	4'-0"	3'-10"	8.34	TBD	0.28	CSMT/CSMT	Υ	TBD	GRIDS
L	2	NEW EXERCISE RM INTERIOR	4'-0"	6'-4"	50.40	TBD		FIXED	N	TBD	STOPPED IN GLASS
М	1	DETACHED GARAGE WINDOW	2'-0"	3'-0"	6.00	TBD		FIXED	N	TBD	NON CONDITIONED
					229.39		0.28		64.23		
					10.00	SF	0.43		4.3		NOTE: SEE A0.3 & A4.0,1,2 FOR WINDOW DIVISIONS
	14	WINDOW COUNT						U X A =	68.53		SNIDIGINIO MODINIM

1. GENERAL CONTRACTOR SHALL PROVIDE MANUFACTURER'S DATA ON ALL WINDOWS SHOWING COMPLIANCE WITH THE 2015 WASHINGTON STATE ENERGY CODE. CONTRACTOR TO FIELD VERIFY ALL WINDOW AND DOOR SIZES AND EGRESS REQUIREMENTS PRIOR TO ORDERING. VERIFY SWING DIRECTION WITH OWNER 2. ALL EXTERIOR TRUE DIVIDED FIXED TRANSOM GLAZING TO BE POSITIONED AT UPPER SASH

3. ALL WINDOWS TO BE NFRC CERTIFIED AND LABELED

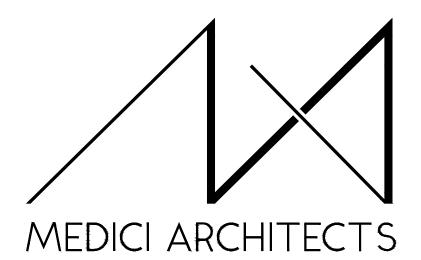
					EXT	ERIOR	DOO	R SCHEDUL	 E		
NO	Qty.	LOCATION	W	Н	MANUF.	AREA	U-VAL	TYPE	CONFIGURATION	HARDWARE	REMARKS
1	1	NEW EXERCISE ROOM	12'-0"	7'-0"	TBD	84.0	0.28	SLIDING	XXO		SAFETY GLASS
2	1	NEW SITTING ROOM	12'-0"	7'-0"	TBD	84.0	0.28	SLIDING	XXO		SAFETY GLASS
3	0	NOT USED	0	0	TBD	0.0	0.28				
4	1	KITCHEN	8'-0"	7'-0"	TBD	56.0	0.28	SLIDING	ХО		SAFETY GLASS
5	1	FOYER	6'-0"	9'-0"	TBD	54.0	0.28	SOLID SWING WITH SIDE LITE & TRAMSOM		ALL HARDWARE TO BE BRUSHED NICKEL FINISH 2- PAIR OF BUTT HINGES FOR 6'-8"/ 8'-0" DOORS	SAFETY GLASS
6	1	MASTER BEDROOM	8'-0"	7'-0"	TBD	56.0	0.28	SLIDING	ХО		SAFETY GLASS
7	1	GARAGE	16'-0"	7'-0"	TBD			OVER HEAD GARAGE DOOR	Х	1	SEE ELEVATION FOR DOOR
8	1	DETACHED GARAGE	17'-0"	7'-0"	TBD			OVER HEAD GARAGE DOOR	х	1	SEE ELEVATION FOR DOOR FERN
9	1	DETACHED GARAGE ENTRY	3'-0"	8'-0"	TBD		0.28	SOLID SWING	х	ALL HARDWARE TO BE BRUSHED NICKEL FINISH 2- PAIR OF BUTT HINGES FOR 6'-8"/ 8'-0" DOORS	1/2 LIGHT, SAFTY GLASS
TOTAL			1	1	SF	334.0	0.28	TOTAL U x A =	93.5		
NOTES:											

1. GENERAL CONTRACTOR SHALL PROVIDE MANUFACTURER'S DATA ON ALL WINDOWS SHOWING COMPLIANCE WITH THE 2015 WASHINGTON STATE ENERGY CODE.

2. ALL EXTERIOR TRUE DIVIDED FIXED TRANSOM GLAZING TO BE POSITIONED AT UPPER SASH LOCATION.

SCALE: 1/4" = 1'-0"

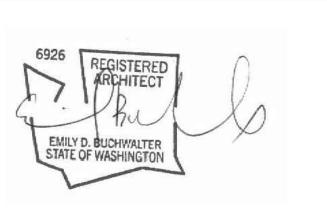
3. VERIFY ALL DOOR TYPES & HARDWARE W/OWNER PRIOR TO ORDERING. 4. DOOR SEPARATING UN-HEATED FROM HEATED SPACE TO BE U=.28 MAX. PER WSEC 2015 5. ALL DOOR WITH GLAZING TO BE NFRC CERTIFIED AND LABELED



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5.	

9820 SE 35TH PLACE

ACHIN & MARY CHEN 9820 SE 35TH PLACE MERCER ISLAND, WA 98040

PROJECT / CLIENT:

JOB ADDRESS: 9820 SE 35TH PLACE MERCER ISLAND, WA 98040 PARCEL # 082405-9027

DRAWING NAME:

SCHEDULES

Drawn By: JMG,RB Checked By: EB Owner Approval:

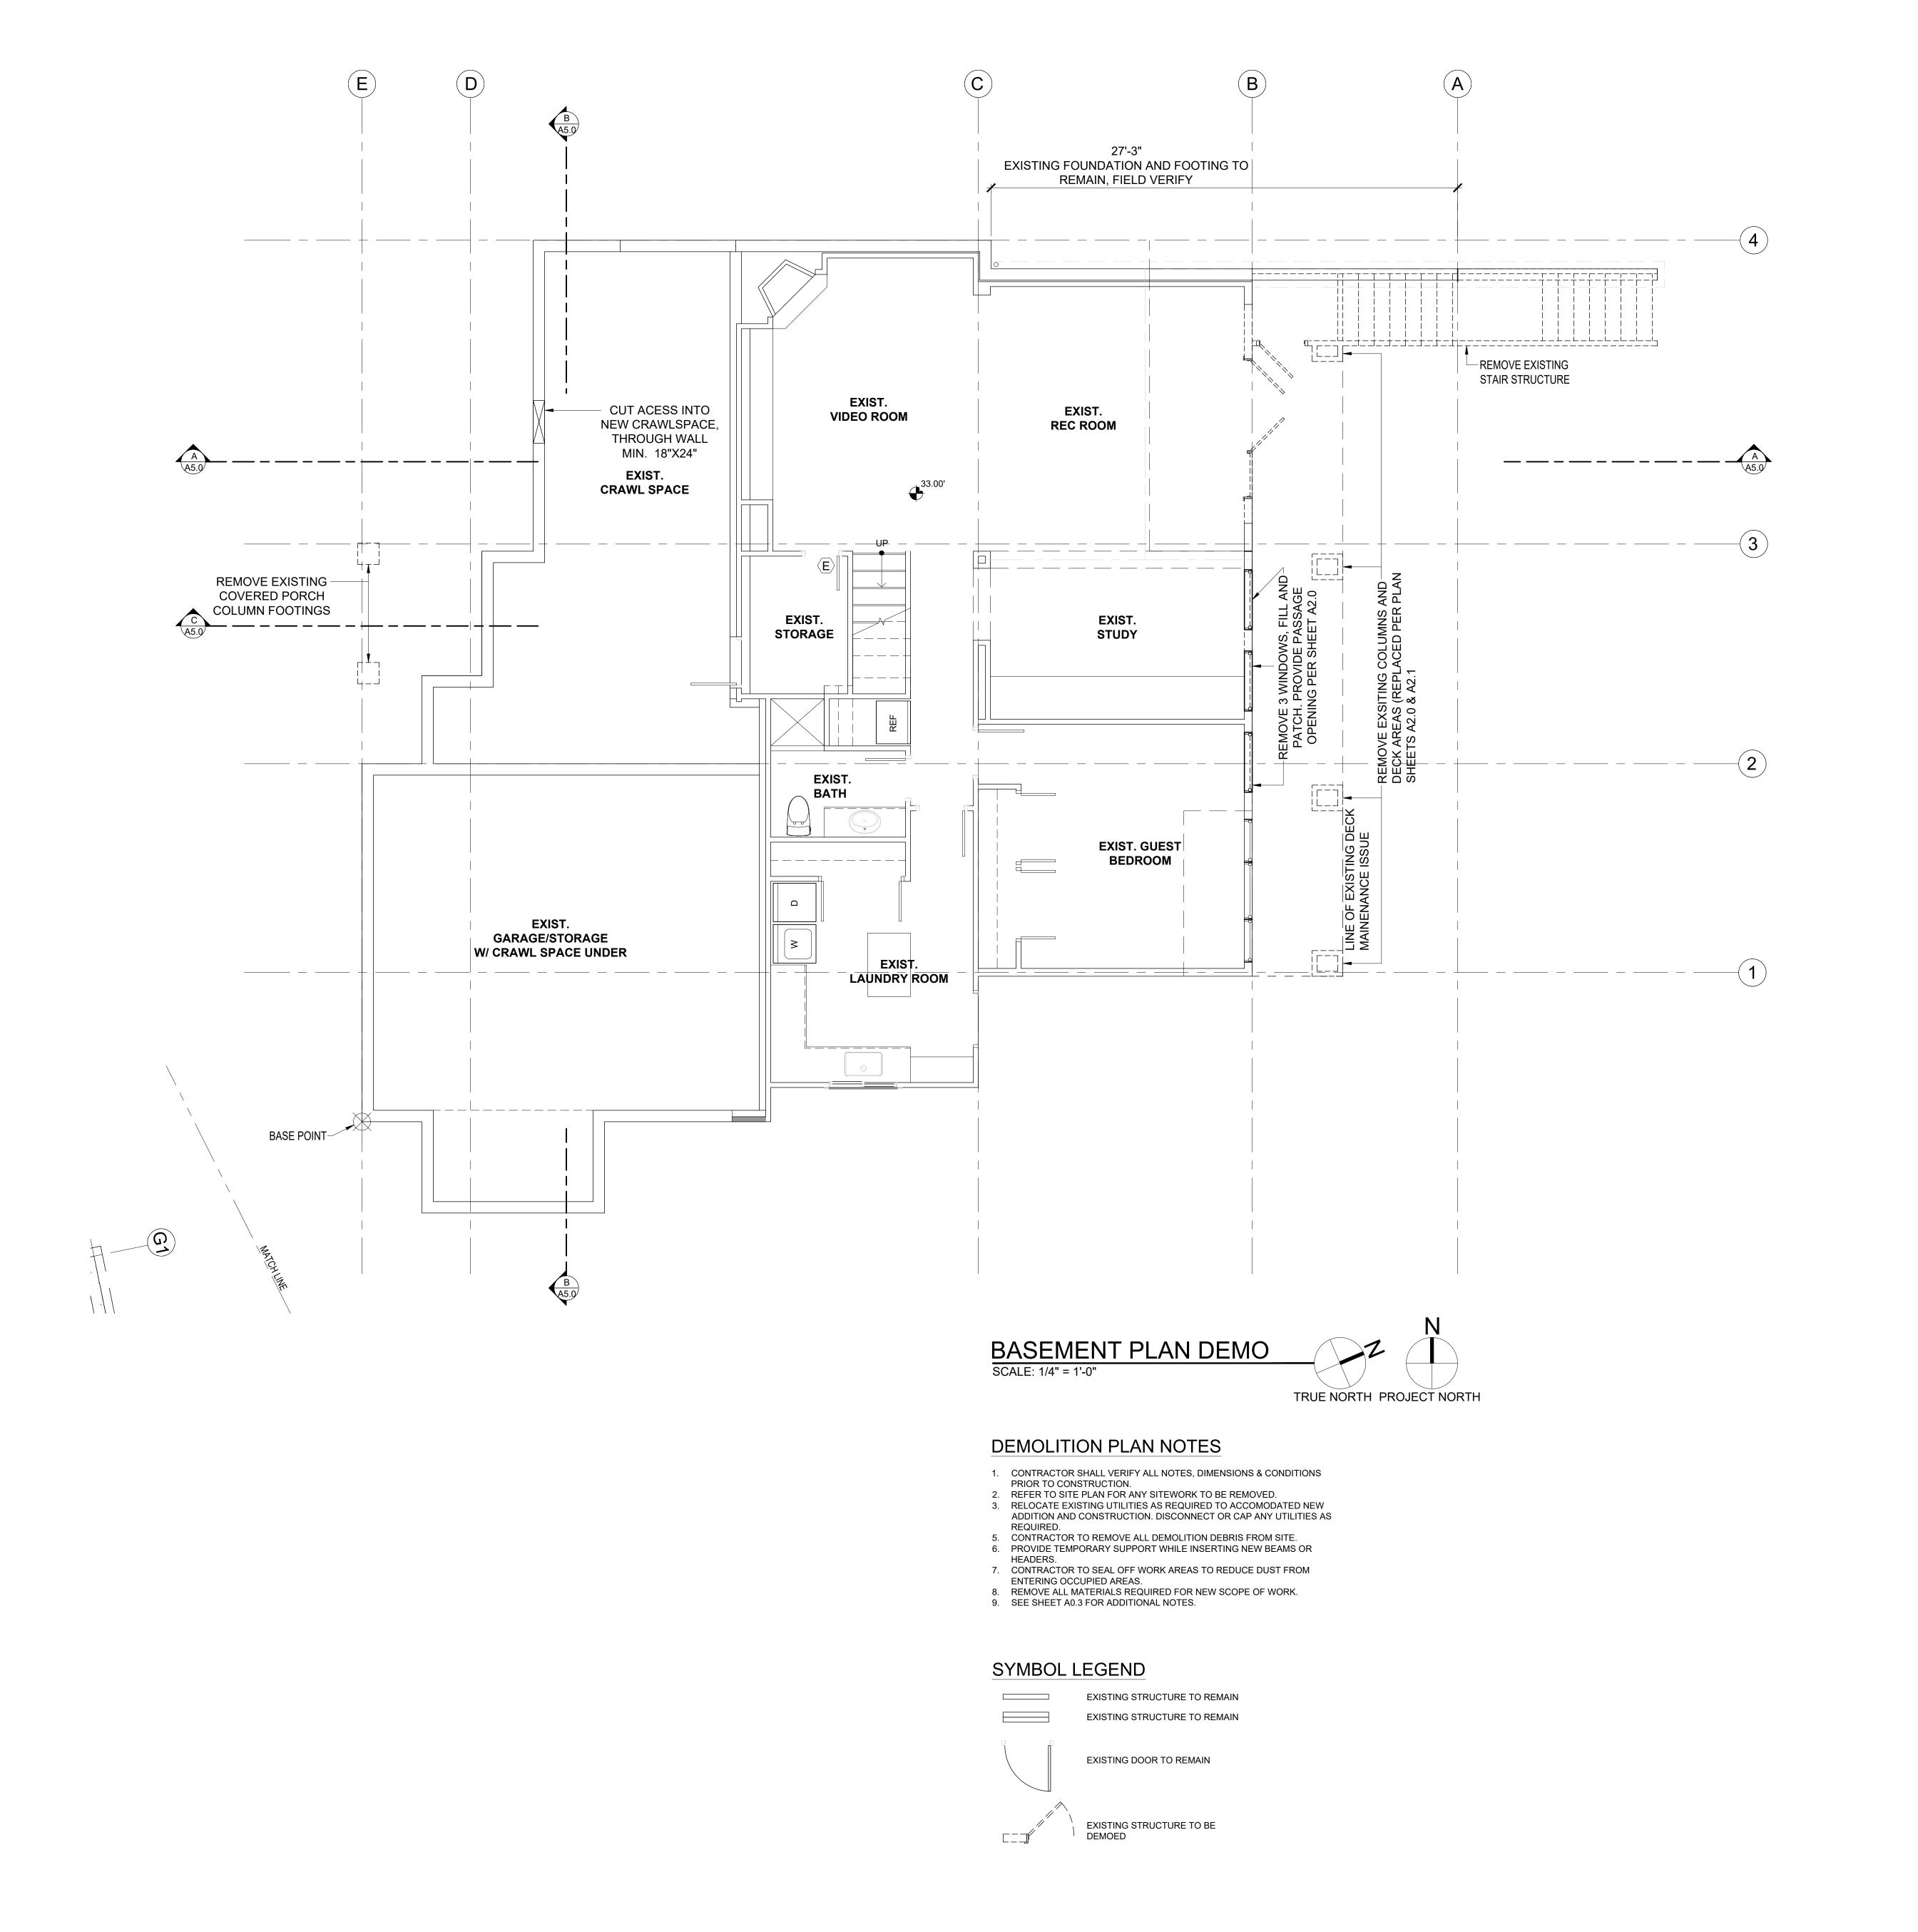
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PROJECT No.: 2020 007 DATE:

12-22-2020

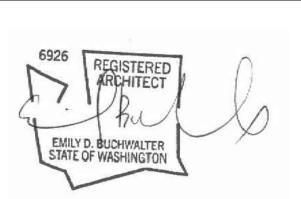




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9820 SE 35TH PLACE ACHIN & MARY CHEN 9820 SE 35TH PLACE MERCER ISLAND, WA 98040

JOB ADDRESS: 9820 SE 35TH PLACE MERCER ISLAND, WA 98040 PARCEL # 082405-9027

DRAWING NAME:

DEMOLITION BASEMENT

Drawn By: JMG,RB Checked By: EB Owner Approval:

PHASE:

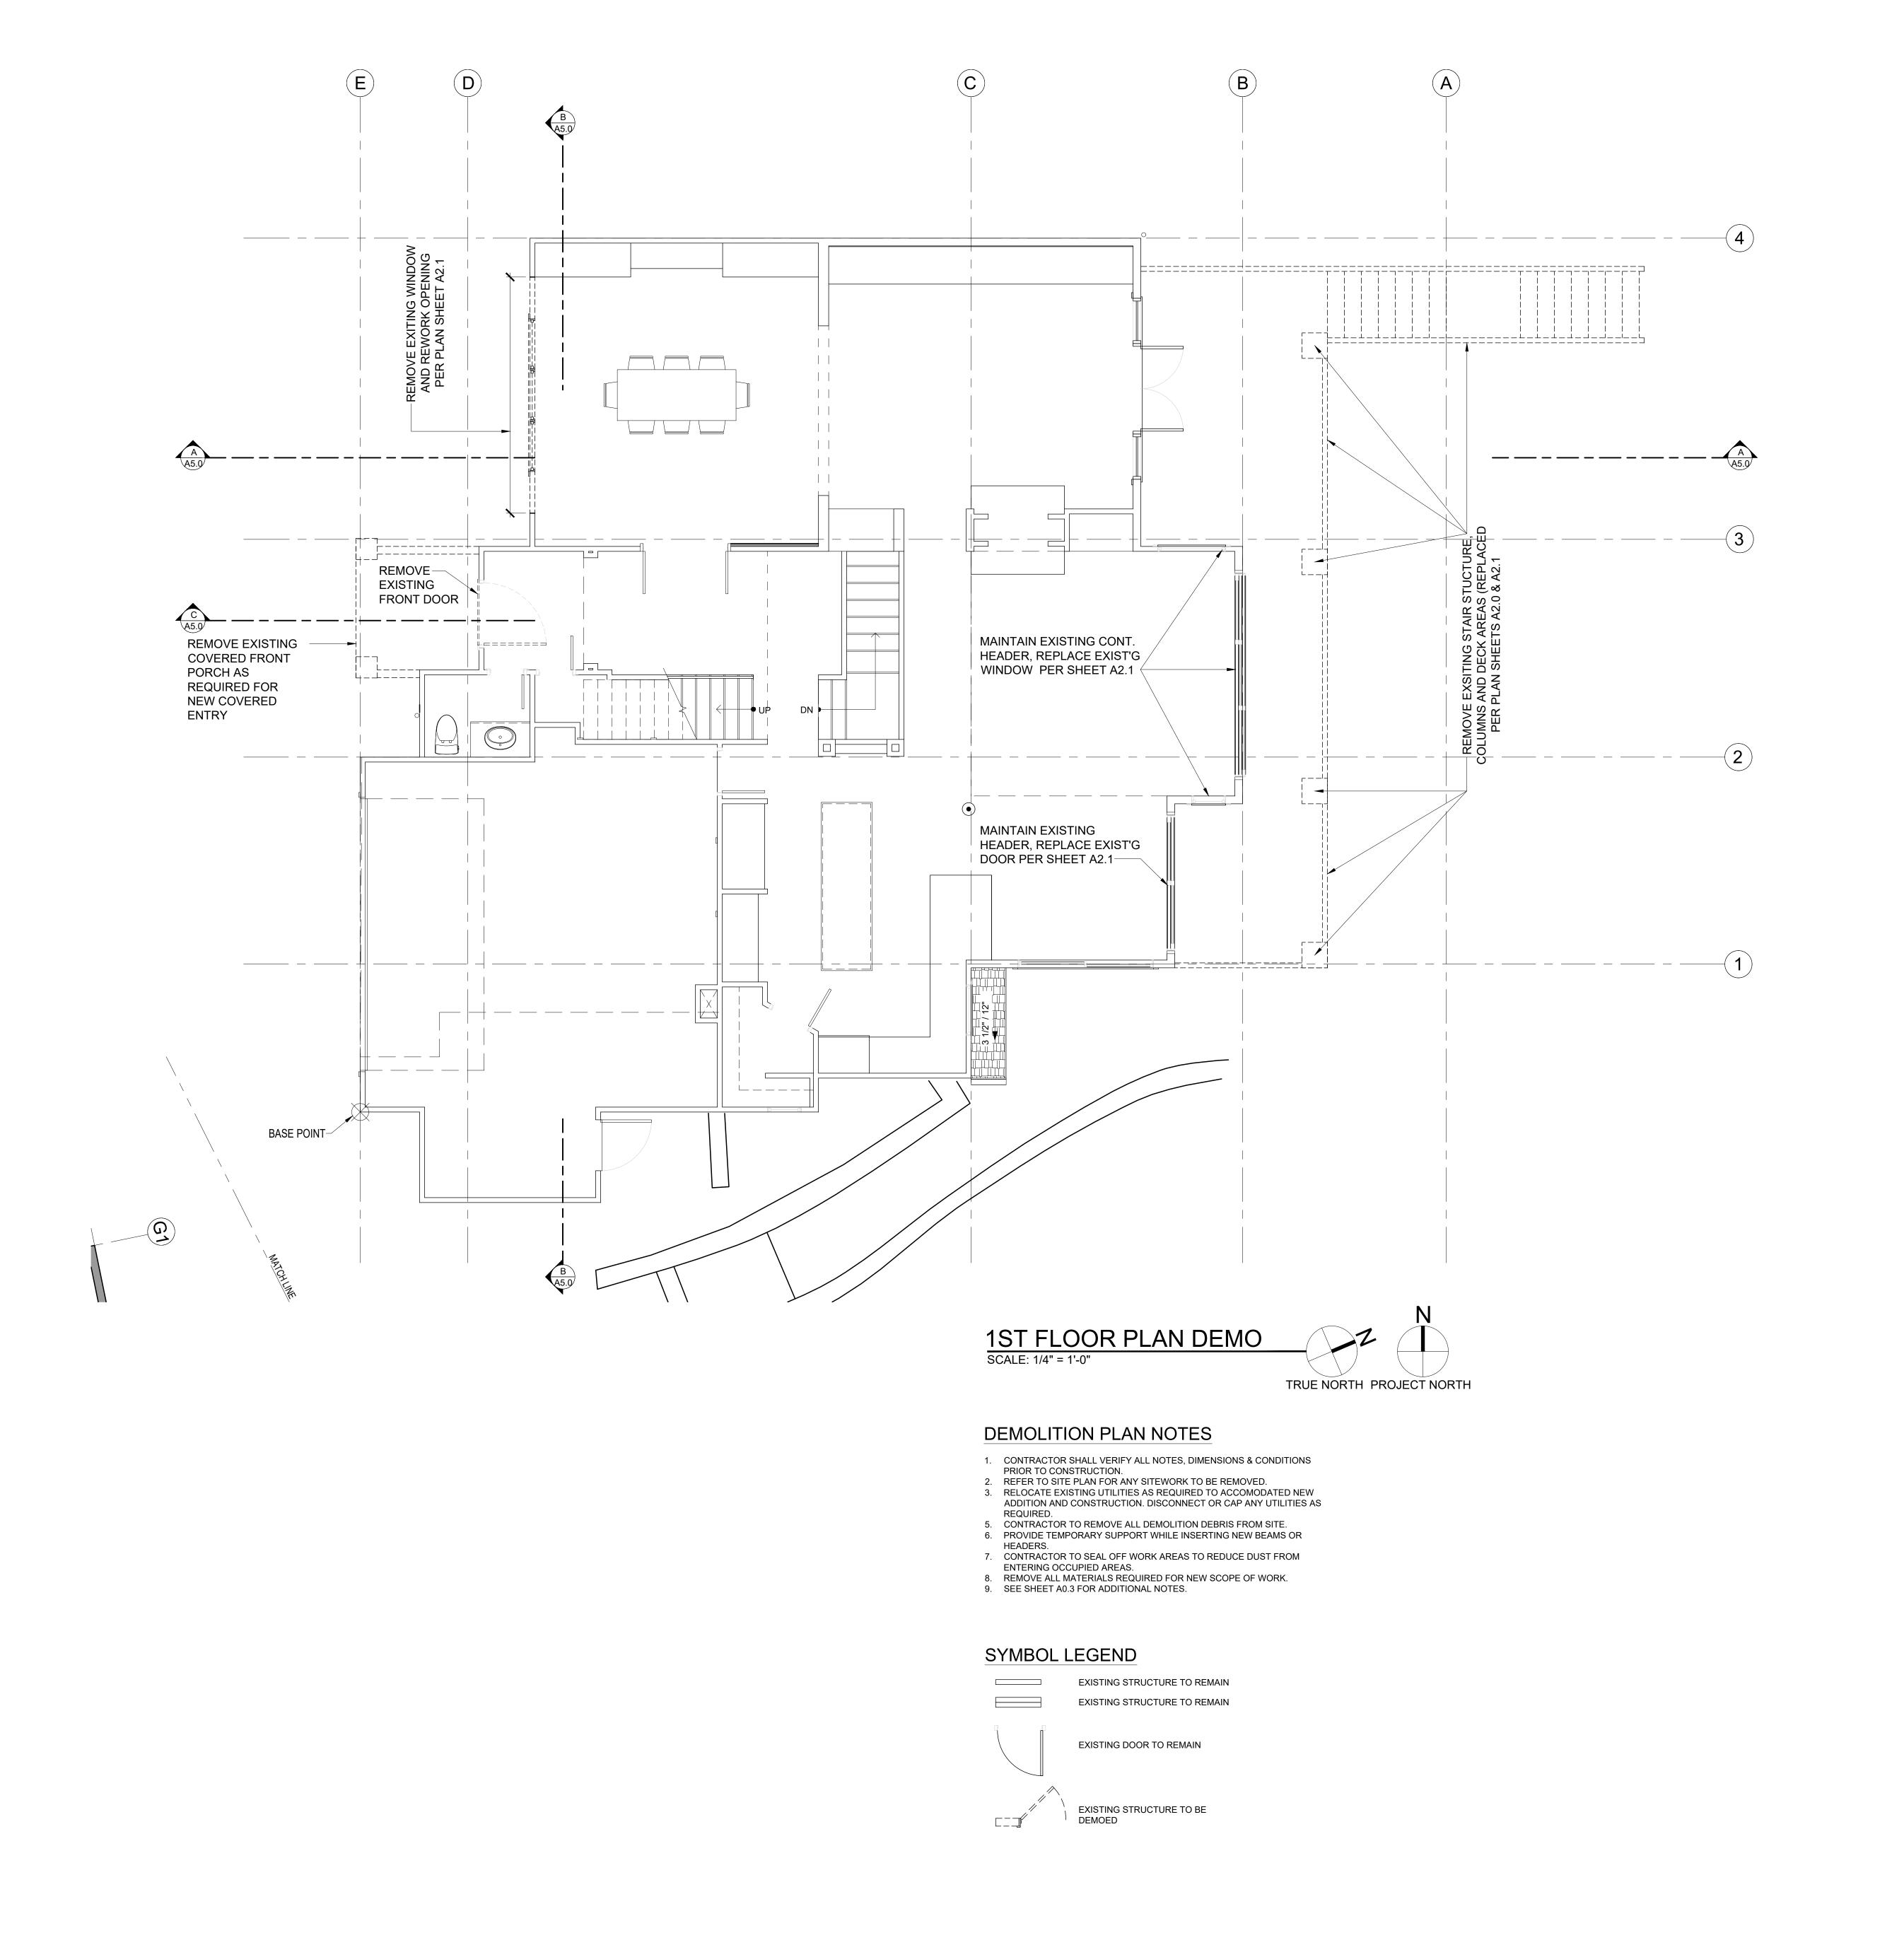
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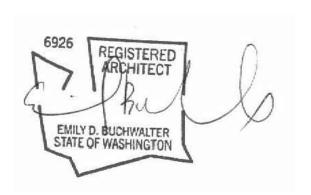




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ACHIN & MARY CHEN

9820 SE 35TH PLACE

PROJECT / CLIENT:

9820 SE 35TH PLACE MERCER ISLAND, WA 98040

JOB ADDRESS:

9820 SE 35TH PLACE MERCER ISLAND, WA 98040 PARCEL # 082405-9027

DRAWING NAME:

DEMOLITION 1ST FLOOR

Drawn By: JMG,RB Checked By: EB Owner Approval:

PHASE:

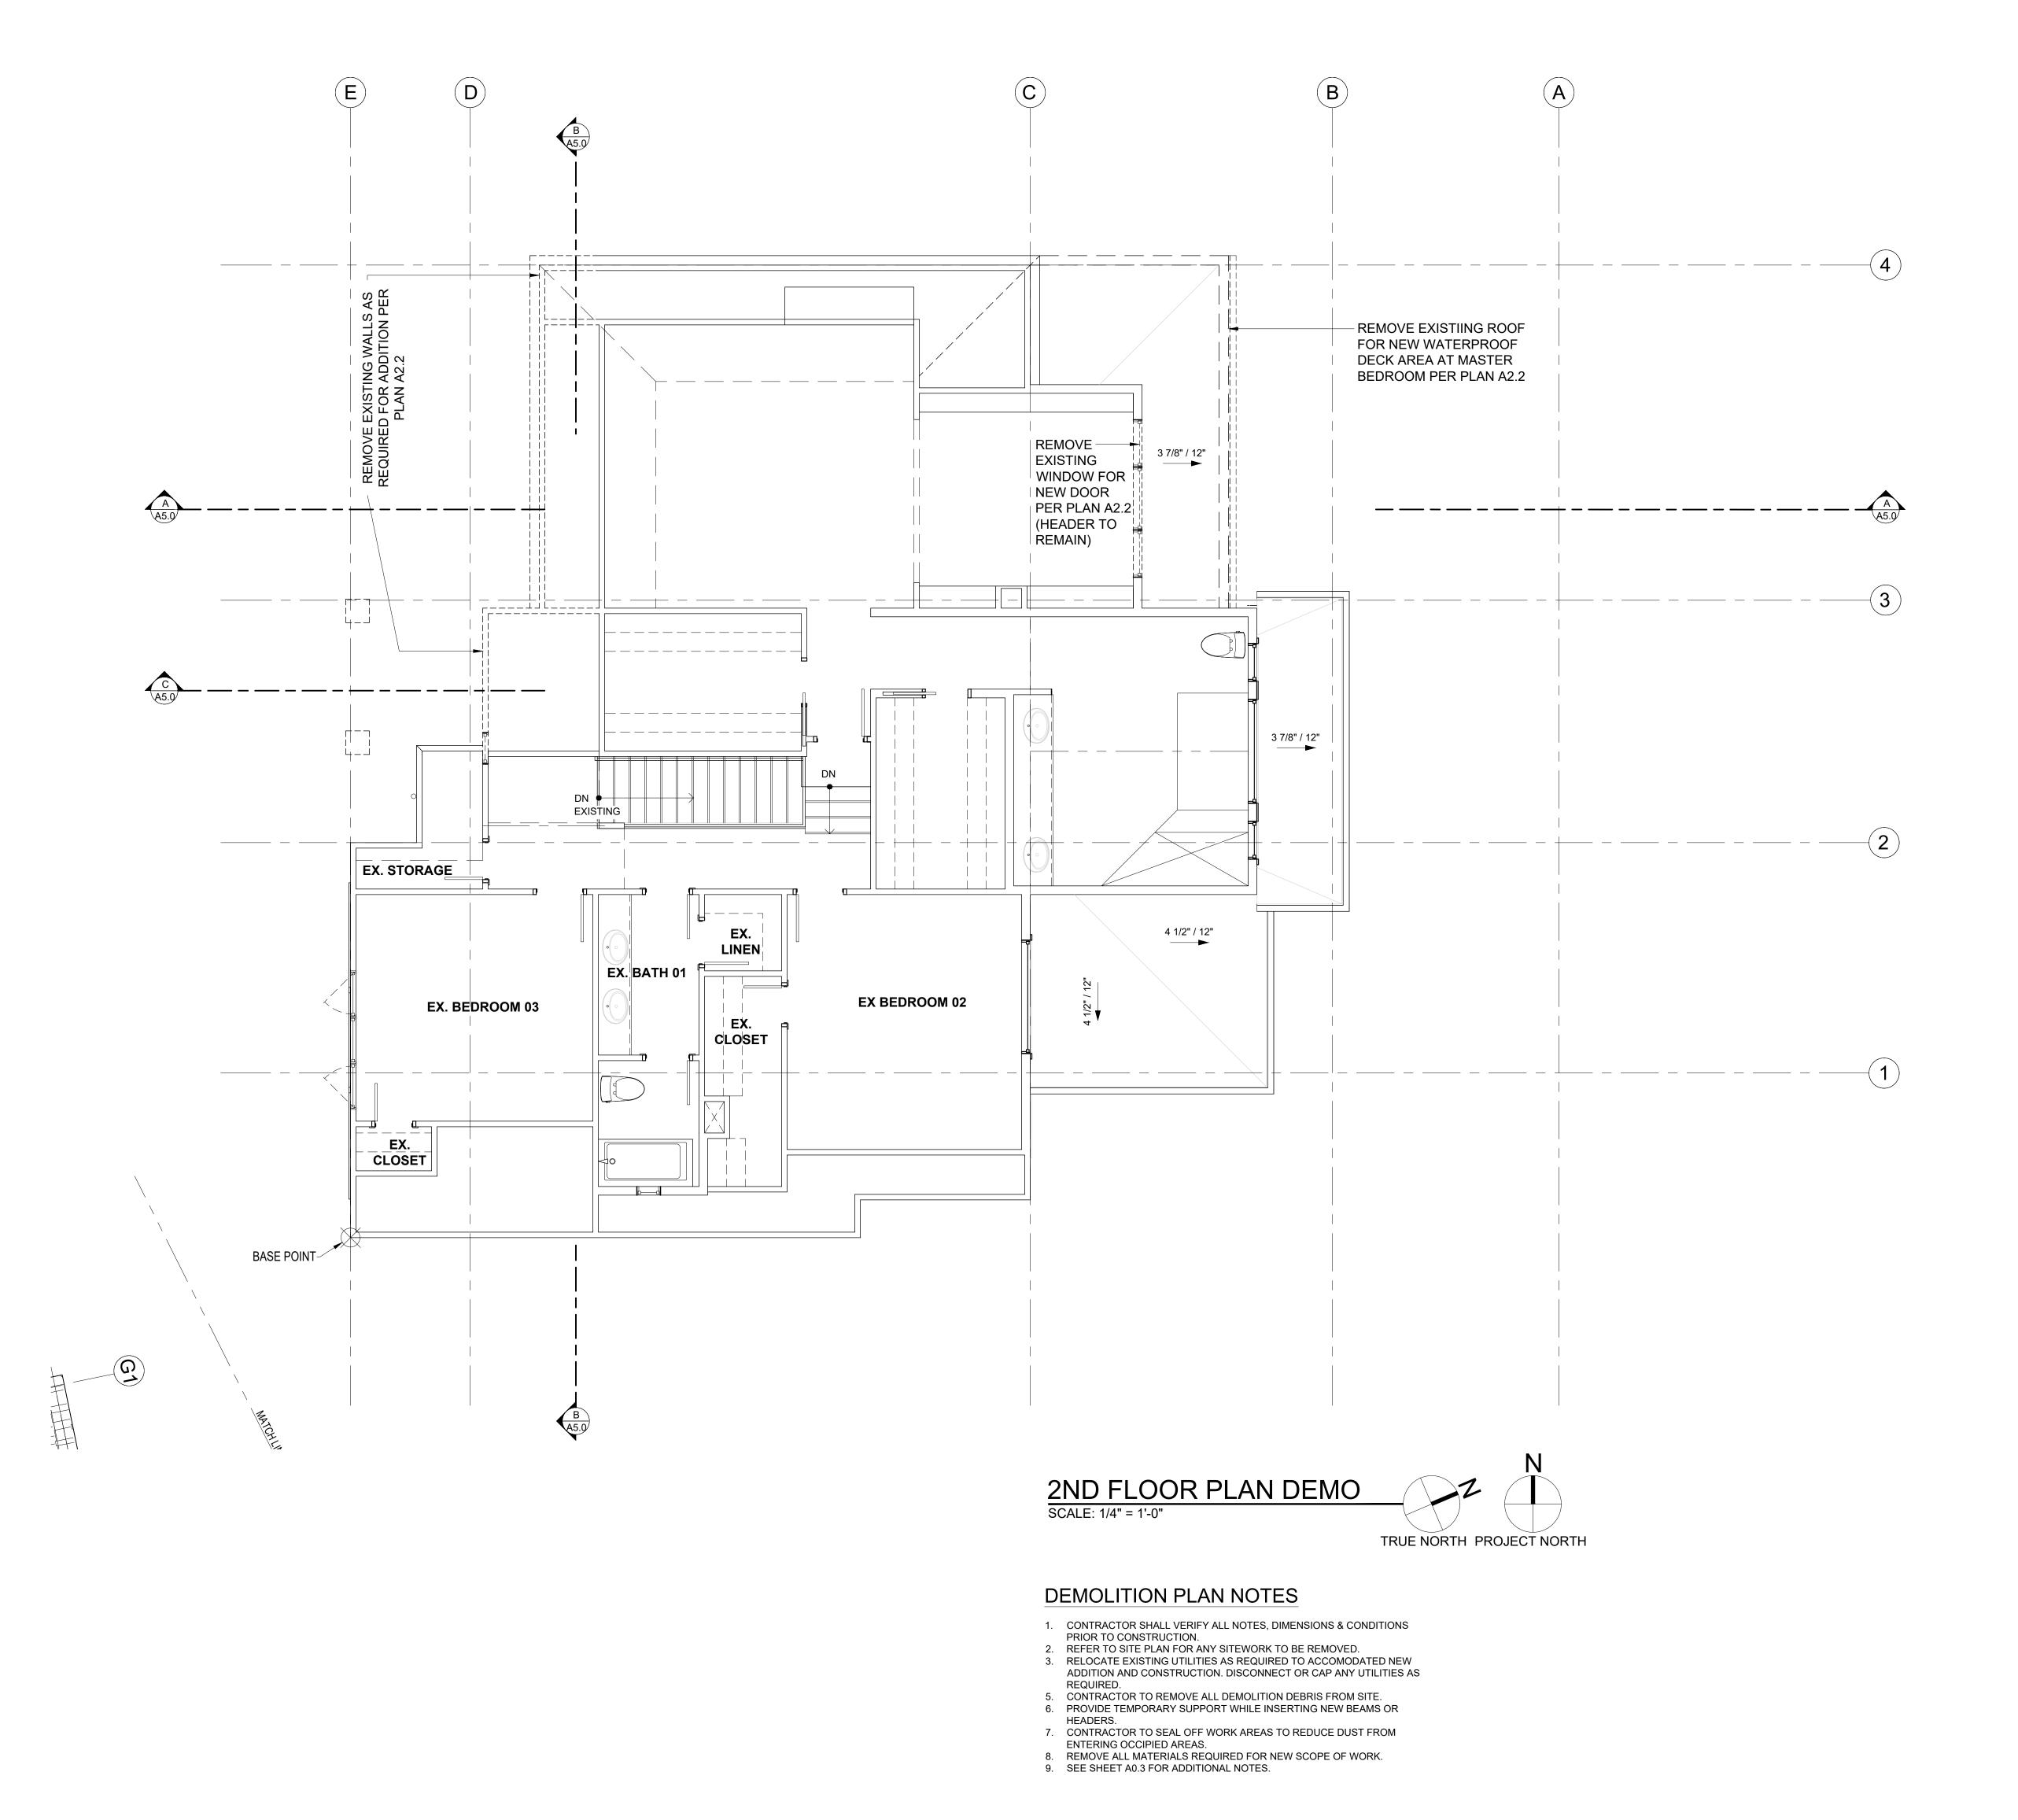
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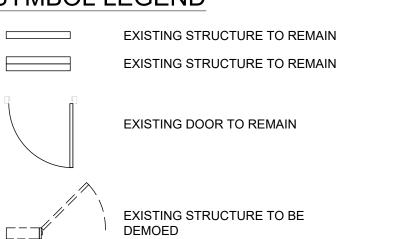
APPROVED FOR CONSTRUCTION:

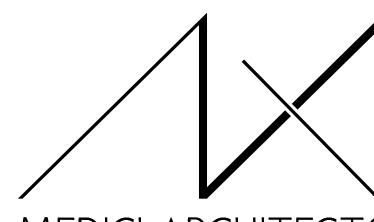
PROJECT No.: 2020 007

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SYMBOL LEGEND



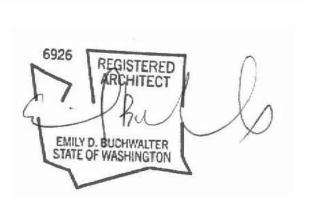


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JOB ADDRESS:

9820 SE 35TH PLACE MERCER ISLAND, WA 98040 PARCEL # 082405-9027

DRAWING NAME:

DEMOLITION 2ND FLOOR

Drawn By: JMG,RB Checked By: EB Owner Approval:

PHASE:

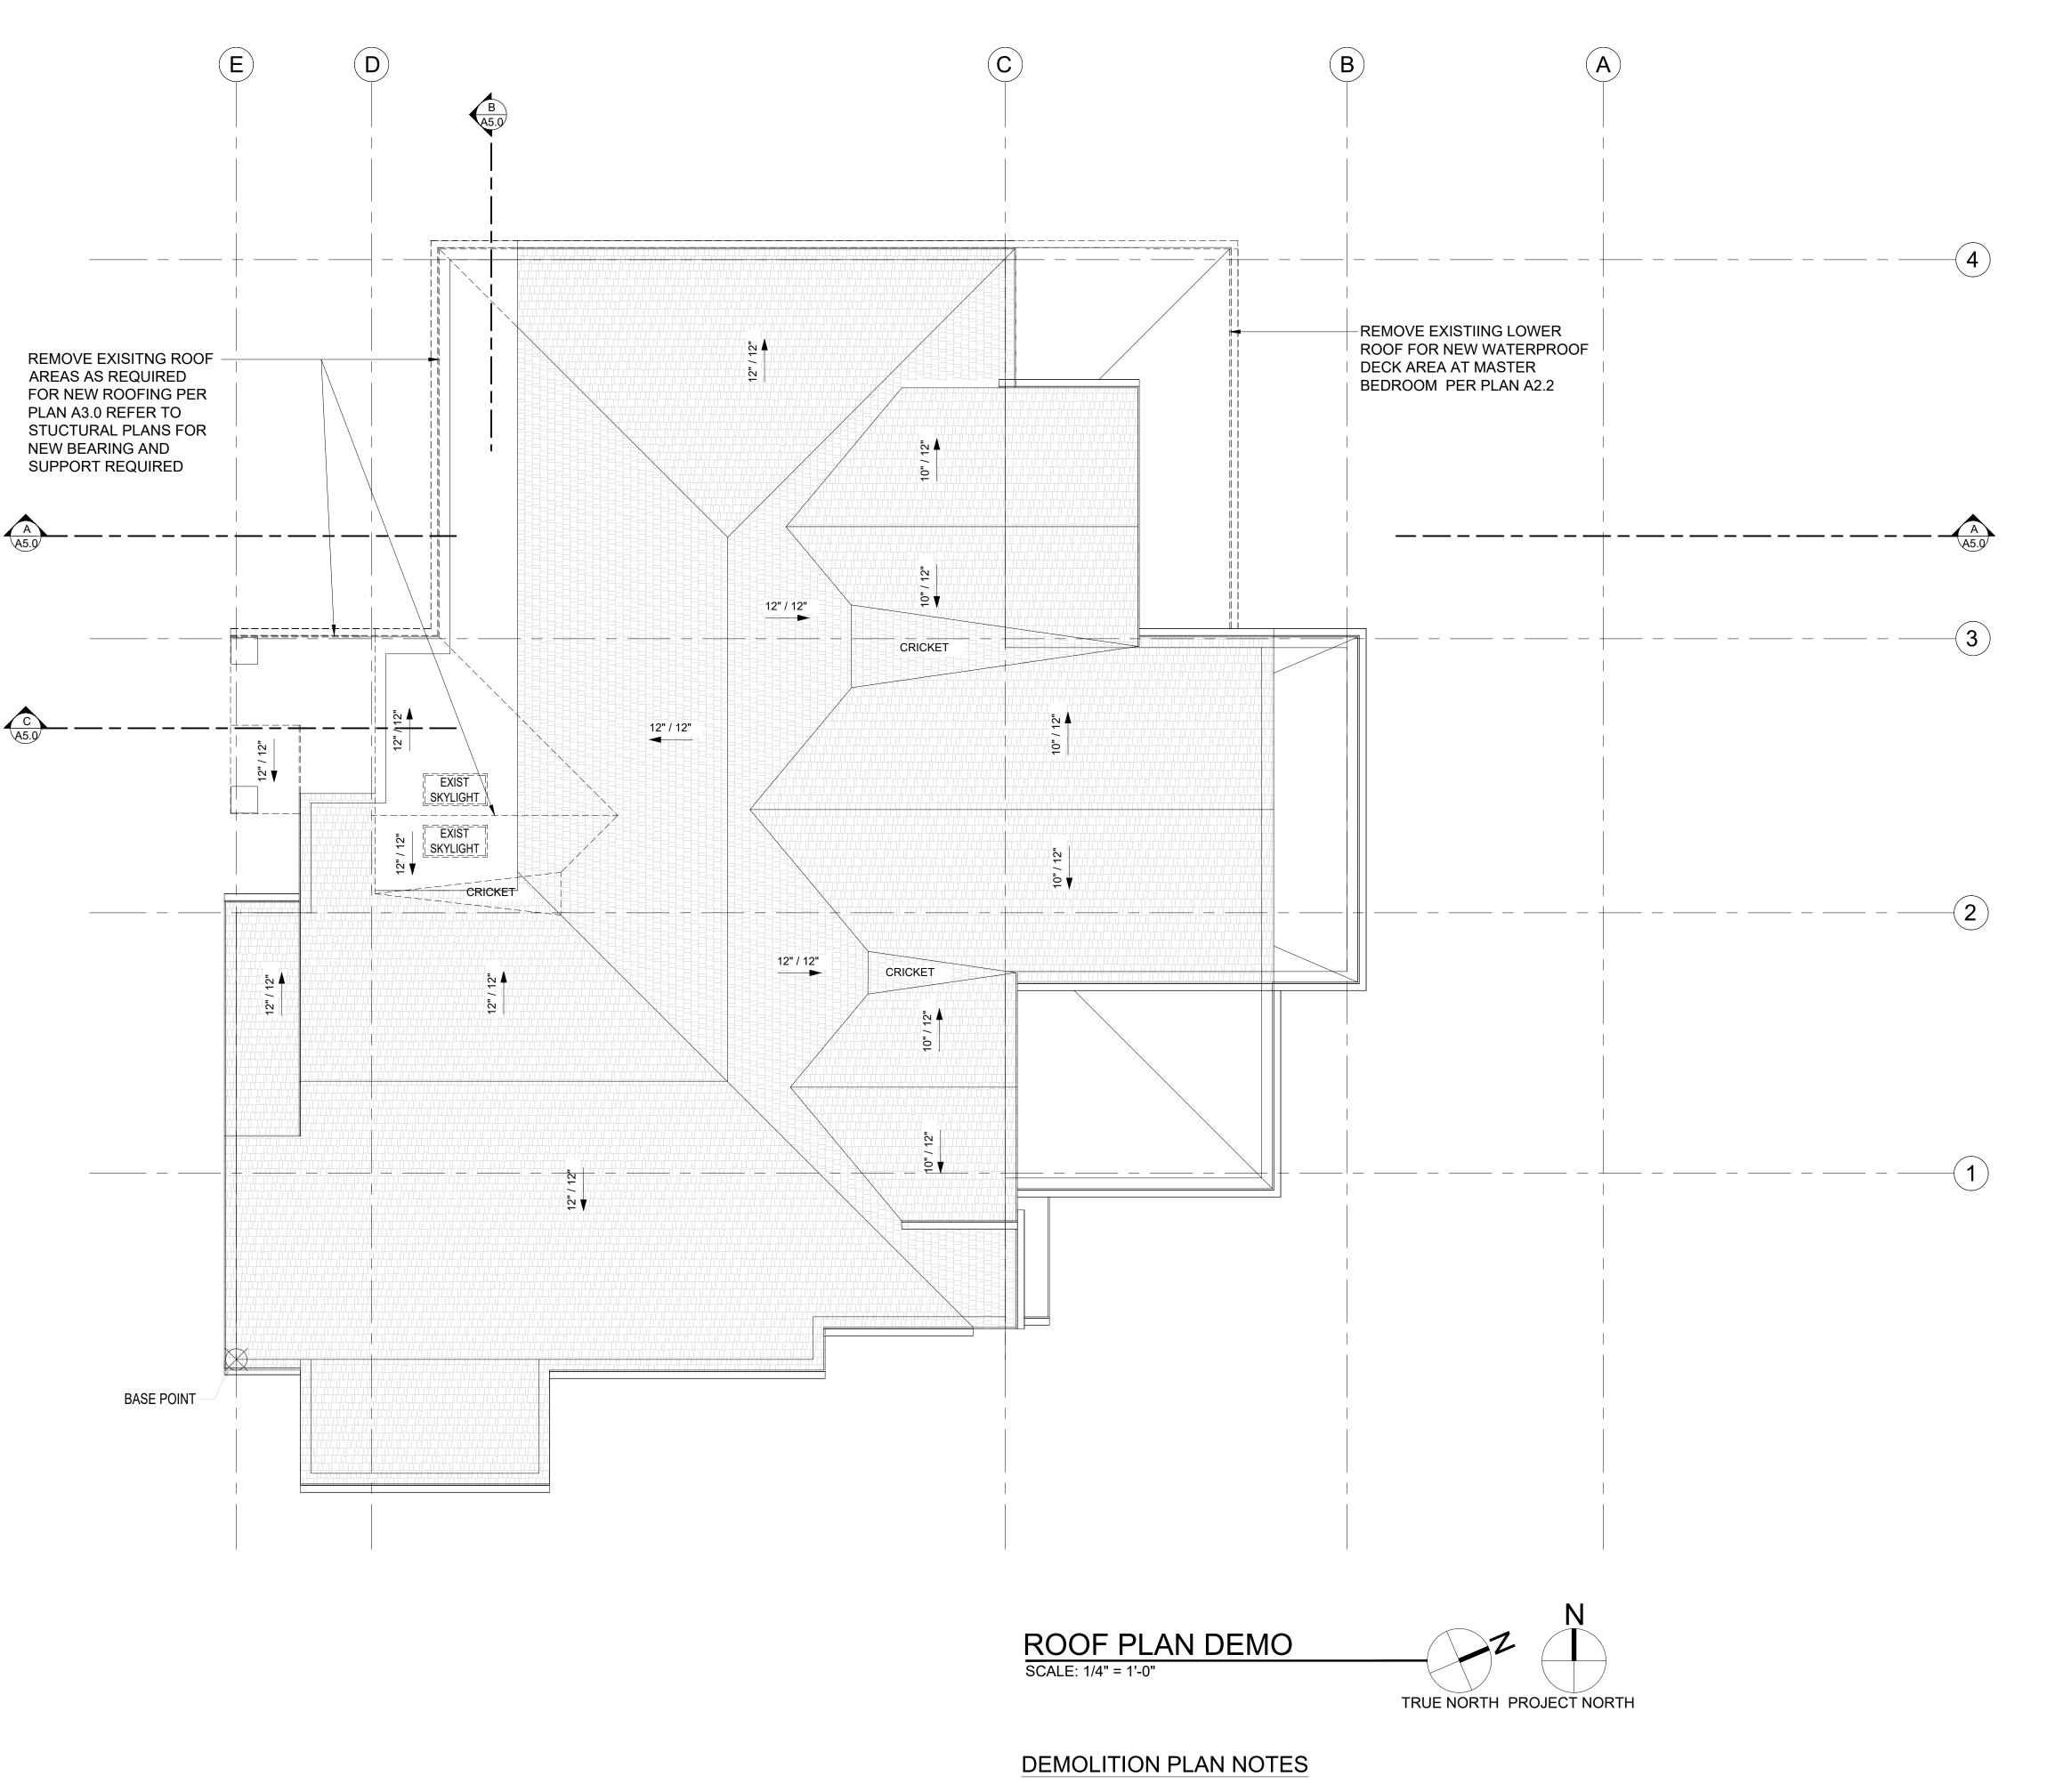
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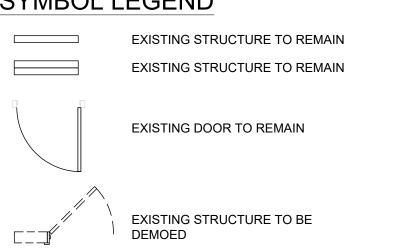
DATE: 12-22-2020



- CONTRACTOR SHALL VERIFY ALL NOTES, DIMENSIONS & CONDITIONS PRIOR TO CONSTRUCTION.
 REFER TO SITE PLAN FOR ANY SITEWORK TO BE REMOVED.
- 3. RELOCATE EXISTING UTILITIES AS REQUIRED TO ACCOMODATED NEW ADDITION AND CONSTRUCTION. DISCONNECT OR CAP ANY UTILITIES AS
- 5. CONTRACTOR TO REMOVE ALL DEMOLITION DEBRIS FROM SITE.6. PROVIDE TEMPORARY SUPPORT WHILE INSERTING NEW BEAMS OR
- HEADERS. 7. CONTRACTOR TO SEAL OFF WORK AREAS TO REDUCE DUST FROM
- ENTERING OCCUPIED AREAS.

 8. REMOVE ALL MATERIALS REQUIRED FOR NEW SCOPE OF WORK. 9. SEE SHEET A0.3 FOR ADDITIONAL NOTES.

SYMBOL LEGEND

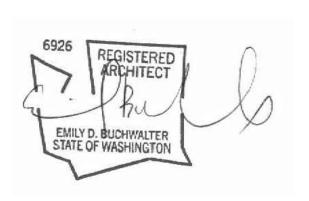




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JOB ADDRESS:

9820 SE 35TH PLACE MERCER ISLAND, WA 98040 PARCEL # 082405-9027

DRAWING NAME:

DEMOLITION

ROOF

Drawn By: JMG,RB Checked By: EB Owner Approval:

PHASE:

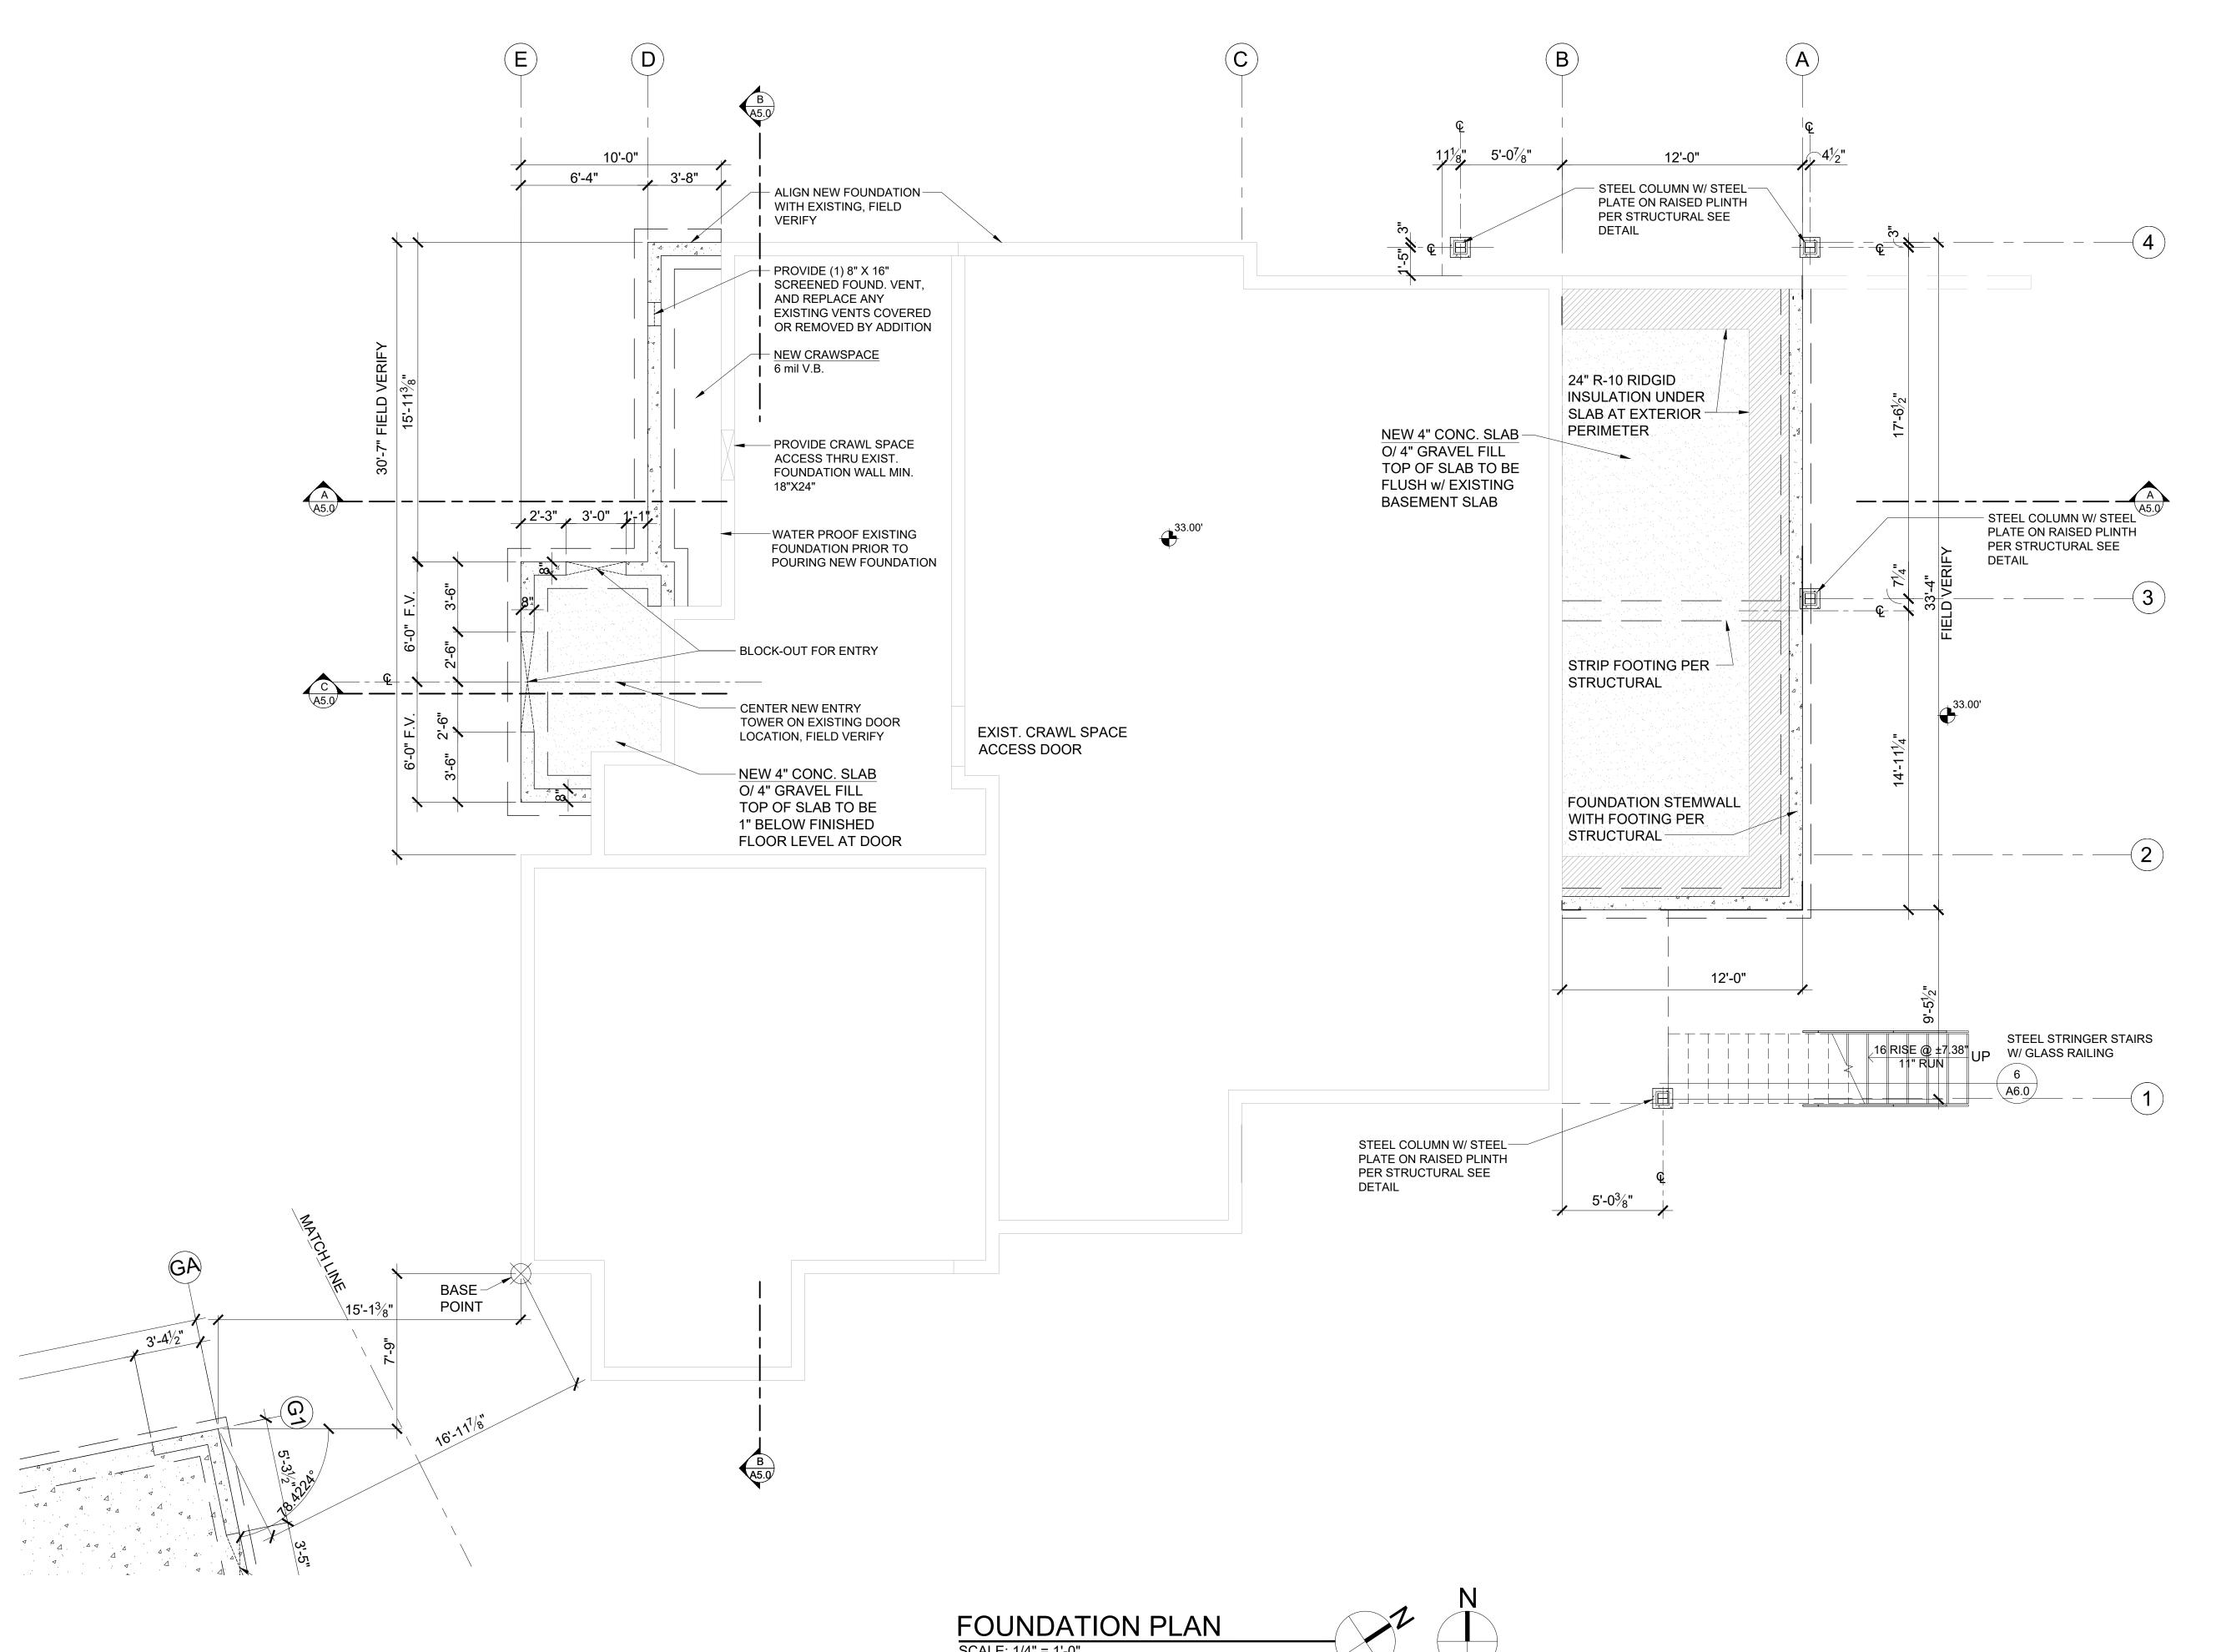
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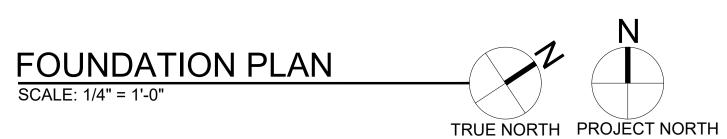
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DATE: 12-22-2020





CRAWL SPACE - VENTILATION CALCULATION				
Added Crawl Space Area:	51	s.f.		
Ventilation Required:	51	s.f. x 144 s.i.1 /1,500*=	4.9	s.i. Req'd
Use:	16"x8"	Foundation Vents		
Vent Area =	98.0	s.l 25% reduction + 1/4" mesh	73.5	s.l.
Number of vents required:	4.9	s.l. / vent area	0.1	vents
Provide:	1.0		73.5	Provided
Total Min. Ventilation Provided =	73.5	s.i. IS GREATER THAN	4.9	s.i. Req'd

* 2015 IRC - PER R408.1 THE TOTAL AREA OF VENTILATION OPENINGS SHALL BE PERMITTED TO BE REDUCED TO 1/1,500 OF THE UNDER-FLOOR AREA WHERE THE GROUND SURFACE IS COVERED WITH AN APPROVED CLASS I VAPOR RETARDER MATERIAL AND THE REQUIRED OPENINGS ARE PLACED TO PROVIDE CROSS VENTILATION OF THE SPACE

SYMBOL	LEGEND
	EXIST.FOUNDATION WALL
Δ Δ	SLAB ON GRADE
0	NEW FOUNDATION WALL w/ FOOTING
\boxtimes	POST - VERIFY SIZE AND TYPE WITH STRUCTURAL PLAN
	CRAWL SPACE VENT

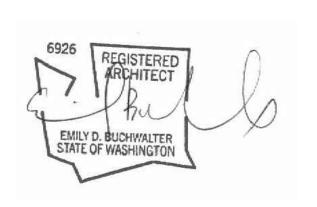


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9820 SE 35TH PLACE

PROJECT / CLIENT:

ACHIN & MARY CHEN 9820 SE 35TH PLACE MERCER ISLAND, WA 98040

JOB ADDRESS: 9820 SE 35TH PLACE MERCER ISLAND, WA 98040

PARCEL # 082405-9027

DRAWING NAME:

FOUNDATION PLAN

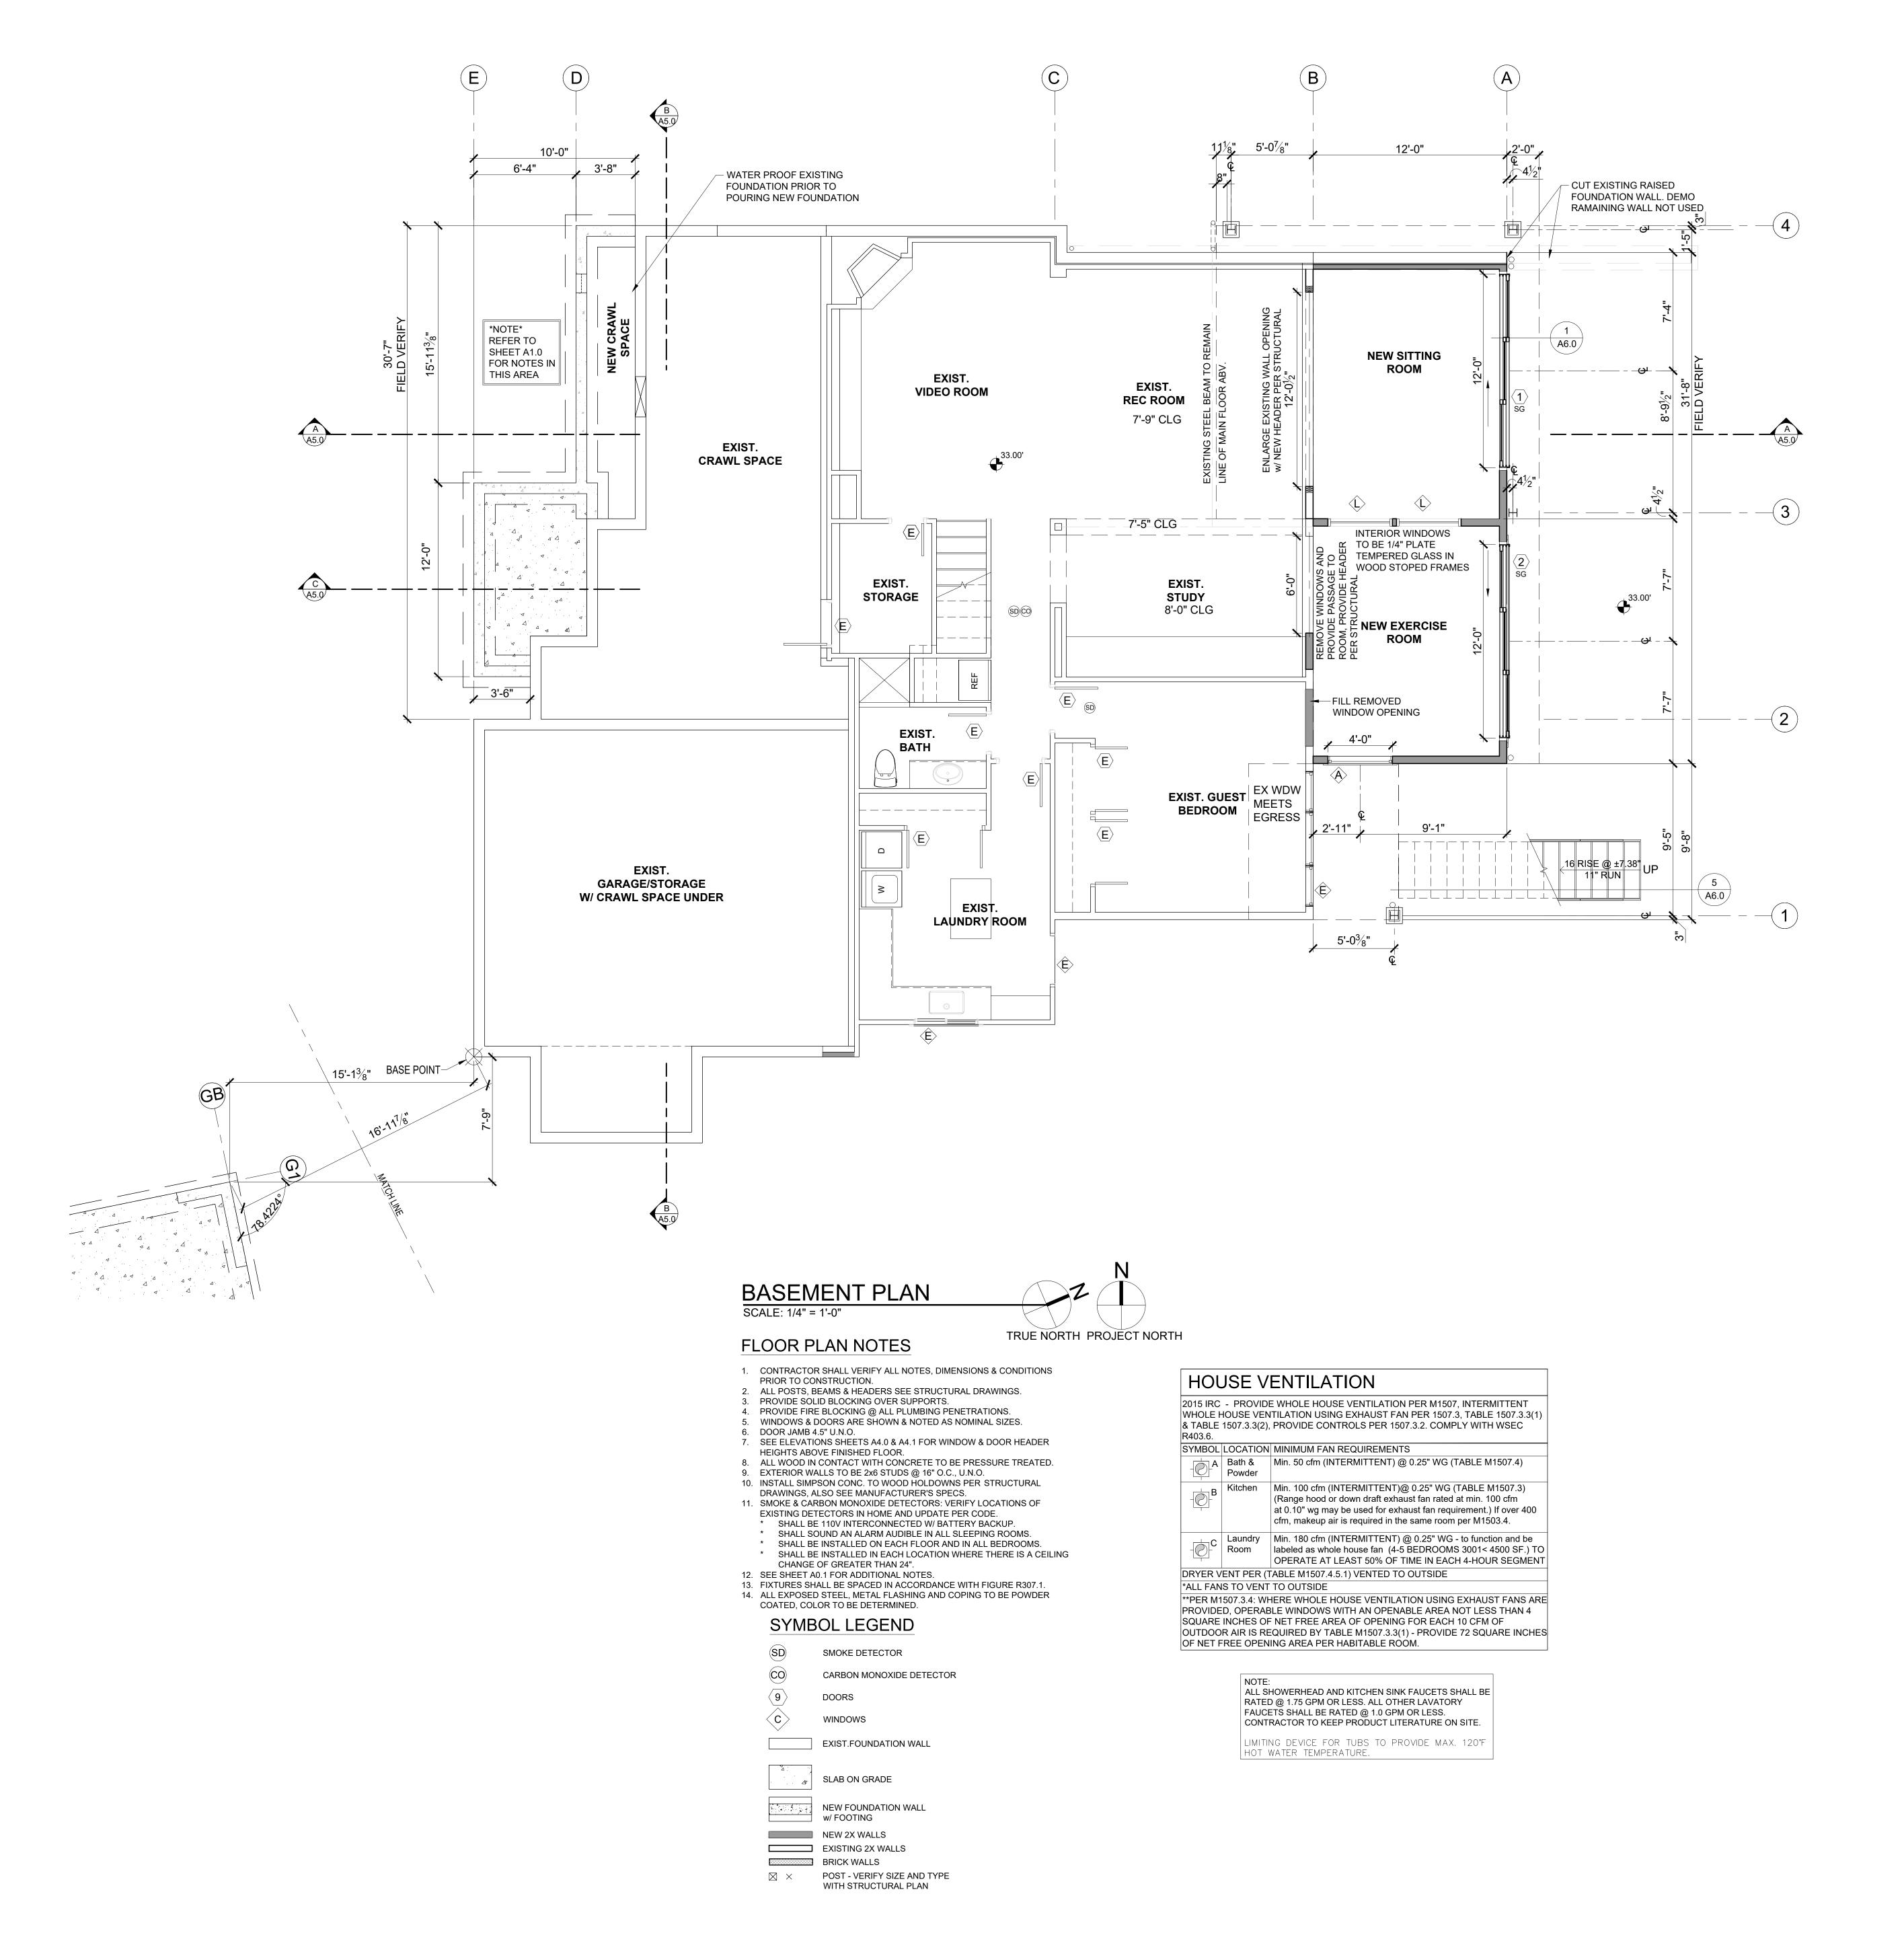
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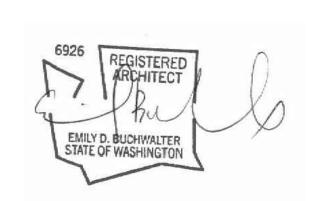


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9820 SE 35TH PLACE

ACHIN & MARY CHEN 9820 SE 35TH PLACE MERCER ISLAND, WA 98040

JOB ADDRESS:

PROJECT / CLIENT:

9820 SE 35TH PLACE MERCER ISLAND, WA 98040 *PARCEL* # 082405-9027

DRAWING NAME:

BASEMENT CONSTRUCTION PLAN

Drawn By: JMG,RB
Checked By: EB
Owner Approval:

PHASE:

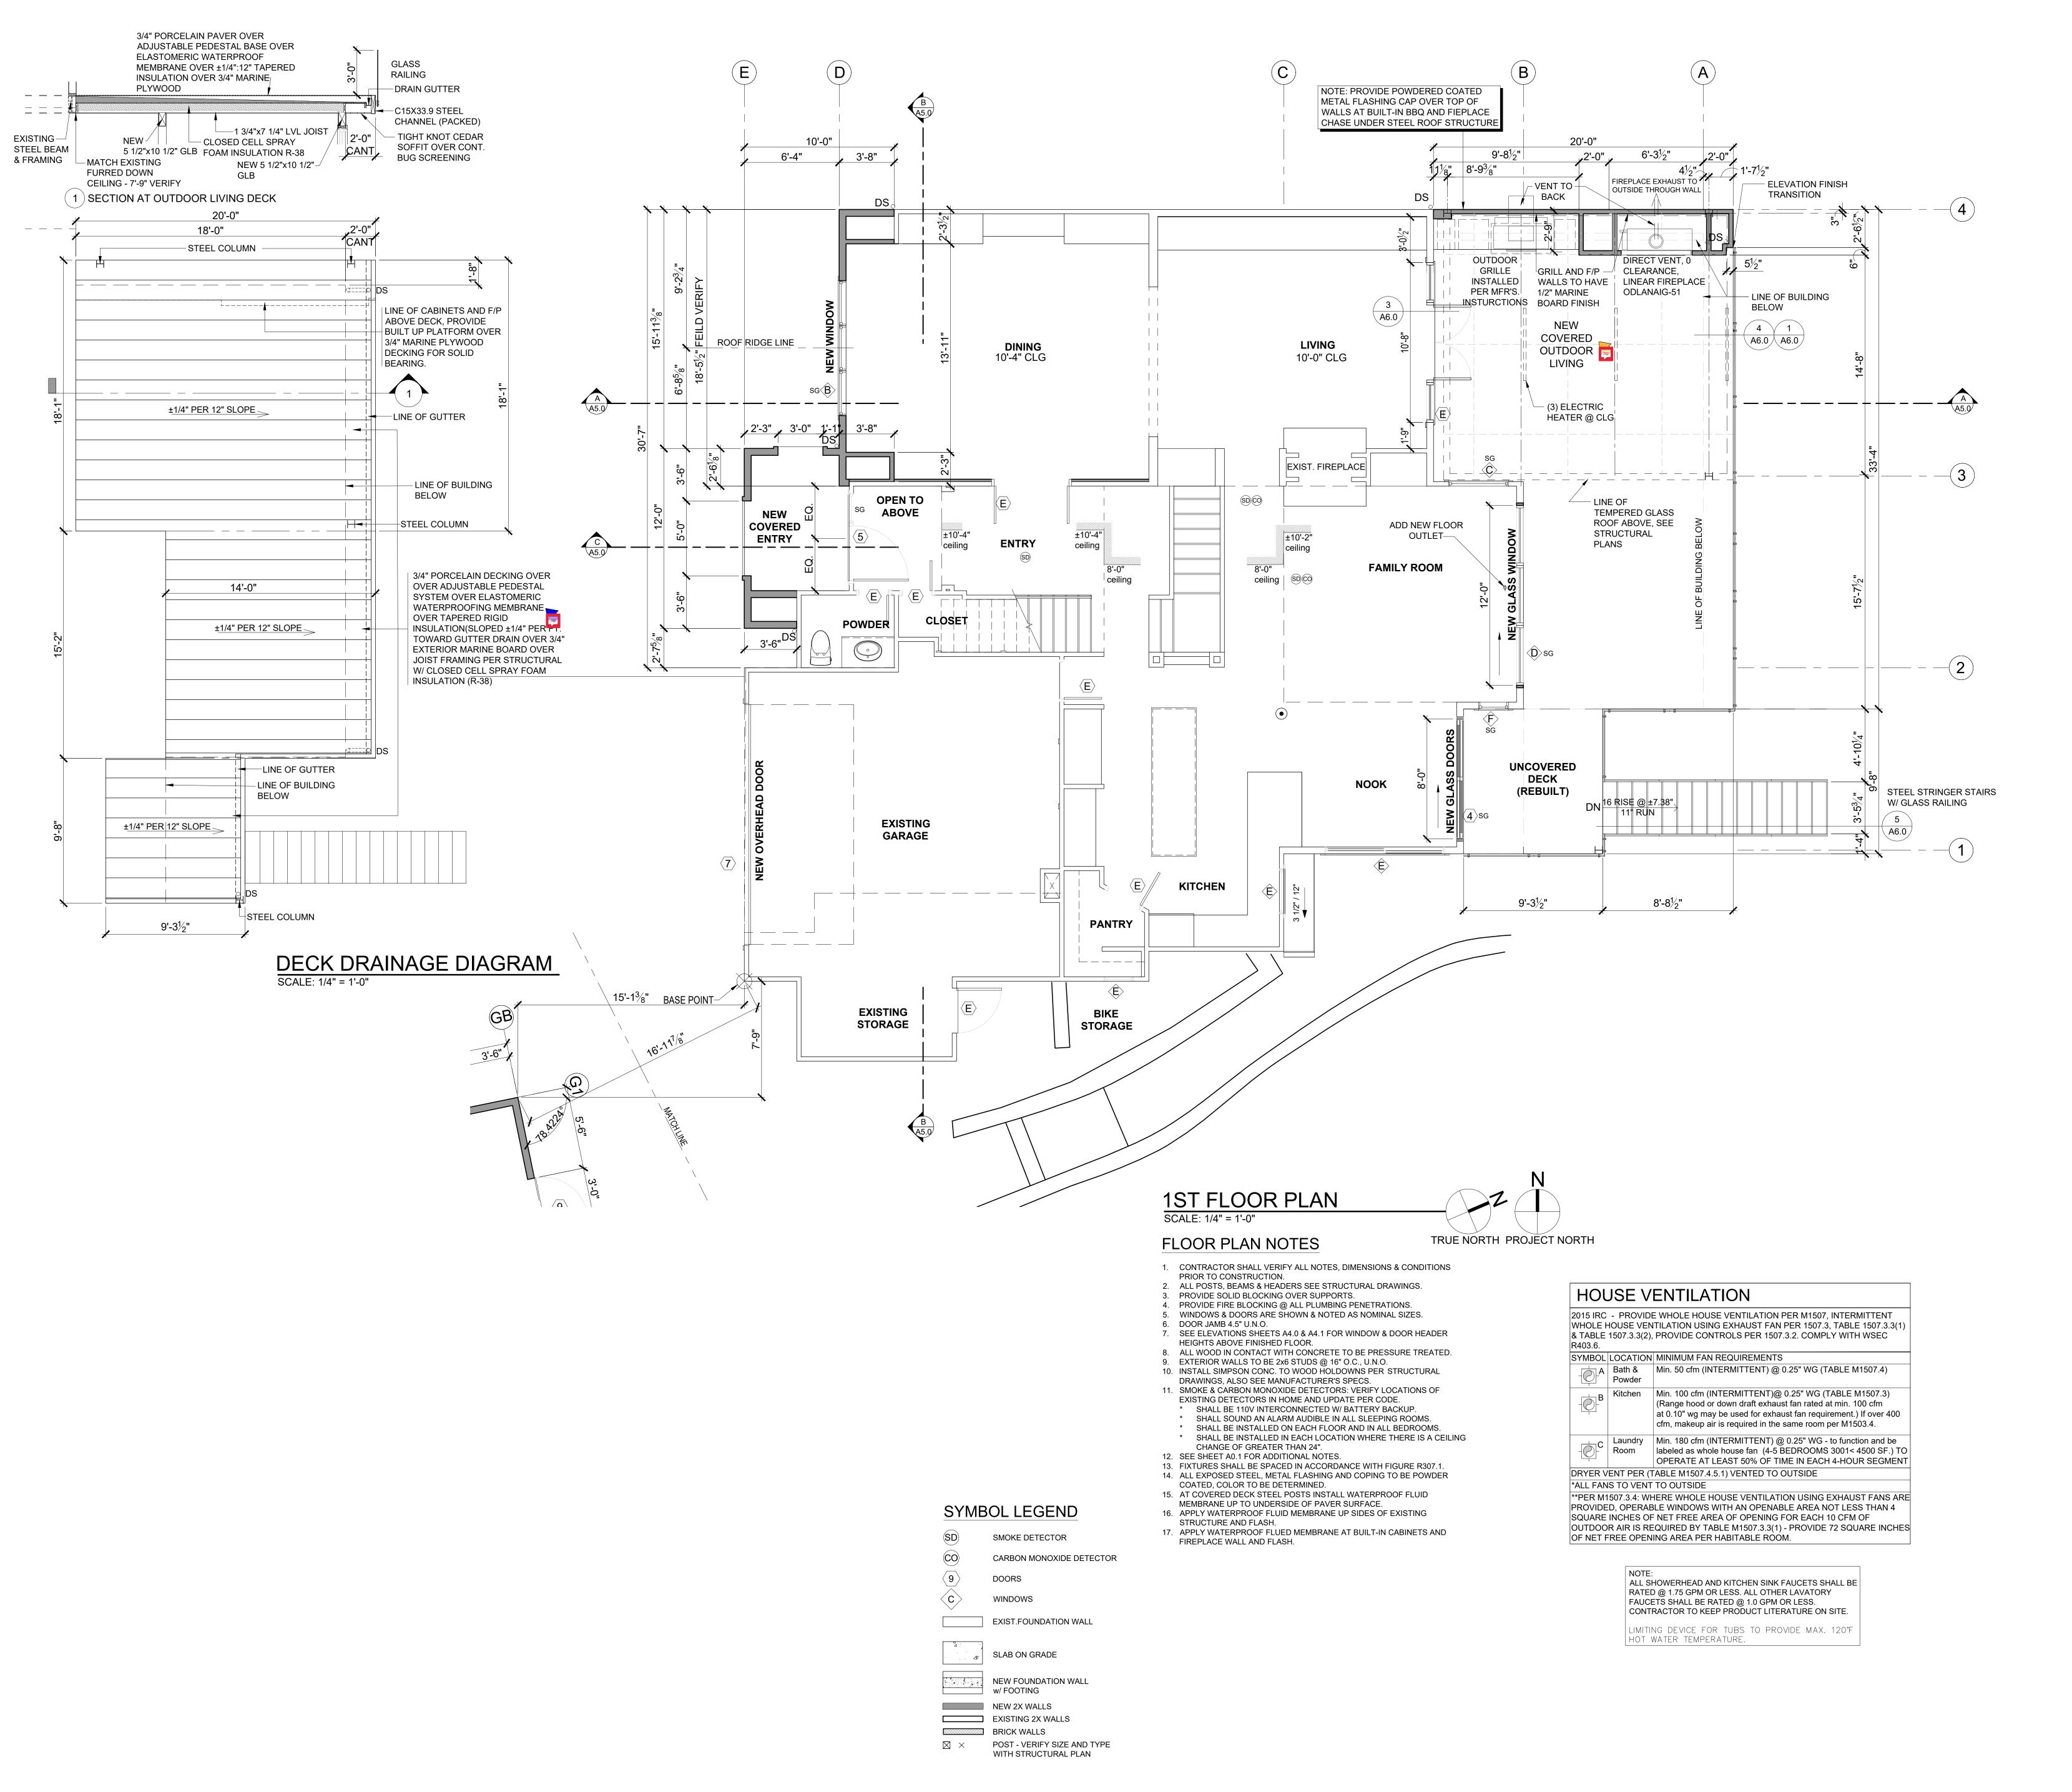
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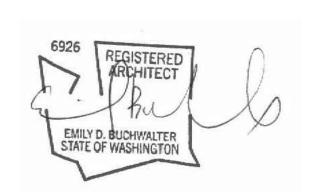
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ACHIN & MARY CHEN 9820 SE 35TH PLACE MERCER ISLAND, WA 98040

PROJECT / CLIENT:

JOB ADDRESS:

9820 SE 35TH PLACE
MERCER ISLAND, WA 98040

PARCEL # 082405-9027

DRAWING NAME:

1ST FLOOR CONSTRUCTION PLAN

Drawn By: JMG,RB
Checked By: EB
Owner Approval:

PHASE:

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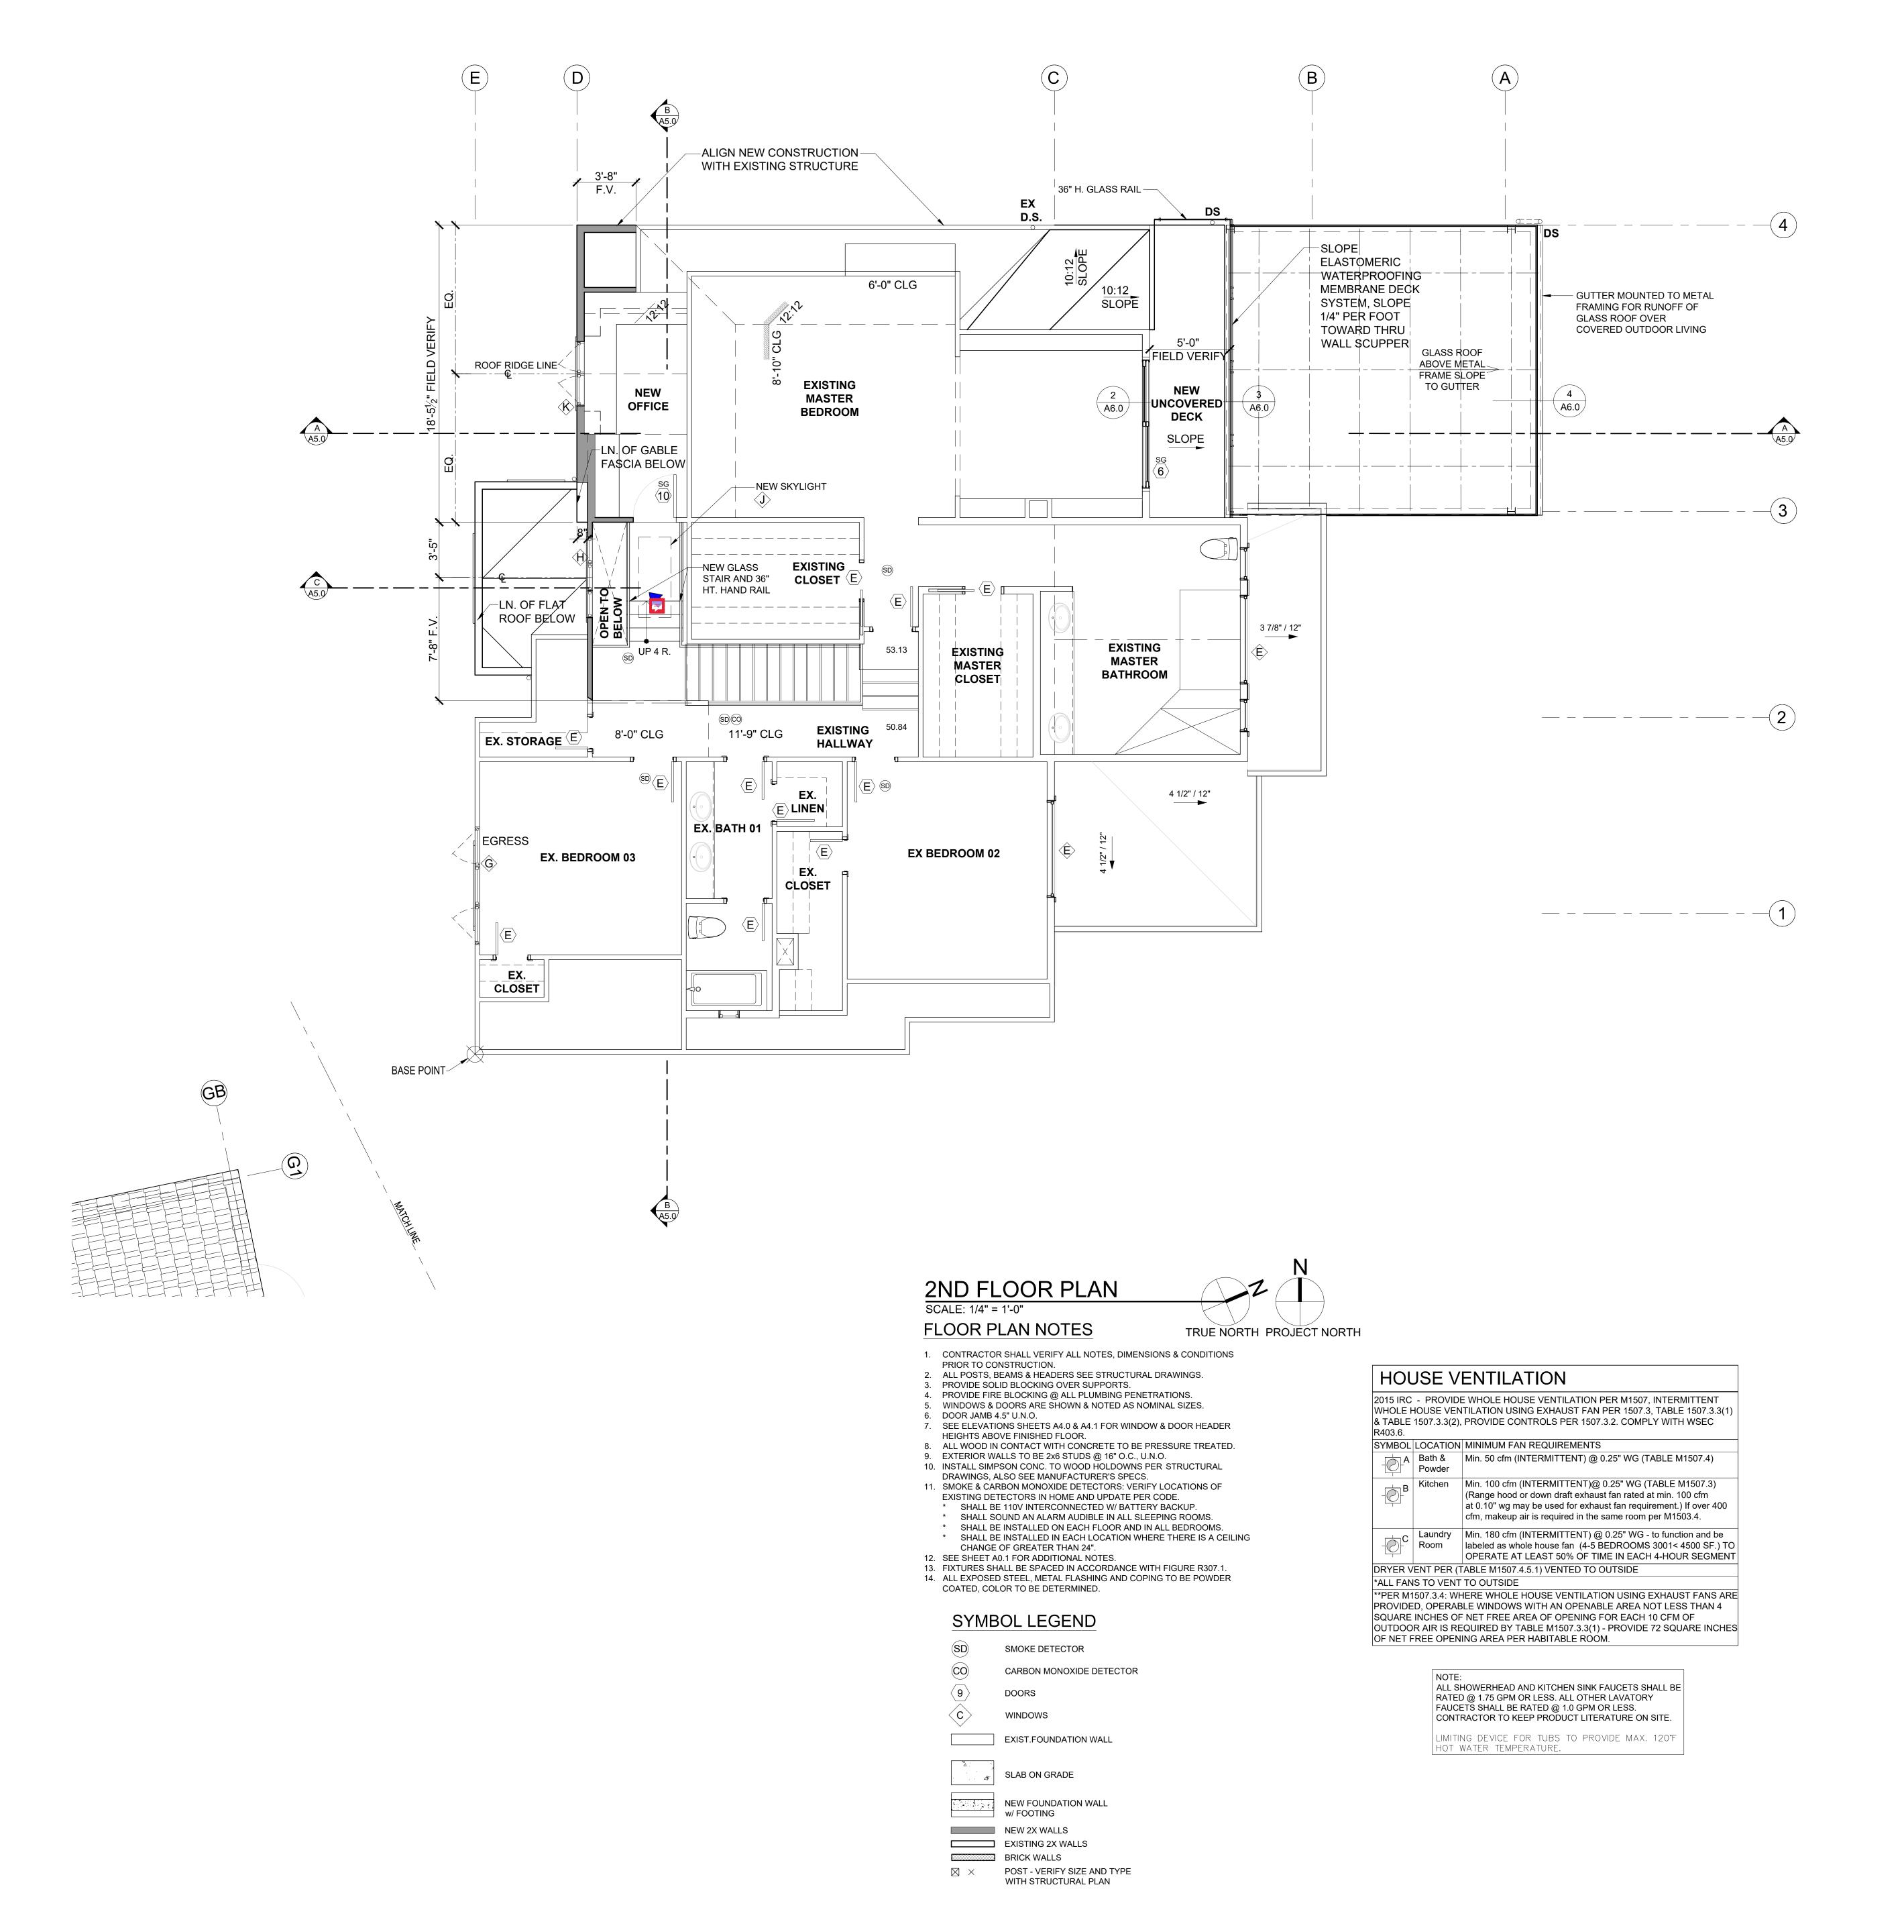
PROJECT No.: 2020 007

DATE:

12-22-2020

PLOT SCALE: 1:1

Δ2



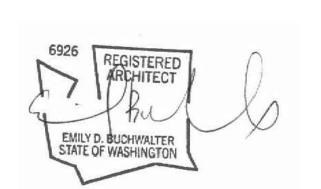
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JOB ADDRESS:

ACHIN & MARY CHEN

9820 SE 35TH PLACE

9820 SE 35TH PLACE MERCER ISLAND, WA 98040 PARCEL # 082405-9027

DRAWING NAME:

2ND FLOOR CONSTRUCTION PLAN

Drawn By: JMG,RB Checked By: EB

PHASE:

Owner Approval:

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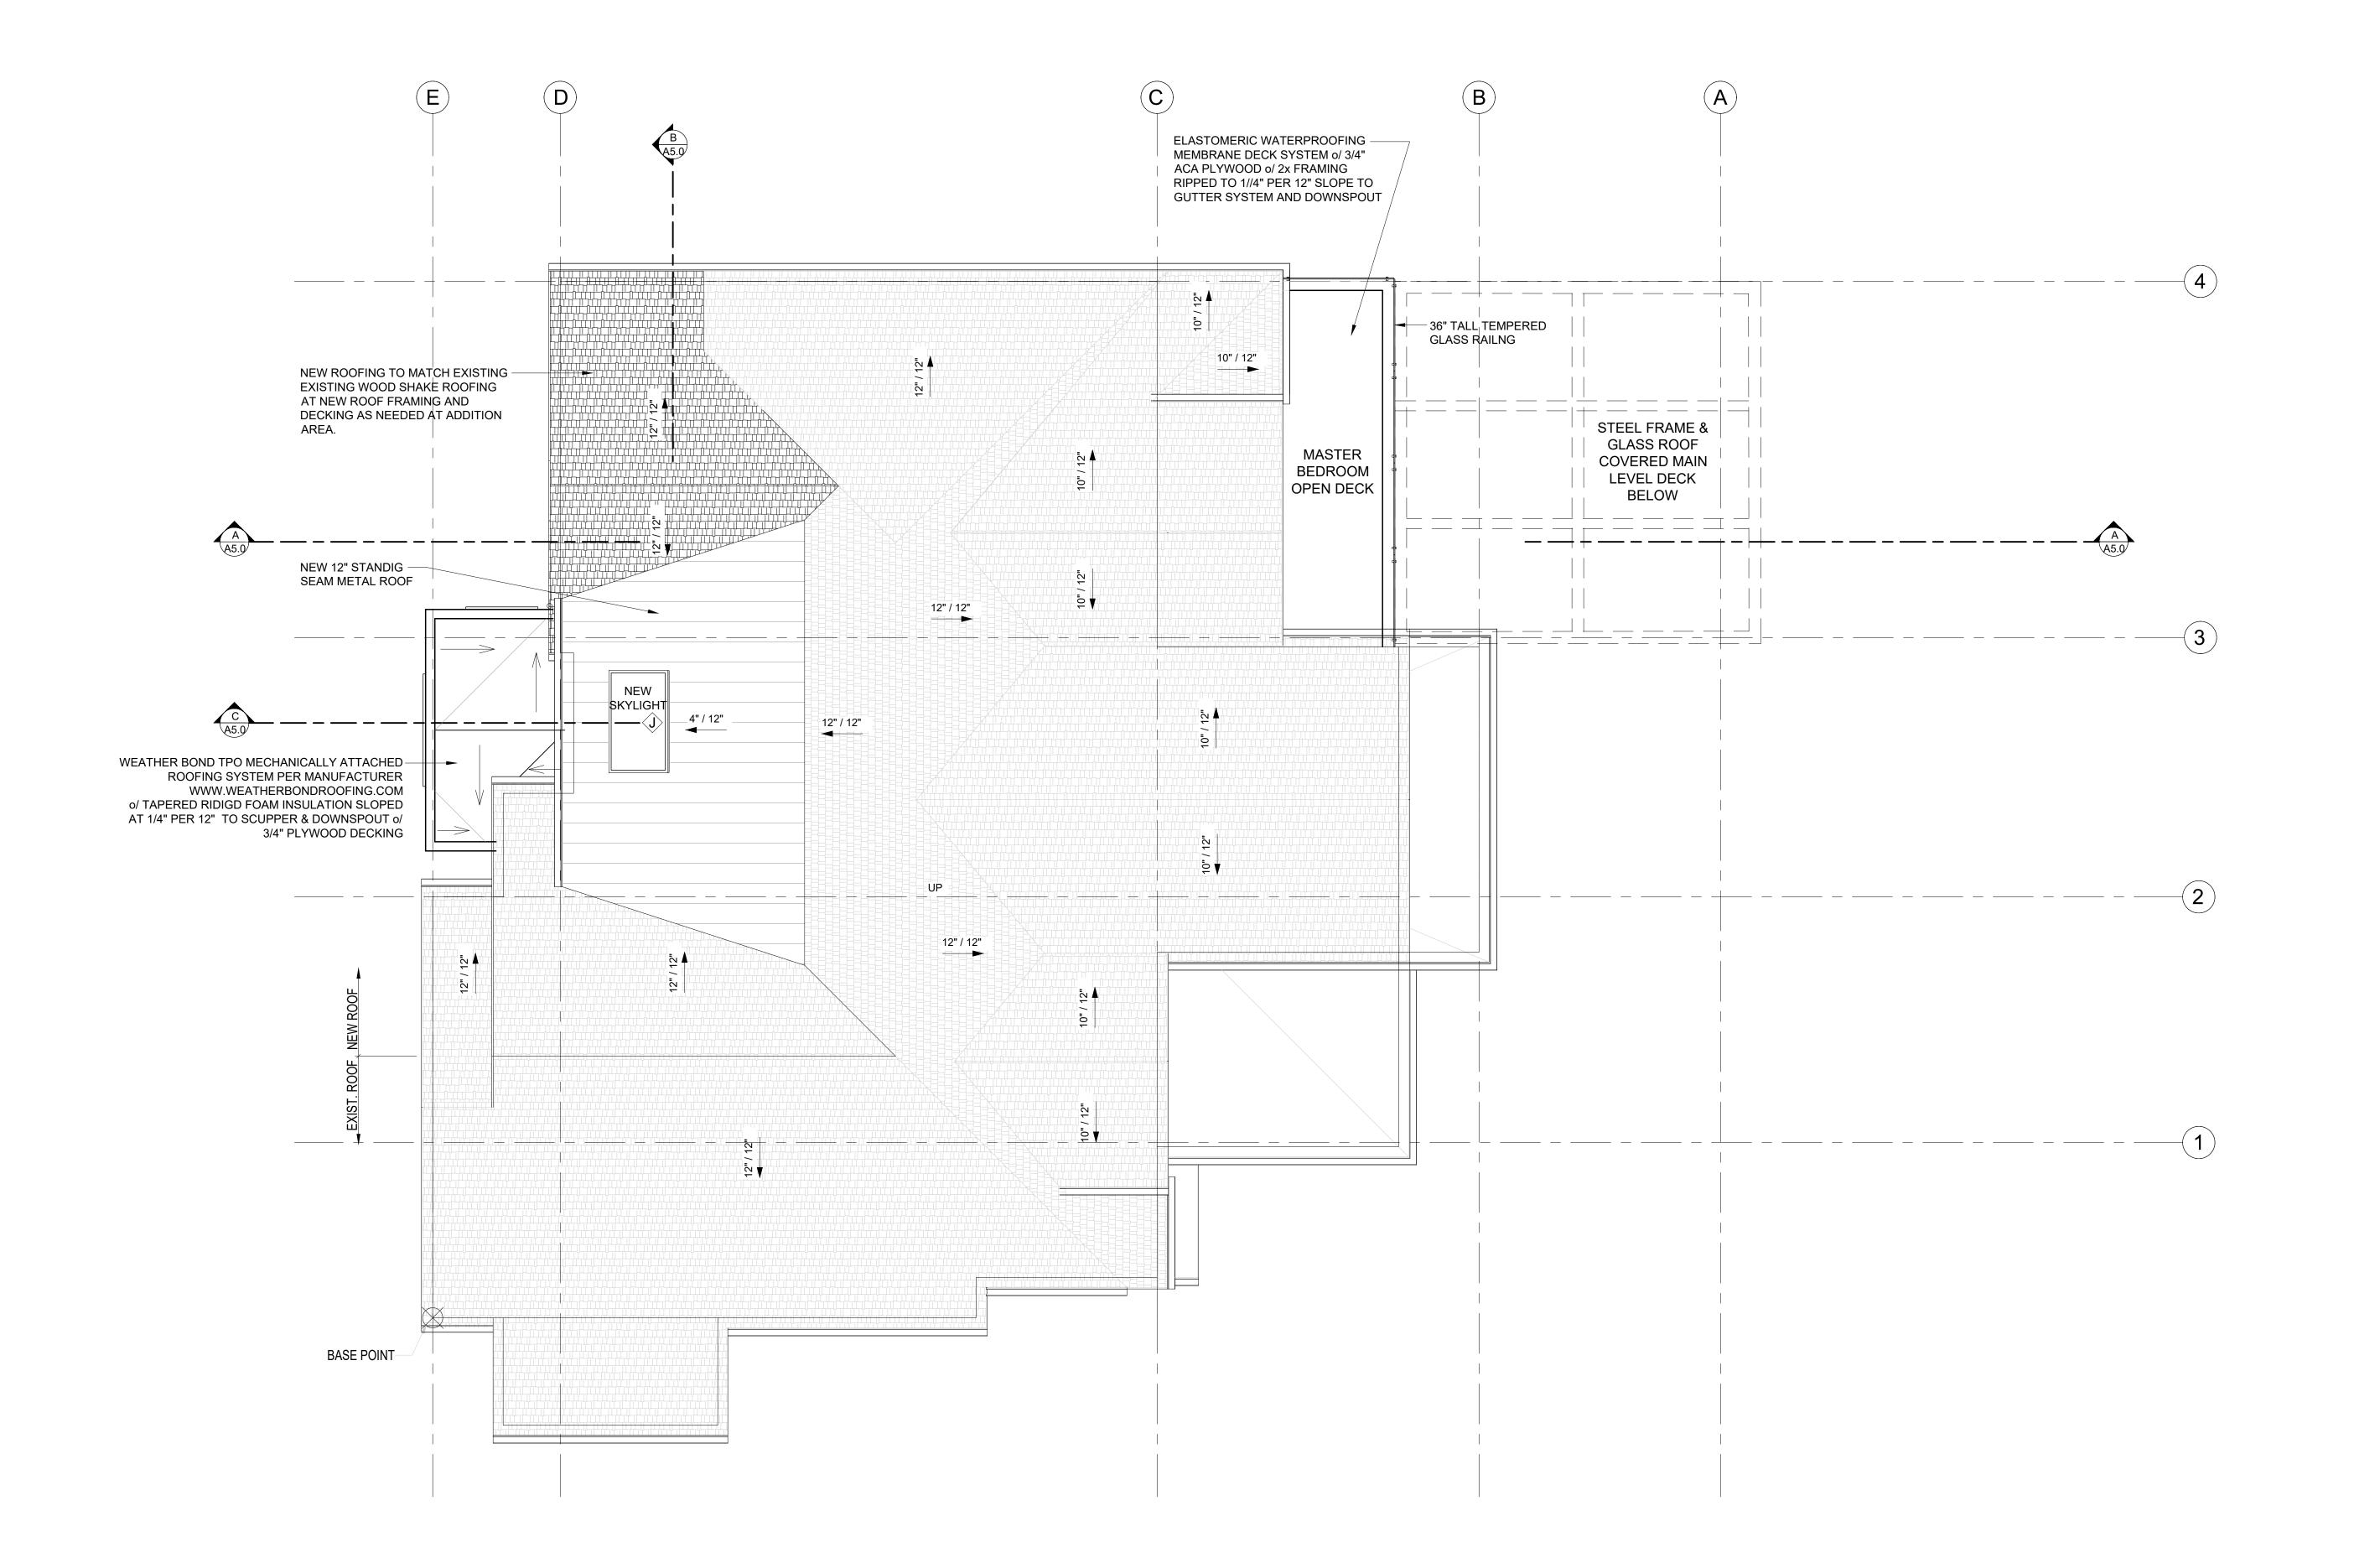
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PROJECT No.: 2020 007

DATE: 12-22-2020

PLOT SCALE: 1:1

1



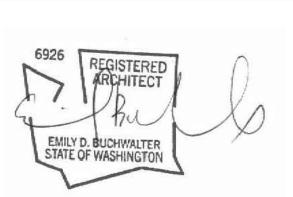


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JOB ADDRESS: 9820 SE 35TH PLACE MERCER ISLAND, WA 98040 PARCEL # 082405-9027

ROOF PLAN SCALE: 1/4" = 1'-0"

ROOF - VENTILATION CALCULATION

356.7 s.f.

356.7 s.f. x 144 s.i. / 300*=

20.0 I.f. Upper Ventilation =

180.0 s.i. IS GREATER THAN

20.0 I.f. Eave Edge Ventilation =

4.5 s.i. nfa / l.f.=

4.5 s.i. nfa / l.f. =

Stick built Roof Construction:

SmartVent Shingle vent (upper or ridge)

SmartVent Shingle vent (lower roof edge)

Roof Area:

Provide:

Ventilation Required:

Proposed Ventilation:

Total Ventilation Provided



171.2 s.i. Req'd

4.5 s.i. / l.f.

171.2 s.i. Req'd

90.0 s.i.

4.5 s.i.

90.0

ROOF PLAN

DRAWING NAME:

Checked By: EB
Owner Approval:
PHASE:

APPROVED FOR CONSTRUCTION:

PROJECT No.: 2020 007 DATE: 12-22-2020

A3.0 PLOT SCALE: 1:1

ELEVATIONS NOTES & KEY NOTES:

- 1. VERIFY SHEAR WALL NAILING & HOLDOWNS PER STRUCTURAL PLAN & SCHEDULE PRIOR TO INSTALLING SIDING.
- 2. MATCH EXISTINGCEDAR SINDING PROFILE AND EXPOSURE, PAINT TO MATCH. INTERWEAVE NEW CEDDAR SIDING TO OLD AND EXTEND VAPOR BARIOR MINIMUM OF 6 INCHES. TRANSITIONS TO BE SEAMLESS.
- 3. CAULK ALL EXTERIOR JOINTS & PENETRATIONS.

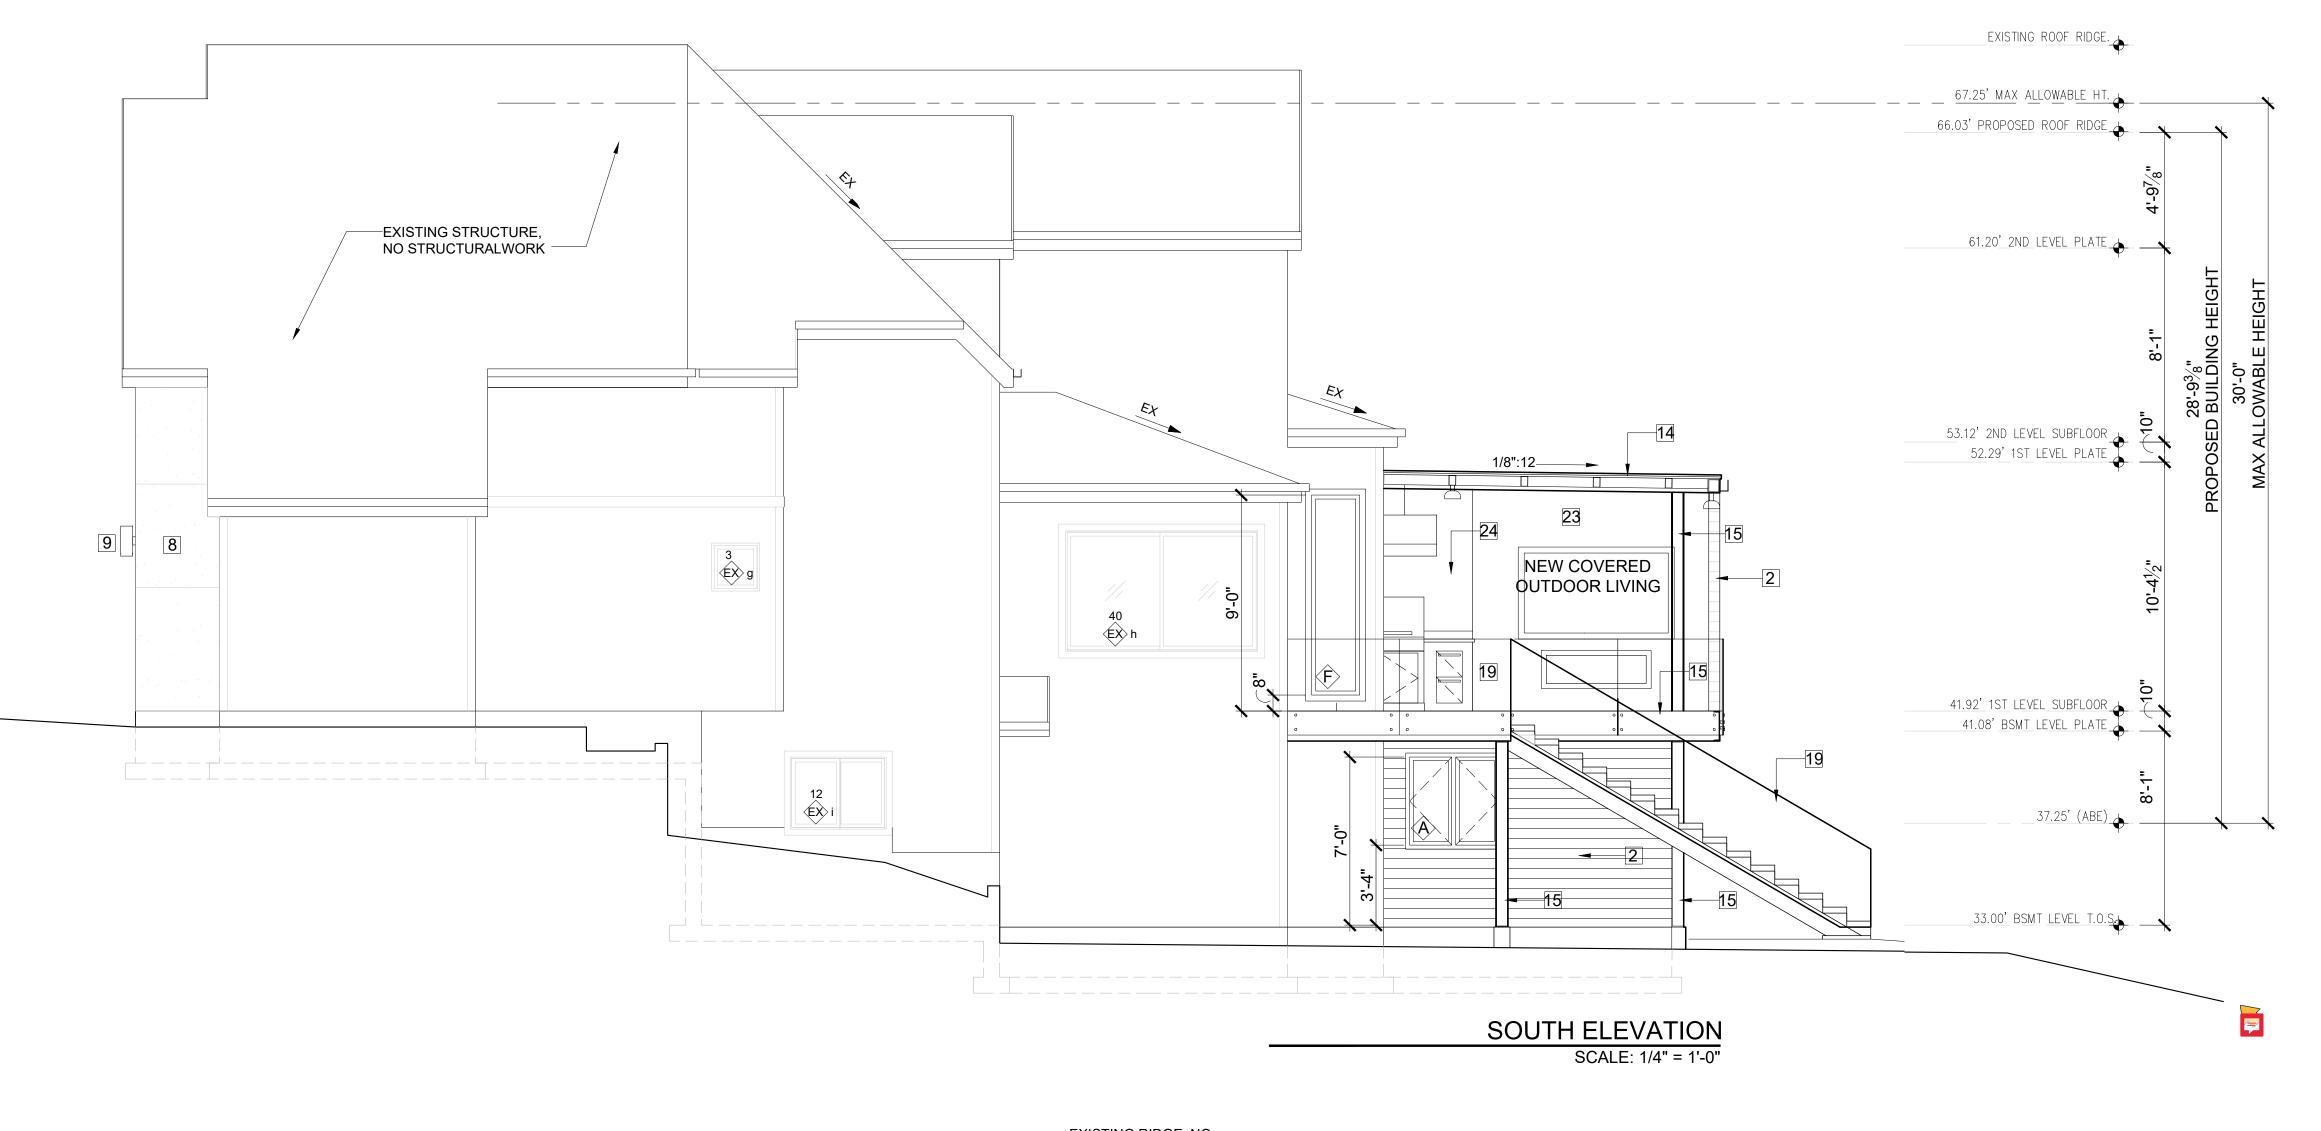
PENETRATIONS PER I.R.C. R903.2 & R903.2.1.

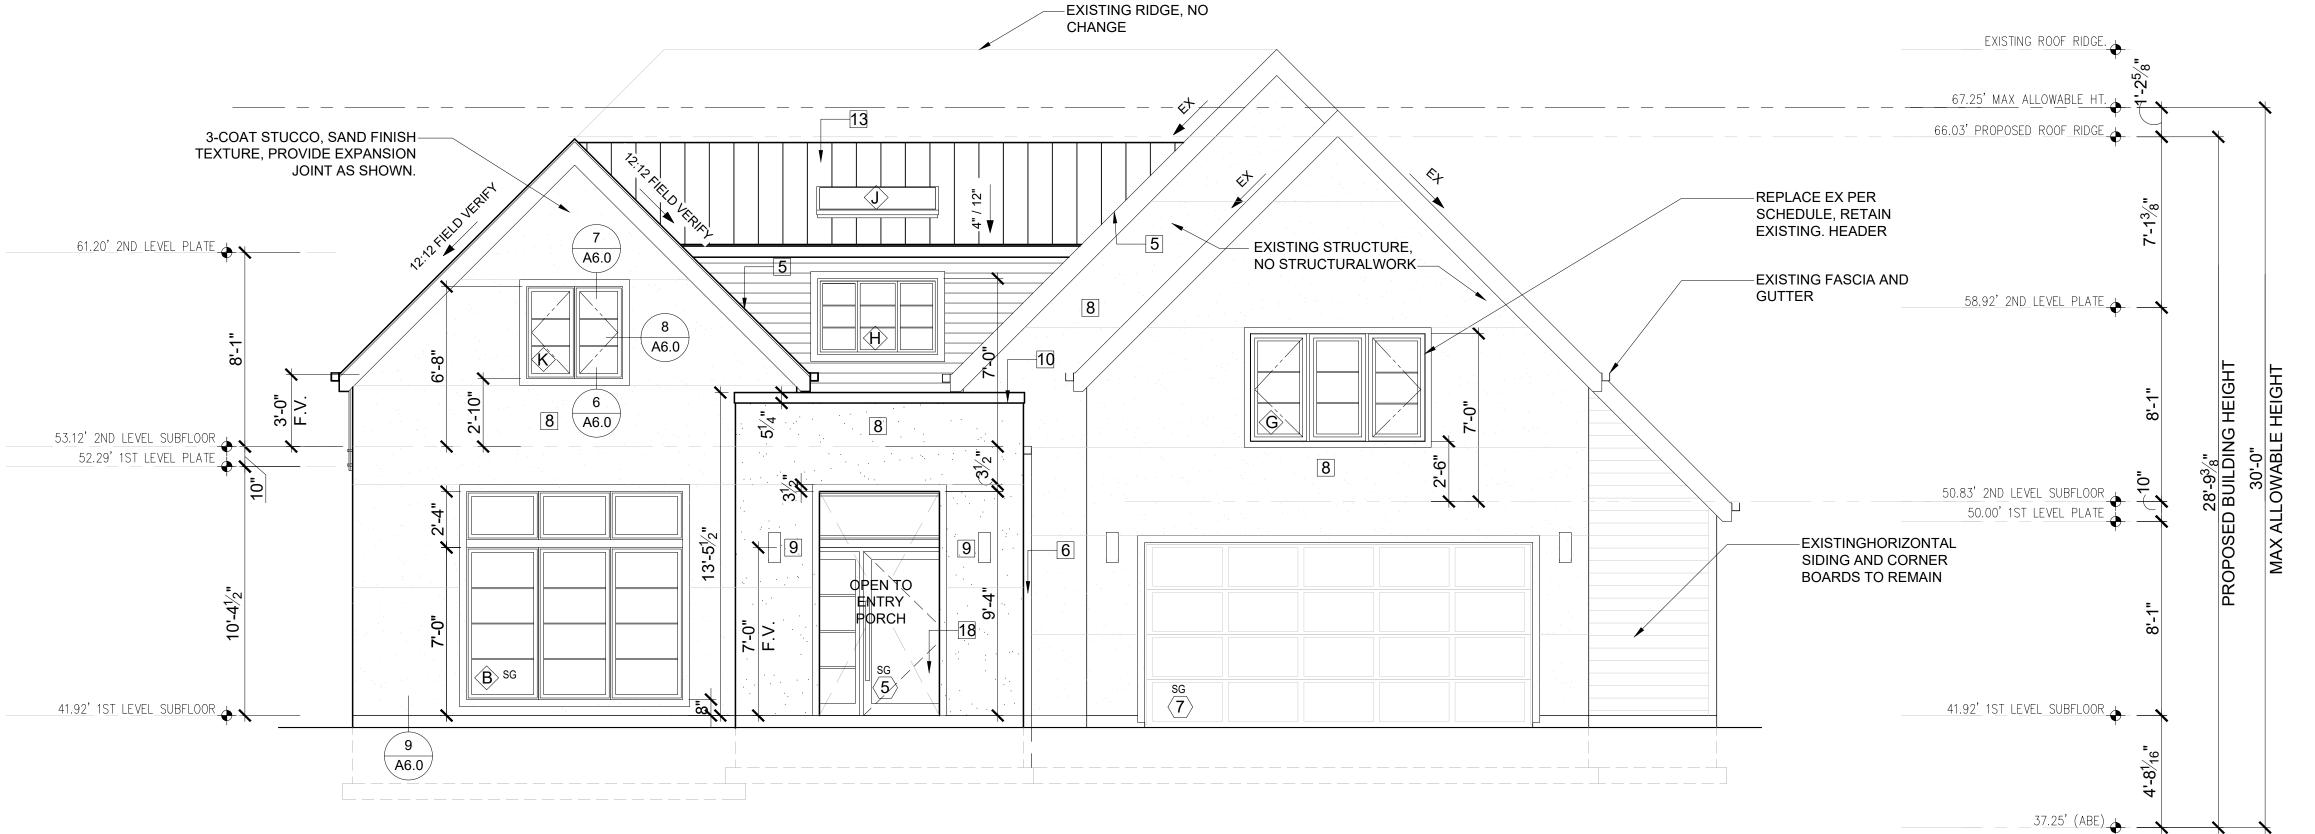
- 4. AT NEW AND REMODELED CONSTRUCTION AREAS PROVIDE APPROVED CORROSION
- RESISTANT FLASHING AT EXTERIOR WALL ENVELOPE PER I.R.C. R703.4.
- 5. AT NEW AND REMODELED CONSTRUCTION AREAS PROVIDE FLASHING AT ROOF
- 6. AT NEW AND REMODELED CONSTRUCTION AREAS PROVIDE PRE FINISHED CONTINUOUS ALUMINUM GUTTERS, SCUPPER AND DOWN SPOUTS - COLOR TO MATCH ADJACENT EXTERIOR MATERIAL FINISH. ROOF DRAINS AND SCUPPERS SHALL BE INSTALLED PER IRC SECTION R903.4. PROVIDE EMERGENCY OVERFLOW PER IRC SECTION 1503.4.1. TYPICAL SEE ROOF PLAN SHEET A3.0. DIRECT CONNECT FOOTING DRAINS AND DOWN SPOUTS PER CIVIL DRAWINGS.
- 7. SEE SHEET A0.1 FOR ADDITIONAL NOTES.
- 8. STUCCO VENEER: 3-COAT PORTLAND CEMENT STUCCO SHALL HAVE A SCRATCH, BROWN AND FINISH COATS OF PORTLAND CEMENT EXTERIOR PLASTER PER IRC SECTION R703.6.2; SAND FINISH COAT WITH INTEGRAL COLOR, OVER EXTERIOR METAL LATH PER IRC SECTION R703.6.1. TOTAL THICKNESS APPROXIMATELY 7/8". PROVIDE WEEP SCREEDS PER IRC SECTION R703.6.2.1
- 9. LIGHTING AT EXTERIOR DOORS, TYP.
- 10.POWDER COATED COPING
- 11. TPO ROOFING: MECHANICALLY ATTACHED ROOFING SYSTEM, LIGHT GREY, SCRIM-REINFORCED THERMOPLASTIC POLYOLEFIN (TPO) MEMBRANE. PERIMETER SHEETS ARE INSTALLED ALONG THE BUILDING EDGES AND FIELD MEMBRANE SHEETS ARE MECHANICALLY ATTACHED TO THE ROOF DECK WITH THE APPROPRIATE FASTENERS AND FASTENING PLATES. ADJOINING SHEETS OF MEMBRANE ARE OVERLAPPED AND JOINED TOGETHER WITH A MINIMUM 1-1/2" WIDE HOT AIR WELD. INSTALL PER
- MANUFACTURER. 12.MATCH EXISTING SHAKE ROOF AND FINISH TO MATCH, INSTALL PER INDUSTRY
- STANDARDS. 13.12" STANDING SEAM METAL ROOFING, INSTALL PER INDUSTRY STANDARDS. COLOR FINISH TO BE SELECTED BY OWNER.
- 14. POWDER COATED STEEL FRAME FOR INSTALLATION OF TEMPERED LAMINATED GLASS
- ROOF CANOPY, INSTALL BY ROOF CANOPY MANUFACTURER.
- 15. POWDER COATED STEEL COLUMN OR C-CHANNEL PER STRUCTURAL.
- **16.FIRE PLACE VENT**
- 17. HOOD VENT OVER BARBEQUE.
- 18.FRONT ENTRY DOOR: FRONT ENTRY DOOR SHALL BE ALUMINUM, MINIMUM1-3/4" THICK, 42" WIDE SINGLE SOLID DOOR WITH ONE SIDELIGHT AND TRANSOM WINDOW ABOVE, DOUBLE-GLAZED SAFETY GLASS, WITH LOW-E. PROVIDE ANODIZED METAL THRESHOLD, CYLINDER ENTRY LOCK ACCESS AND DEADBOLT DRILLING. U-VALUE OF DOORS TO BE 0.30 (2015 WSEC) OR BETTER. PROVIDE EUTHERM ALUMINUM DOOR OR EQUAL AS APPROVED BY ARCHITECT.
- 19. GLASS RAILING HANDRAIL: SIDE MOUNTED FRAMELESS GLASS RAIL SYSTEM WITH NON-GLARE TEMPERED GLASS PANELS.
- 20. WINDOWS: (CLIMATE ZONE 4C OF THE 2015 WSEC TABLE R402.1.1) ALL WINDOWS SHALL BE DOUBLE-PANED MINIMUM, PERFORMANCE AND CONSTRUCTION TO CONFORM WITH IRC SECTION R612. HARDWARE FINISH SHALL MATCH DOOR HARDWARE. ALL CASEMENT OPENINGS SHALL HAVE ROTO HARDWARE. ALL OPENINGS WEATHER-STRIPPED BY MANUFACTURER; GENERAL CONTRACTOR SHALL INSTALL "Z"-FLASHING AT HEADS OF ALL WINDOWS AND SEAL WINDOW PERIMETER PER MANUFACTURER'S SPECIFICATIONS.
- 21.PORCELAIN PAVERS DECK SYSTEM INSTALL PER POCELANOSA MANUFACTURER
- INSTRUCTIONS. 22.WOOD DECKING OVER RIPPED CEDAR DECK JOIST OVER 3/4" MARINE BOARD WATER MEMBRANE ROOFING PER IRC. R905.13 AND CLOSED CELL SPAY FOAM R-38.
- 23.STONE TILE VENEER. 24.BLACKEN STAINLESS STEEL
- 25.A STEEL, METAL FLASHING AND COPING TO BE POWDER COATED.

REQUIRED GUARDS SHALL NOT HAVE OPENINGS FROM THE WALKING SURFACE TO THE REQUIRE GUARD HEIGHT WHICH ALLOW PASSAGE OF A SPHERE 4 INCHES IN DIAMETER.

PER IRC - 301.5 CONCENTRATED LOAD. HANDRAILS AND GUARDS SHALL BE ABLE TO RESIST A SINGLE CONCENTRATED LOAD OF 200 POUNDS, APPLIED IN ANY DIRECTION AT ANY POINT ALONG THE TOP, AND TO TRANSFER THIS LOAD THROUGH THE SUPPORTS TO THE STRUCTURE.

R312.2.1 - WINDOW SILLS. IN DWELLING UNITS, WHERE THE OPENING OF AN OPERABLE WINDOW IS LOCATED MORE THAN 72" ABOVE THE FINISHED GRADE OR SURFACE BELOW. THE LOWEST PART OF THE CLEAR OPENING OF THE WINDOW SHALL BE A MINIMUM OF 24" ABOVE THE FINISHED FLOOR OF THE ROOM IN WHICH THE WINDOW IS LOCATED. OPERABLE SECTION OF WINDOWS SHALL NOT PERMIT OPENINGS THAT ALLOW PASSAGE OF A 4" DIAMETER SPHERE WHERE SUCH OPENINGS ARE LOCATED WITHIN 24" OF THE FINISHED FLOOR.





WEST ELEVATION SCALE: 1/4" = 1'-0"



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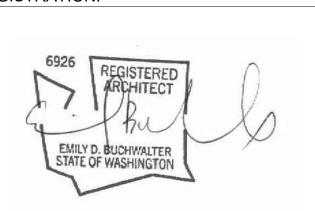
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PROJECT / CLIENT:

ACHIN & MARY CHEN 9820 SE 35TH PLACE MERCER ISLAND, WA 98040

JOB ADDRESS: 9820 SE 35TH PLACE

MERCER ISLAND, WA 98040 PARCEL # 082405-9027

DRAWING NAME:

ELEVATIONS

Drawn By: JMG,RB Checked By: EB Owner Approval:

PHASE: **CONSTRUCTION DOCUMENTS**

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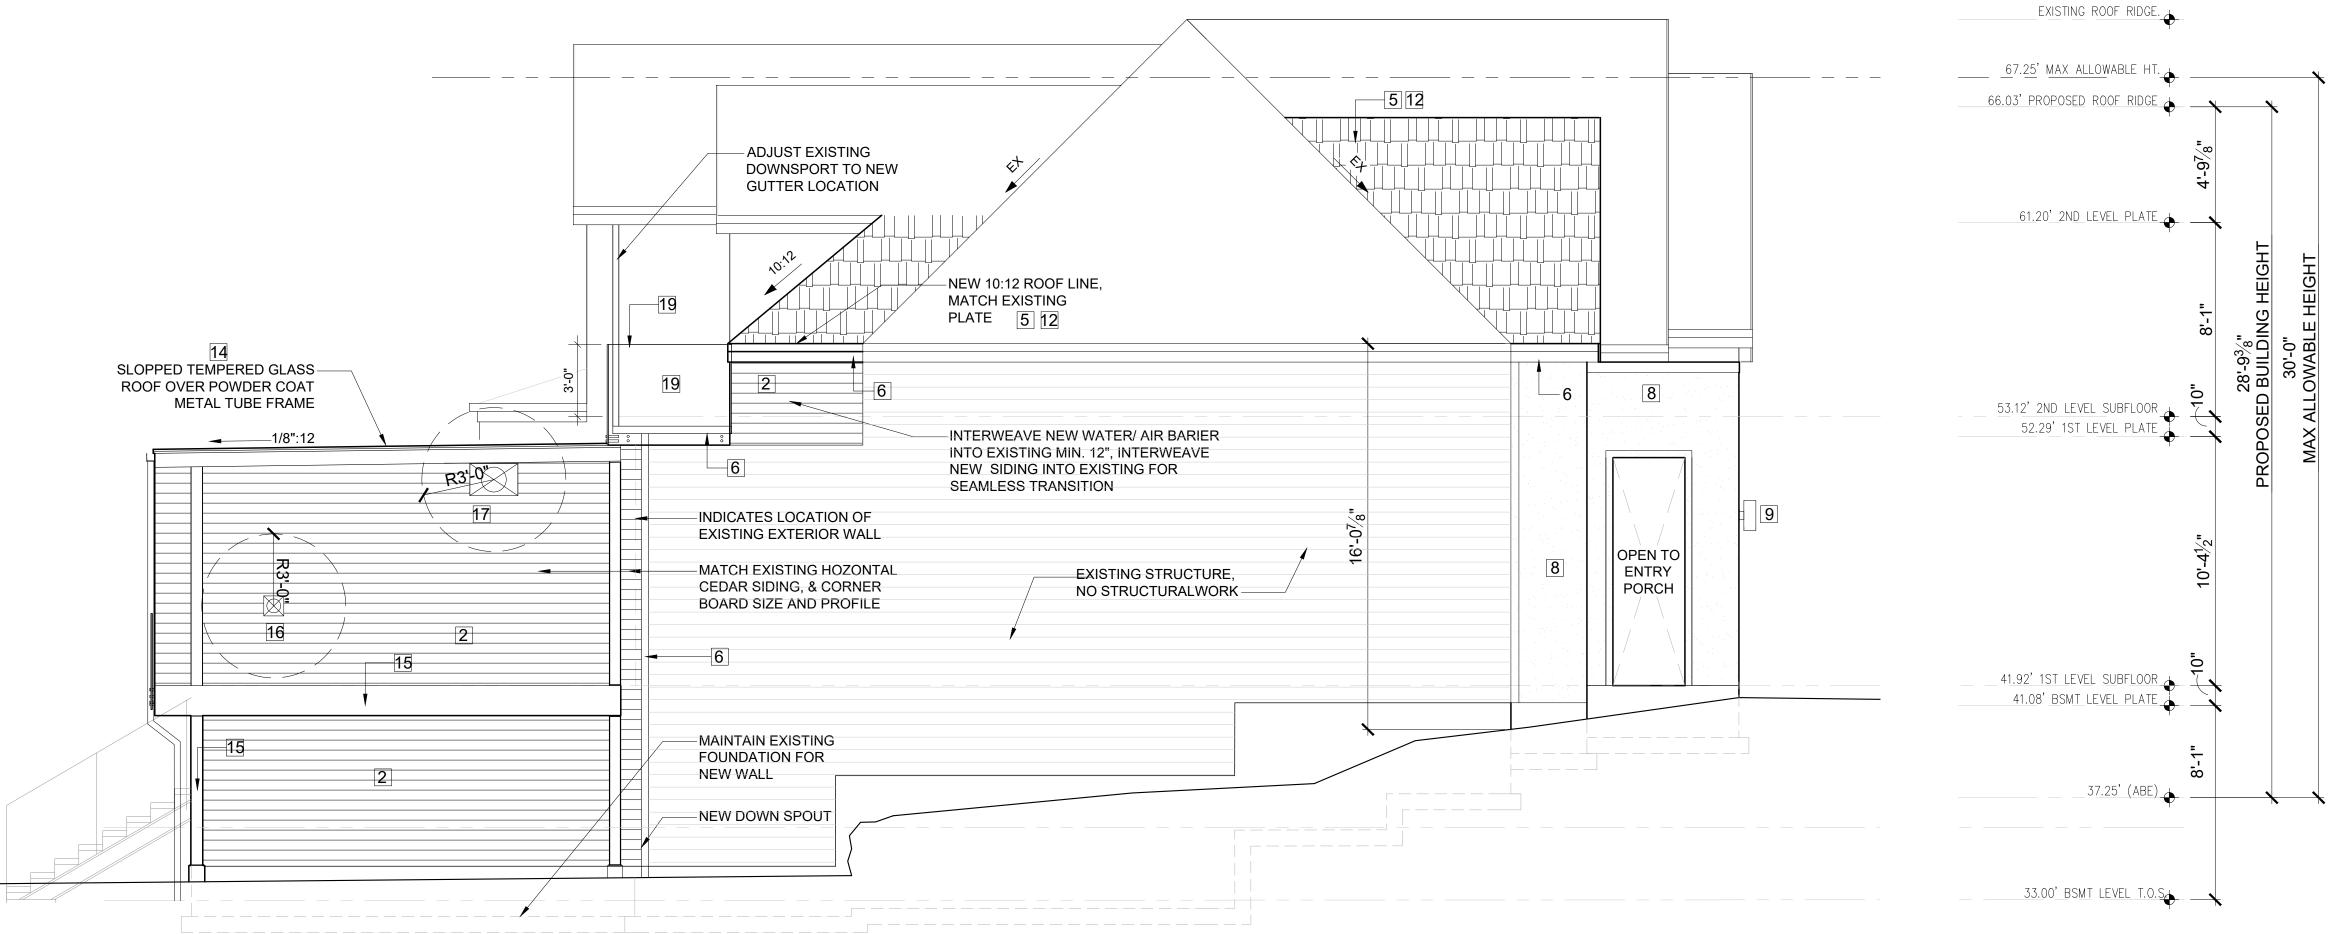
ELEVATIONS NOTES & KEY NOTES:

- VERIFY SHEAR WALL NAILING & HOLDOWNS PER STRUCTURAL PLAN & SCHEDULE PRIOR TO INSTALLING SIDING.
- 2. MATCH EXISTING CEDAR SIDING PROFILE AND EXPOSURE, PAINT TO MATCH.
 INTERWEAVE NEW CEDAR SIDING TO OLD AND EXTEND VAPOR BARRIER MINIMUM OF 6
 INCHES. TRANSITIONS TO BE SEAMLESS.
- 3. CAULK ALL EXTERIOR JOINTS & PENETRATIONS.
- 4. AT NEW AND REMODELED CONSTRUCTION AREAS PROVIDE APPROVED CORROSION RESISTANT FLASHING AT EXTERIOR WALL ENVELOPE PER I.R.C. R703.4.
- 5. AT NEW AND REMODELED CONSTRUCTION AREAS PROVIDE FLASHING AT ROOF PENETRATIONS PER I.R.C. R903.2 & R903.2.1.
- 6. AT NEW AND REMODELED CONSTRUCTION AREAS PROVIDE PRE FINISHED CONTINUOUS ALUMINUM GUTTERS, SCUPPER AND DOWN SPOUTS COLOR TO MATCH ADJACENT EXTERIOR MATERIAL FINISH. ROOF DRAINS AND SCUPPERS SHALL BE INSTALLED PER IRC SECTION R903.4. PROVIDE EMERGENCY OVERFLOW PER IRC SECTION 1503.4.1. TYPICAL SEE ROOF PLAN SHEET A3.0. DIRECT CONNECT FOOTING DRAINS AND DOWN SPOUTS PER CIVIL DRAWINGS.
- 7. SEE SHEET A0.1 FOR ADDITIONAL NOTES.
- 8. STUCCO VENEER: 3-COAT PORTLAND CEMENT STUCCO SHALL HAVE A SCRATCH, BROWN AND FINISH COATS OF PORTLAND CEMENT EXTERIOR PLASTER PER IRC SECTION R703.6.2; SAND FINISH COAT WITH INTEGRAL COLOR, OVER EXTERIOR METAL LATH PER IRC SECTION R703.6.1. TOTAL THICKNESS APPROXIMATELY 7/8". PROVIDE WEEP SCREEDS PER IRC SECTION R703.6.2.1
- 9. LIGHTING AT EXTERIOR DOORS, TYP.
- 10.POWDER COATED COPING
- 11. TPO ROOFING: MECHANICALLY ATTACHED ROOFING SYSTEM, LIGHT GRAY, SCRIM-REINFORCED THERMOPLASTIC POLYOLEFIN (TPO) MEMBRANE. PERIMETER SHEETS ARE INSTALLED ALONG THE BUILDING EDGES AND FIELD MEMBRANE SHEETS ARE MECHANICALLY ATTACHED TO THE ROOF DECK WITH THE APPROPRIATE FASTENERS AND FASTENING PLATES. ADJOINING SHEETS OF MEMBRANE ARE OVERLAPPED AND JOINED TOGETHER WITH A MINIMUM 1-1/2" WIDE HOT AIR WELD. INSTALL PER MANUFACTURER.
- 12.MATCH EXISTING SHAKE ROOF AND FINISH TO MATCH, INSTALL PER INDUSTRY STANDARDS.
- 13.12" STANDING SEAM METAL ROOFING, INSTALL PER INDUSTRY STANDARDS. COLOR FINISH TO BE SELECTED BY OWNER.
- 14.POWDER COATED STEEL FRAME FOR INSTALLATION OF TEMPERED LAMINATED GLASS ROOF CANOPY, INSTALL BY ROOF CANOPY MANUFACTURER.
- 15. POWDER COATED STEEL COLUMN OR C-CHANNEL PER STRUCTURAL.
- 16.FIRE PLACE VENT
- 17.HOOD VENT OVER BARBEQUE.
- 18. FRONT ENTRY DOOR: FRONT ENTRY DOOR SHALL BE ALUMINUM, MINIMUM1-3/4" THICK, 42" WIDE SINGLE SOLID DOOR WITH ONE SIDELIGHT AND TRANSOM WINDOW ABOVE, DOUBLE-GLAZED SAFETY GLASS, WITH LOW-E. PROVIDE ANODIZED METAL THRESHOLD, CYLINDER ENTRY LOCK ACCESS AND DEADBOLT DRILLING. U-VALUE OF DOORS TO BE 0.30 (2015 WSEC) OR BETTER. PROVIDE EUTHERM ALUMINUM DOOR OR EQUAL AS APPROVED BY ARCHITECT.
- 19. GLASS RAILING HANDRAIL: SIDE MOUNTED FRAMELESS GLASS RAIL SYSTEM WITH NON-GLARE TEMPERED GLASS PANELS.
- 20.WINDOWS: (CLIMATE ZONE 4C OF THE 2015 WSEC TABLE R402.1.1) ALL WINDOWS SHALL BE DOUBLE-PANED MINIMUM, PERFORMANCE AND CONSTRUCTION TO CONFORM WITH IRC SECTION R612. HARDWARE FINISH SHALL MATCH DOOR HARDWARE. ALL CASEMENT OPENINGS SHALL HAVE ROTO HARDWARE. ALL OPENINGS WEATHER-STRIPPED BY MANUFACTURER; GENERAL CONTRACTOR SHALL INSTALL "Z"-FLASHING AT HEADS OF ALL WINDOWS AND SEAL WINDOW PERIMETER PER MANUFACTURER'S SPECIFICATIONS.
- 21.PORCELAIN PAVERS DECK SYSTEM INSTALL PER PORCELANOSA MANUFACTURER INSTRUCTIONS.
- 22.WOOD DECKING OVER RIPPED CEDAR DECK JOIST OVER 3/4" MARINE BOARD WATER MEMBRANE ROOFING PER IRC. R905.13 AND CLOSED CELL SPAY FOAM R-38.
 23.STONE TILE VENEER.
- 24.BLACKEN STAINLESS STEEL

NOTE:
REQUIRED GUARDS SHALL NOT HAVE OPENINGS FROM
THE WALKING SURFACE TO THE REQUIRE GUARD
HEIGHT WHICH ALLOW PASSAGE OF A SPHERE 4
INCHES IN DIAMETER.

PER IRC - 301.5 CONCENTRATED LOAD. HANDRAILS AND GUARDS SHALL BE ABLE TO RESIST A SINGLE CONCENTRATED LOAD OF 200 POUNDS, APPLIED IN ANY DIRECTION AT ANY POINT ALONG THE TOP, AND TO TRANSFER THIS LOAD THROUGH THE SUPPORTS TO THE STRUCTURE.

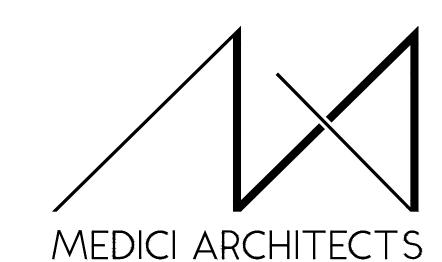
R312.2.1 - WINDOW SILLS. IN DWELLING UNITS, WHERE THE OPENING OF AN OPERABLE WINDOW IS LOCATED MORE THAN 72" ABOVE THE FINISHED GRADE OR SURFACE BELOW, THE LOWEST PART OF THE CLEAR OPENING OF THE WINDOW SHALL BE A MINIMUM OF 24" ABOVE THE FINISHED FLOOR OF THE ROOM IN WHICH THE WINDOW IS LOCATED. OPERABLE SECTION OF WINDOWS SHALL NOT PERMIT OPENINGS THAT ALLOW PASSAGE OF A 4" DIAMETER SPHERE WHERE SUCH OPENINGS ARE LOCATED WITHIN 24" OF THE FINISHED FLOOR.





EAST ELEVATION

SCALE: 1/4" = 1'-0"

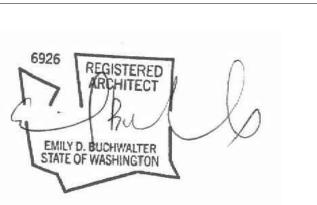


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MERCER ISLAND, WA 98040

JOB ADDRESS:

9820 SE 35TH PLACE MERCER ISLAND, WA 98040 PARCEL # 082405-9027

				EXISTING ROOF RIDGE.
				67.25' MAX ALLOWABLE HT.
				6.03' PROPOSED ROOF RIDGE
	EXISTING STRUCTURE, NO STRUCTURALWORK		REPLACE EX WDW WITH NE' DOOR, RETAIN EX. HDR.	61.20' 2ND LEVEL PLATE
EX a		19	NEW 10: 12 SHAKE PER ROC FIELD VERIFY PITCH 5 12 FRAME NEW PONYWALL TO EXISTING ADJACENT HEIGH	28'-93" 8'-1" 8'-1" 30'-0" 1.10 WABLE HEIGHT 1.20 WABLE
EX	RETAIN EXISTING HEADER	SG 6	3.0	53.12' 2ND LEVEL SUBFLOOR 52.29' 1ST LEVEL PLATE WAX ALLOW 1.01 2.82 8.02 1.01 8.02 1.03 1.04 1.05 1.05 12 EX c	20 TYP06	14	GLASS CANOPY ROOF BY O'SLOPE 1/8":12 TOWARD MET GUTTER MATCH EXISTING HOZONTA SIDING PROFILE & REVEAL / CORNER BOARD SIZE	10'-4½"
EX SG (4)		21 (EX) d	SEE SITE PLAN FOR DOWNSPOUT LOCATIONS	41.92' 1ST LEVEL SUBFLOOR 41.08' BSMT LEVEL PLATE
15 54 EX f		2 8-,9	6	37.25' (ABE)
21 EX e	6 SG 2	15 sg 1	STEEL COLUMN ON CONC. PLINTH PER STRUCTURAL 15	33.00'_BSMT_LEVEL_T.O.S

DRAWING NAME:

ELEVATIONS

Drawn By: JMG,RB
Checked By: EB
Owner Approval:

PHASE:

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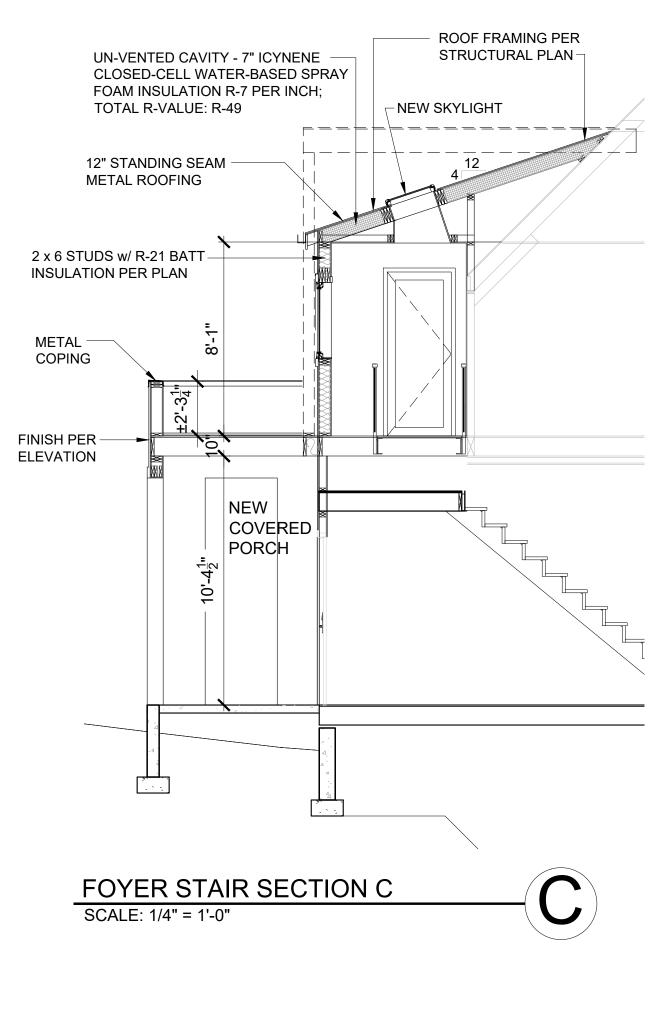
PROJECT No.: 2020 007

12-22-2020

PLOT SCALE: 1:1

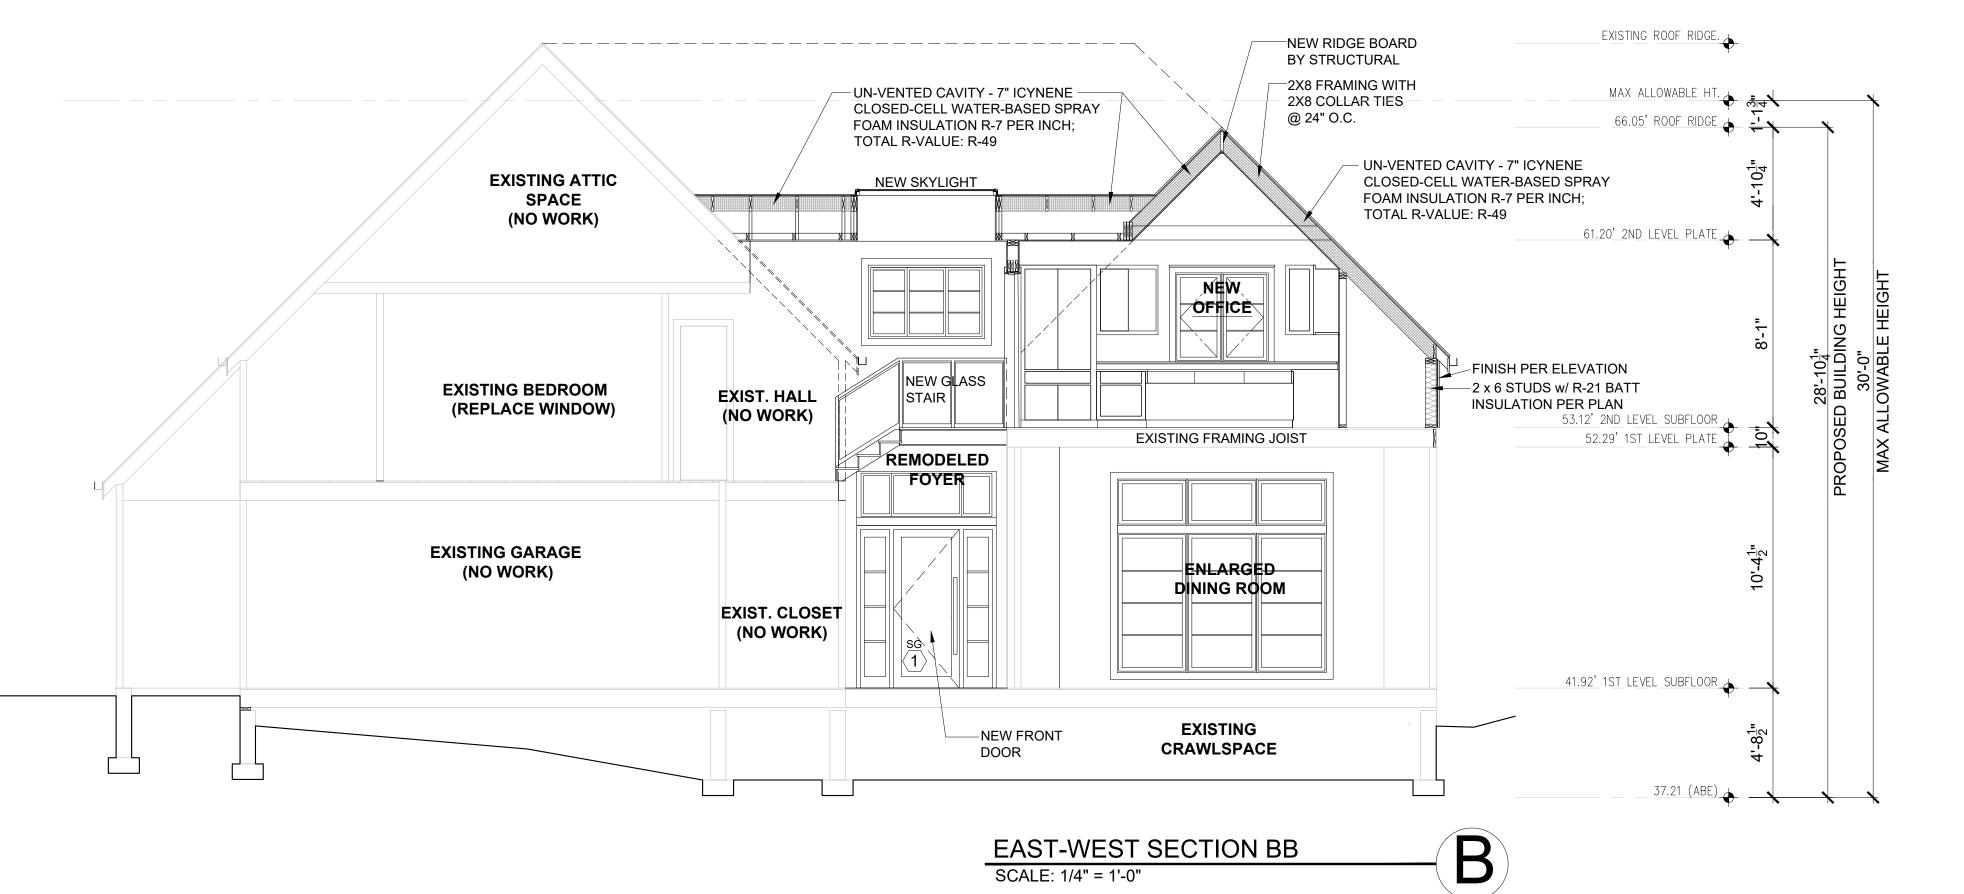
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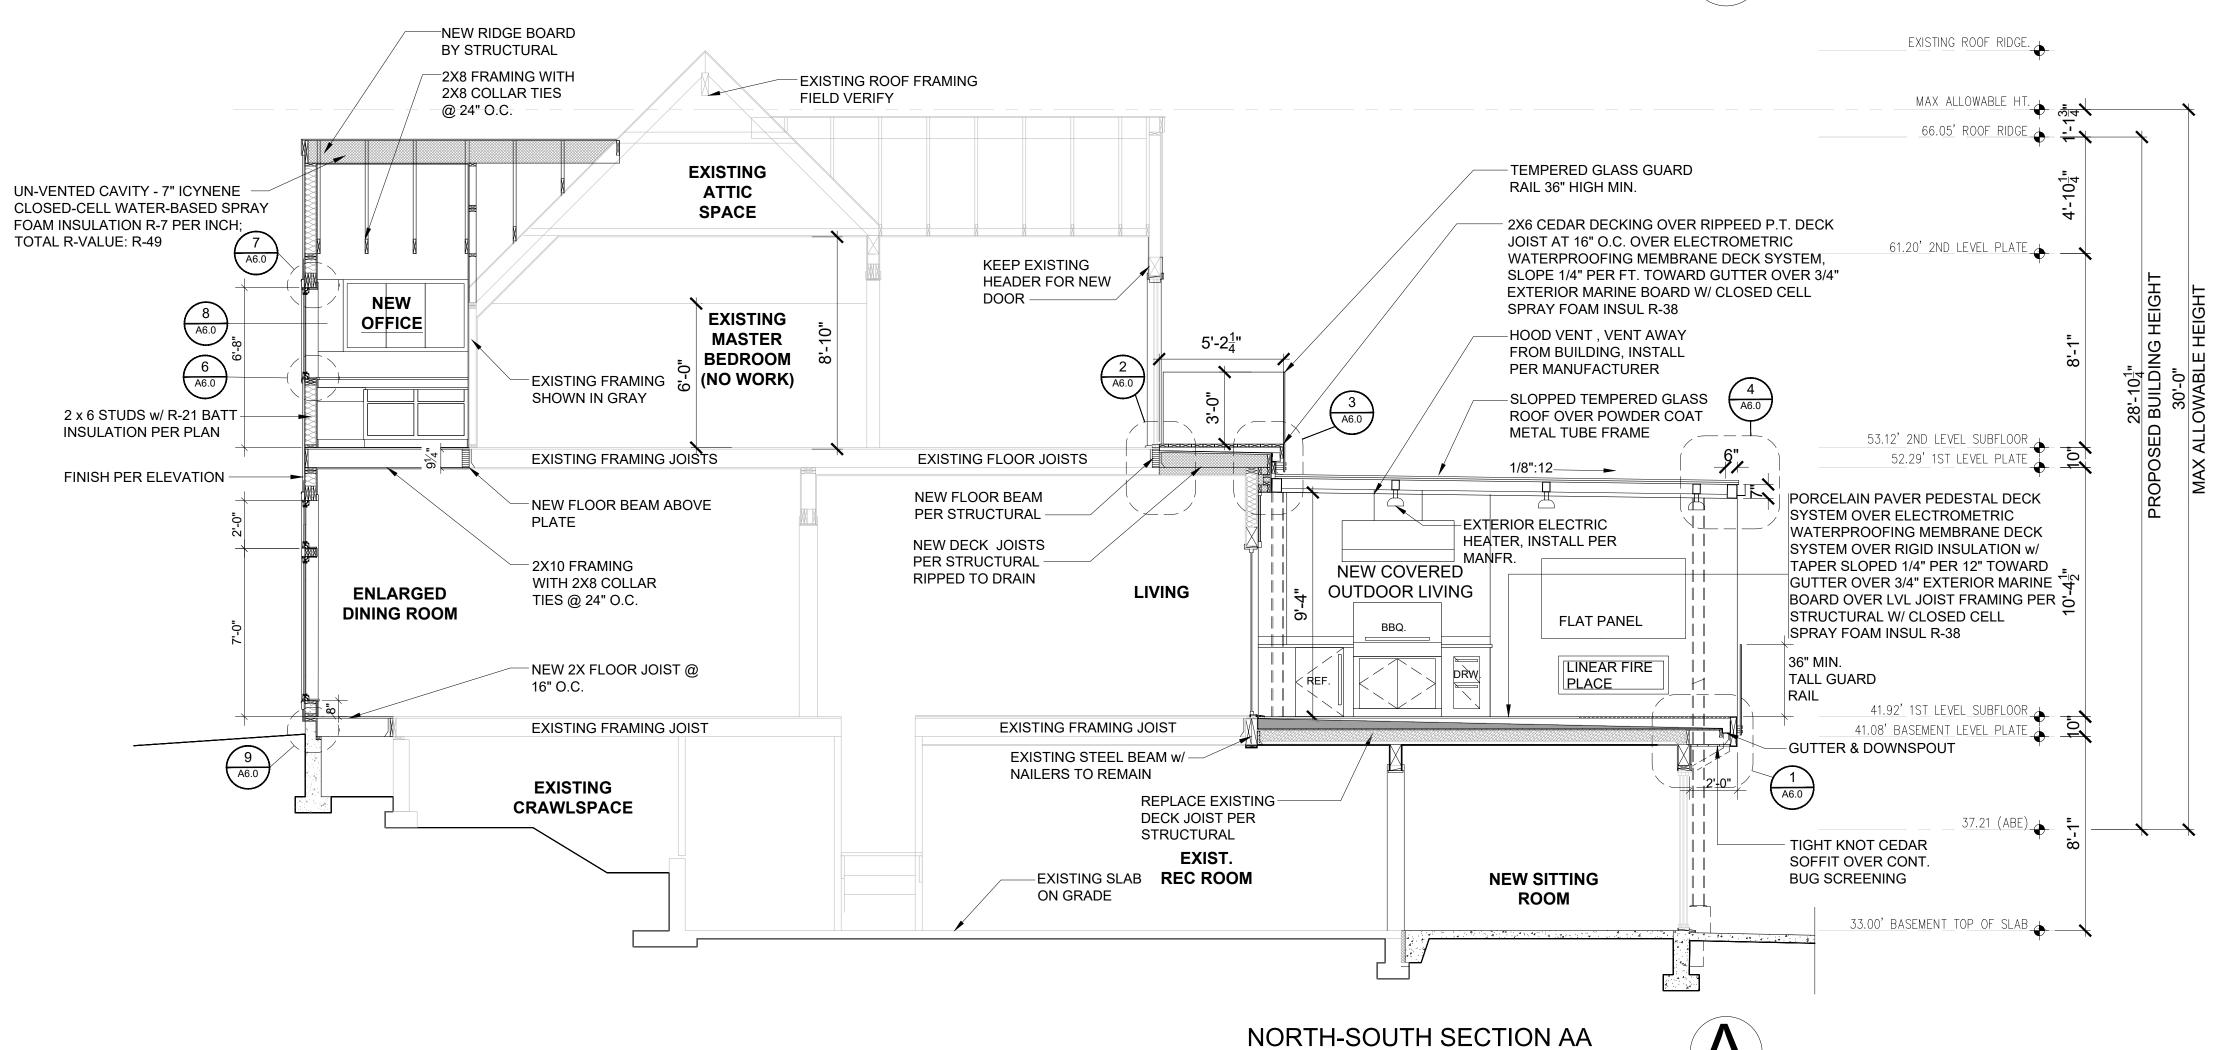
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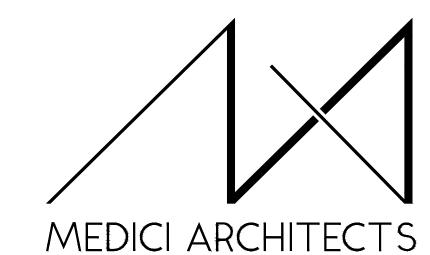
THERMAL INSULATION:
Walls (below-grade, exterior):
Walls (below-grade, interior):
Walls (above-grade):
Headers:
Ceilings (advanced framing):
Ceilings (standard framing):
Ceilings (vaulted):
Floors:
Slab:
Solid doors:
Windows & doors with glazing:
Skylights:

R-10 rigid insulation
R-21 batt or rigid insulation
R-21 batt or rigid insulation
R-10 rigid insulation
R-38 batt
R-49 batt
Icynene with min R-49
R-30 batt or rigid insulation
R-10 water-resistant rigid insulation
U-value of .20 or better
U-value of .50 or better





SCALE: 1/4" = 1'-0"

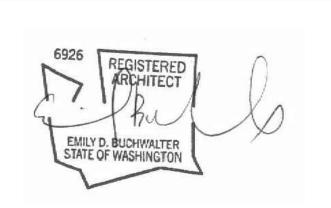


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PARCEL # 082405-9027

DRAWING NAME:

SECTIONS

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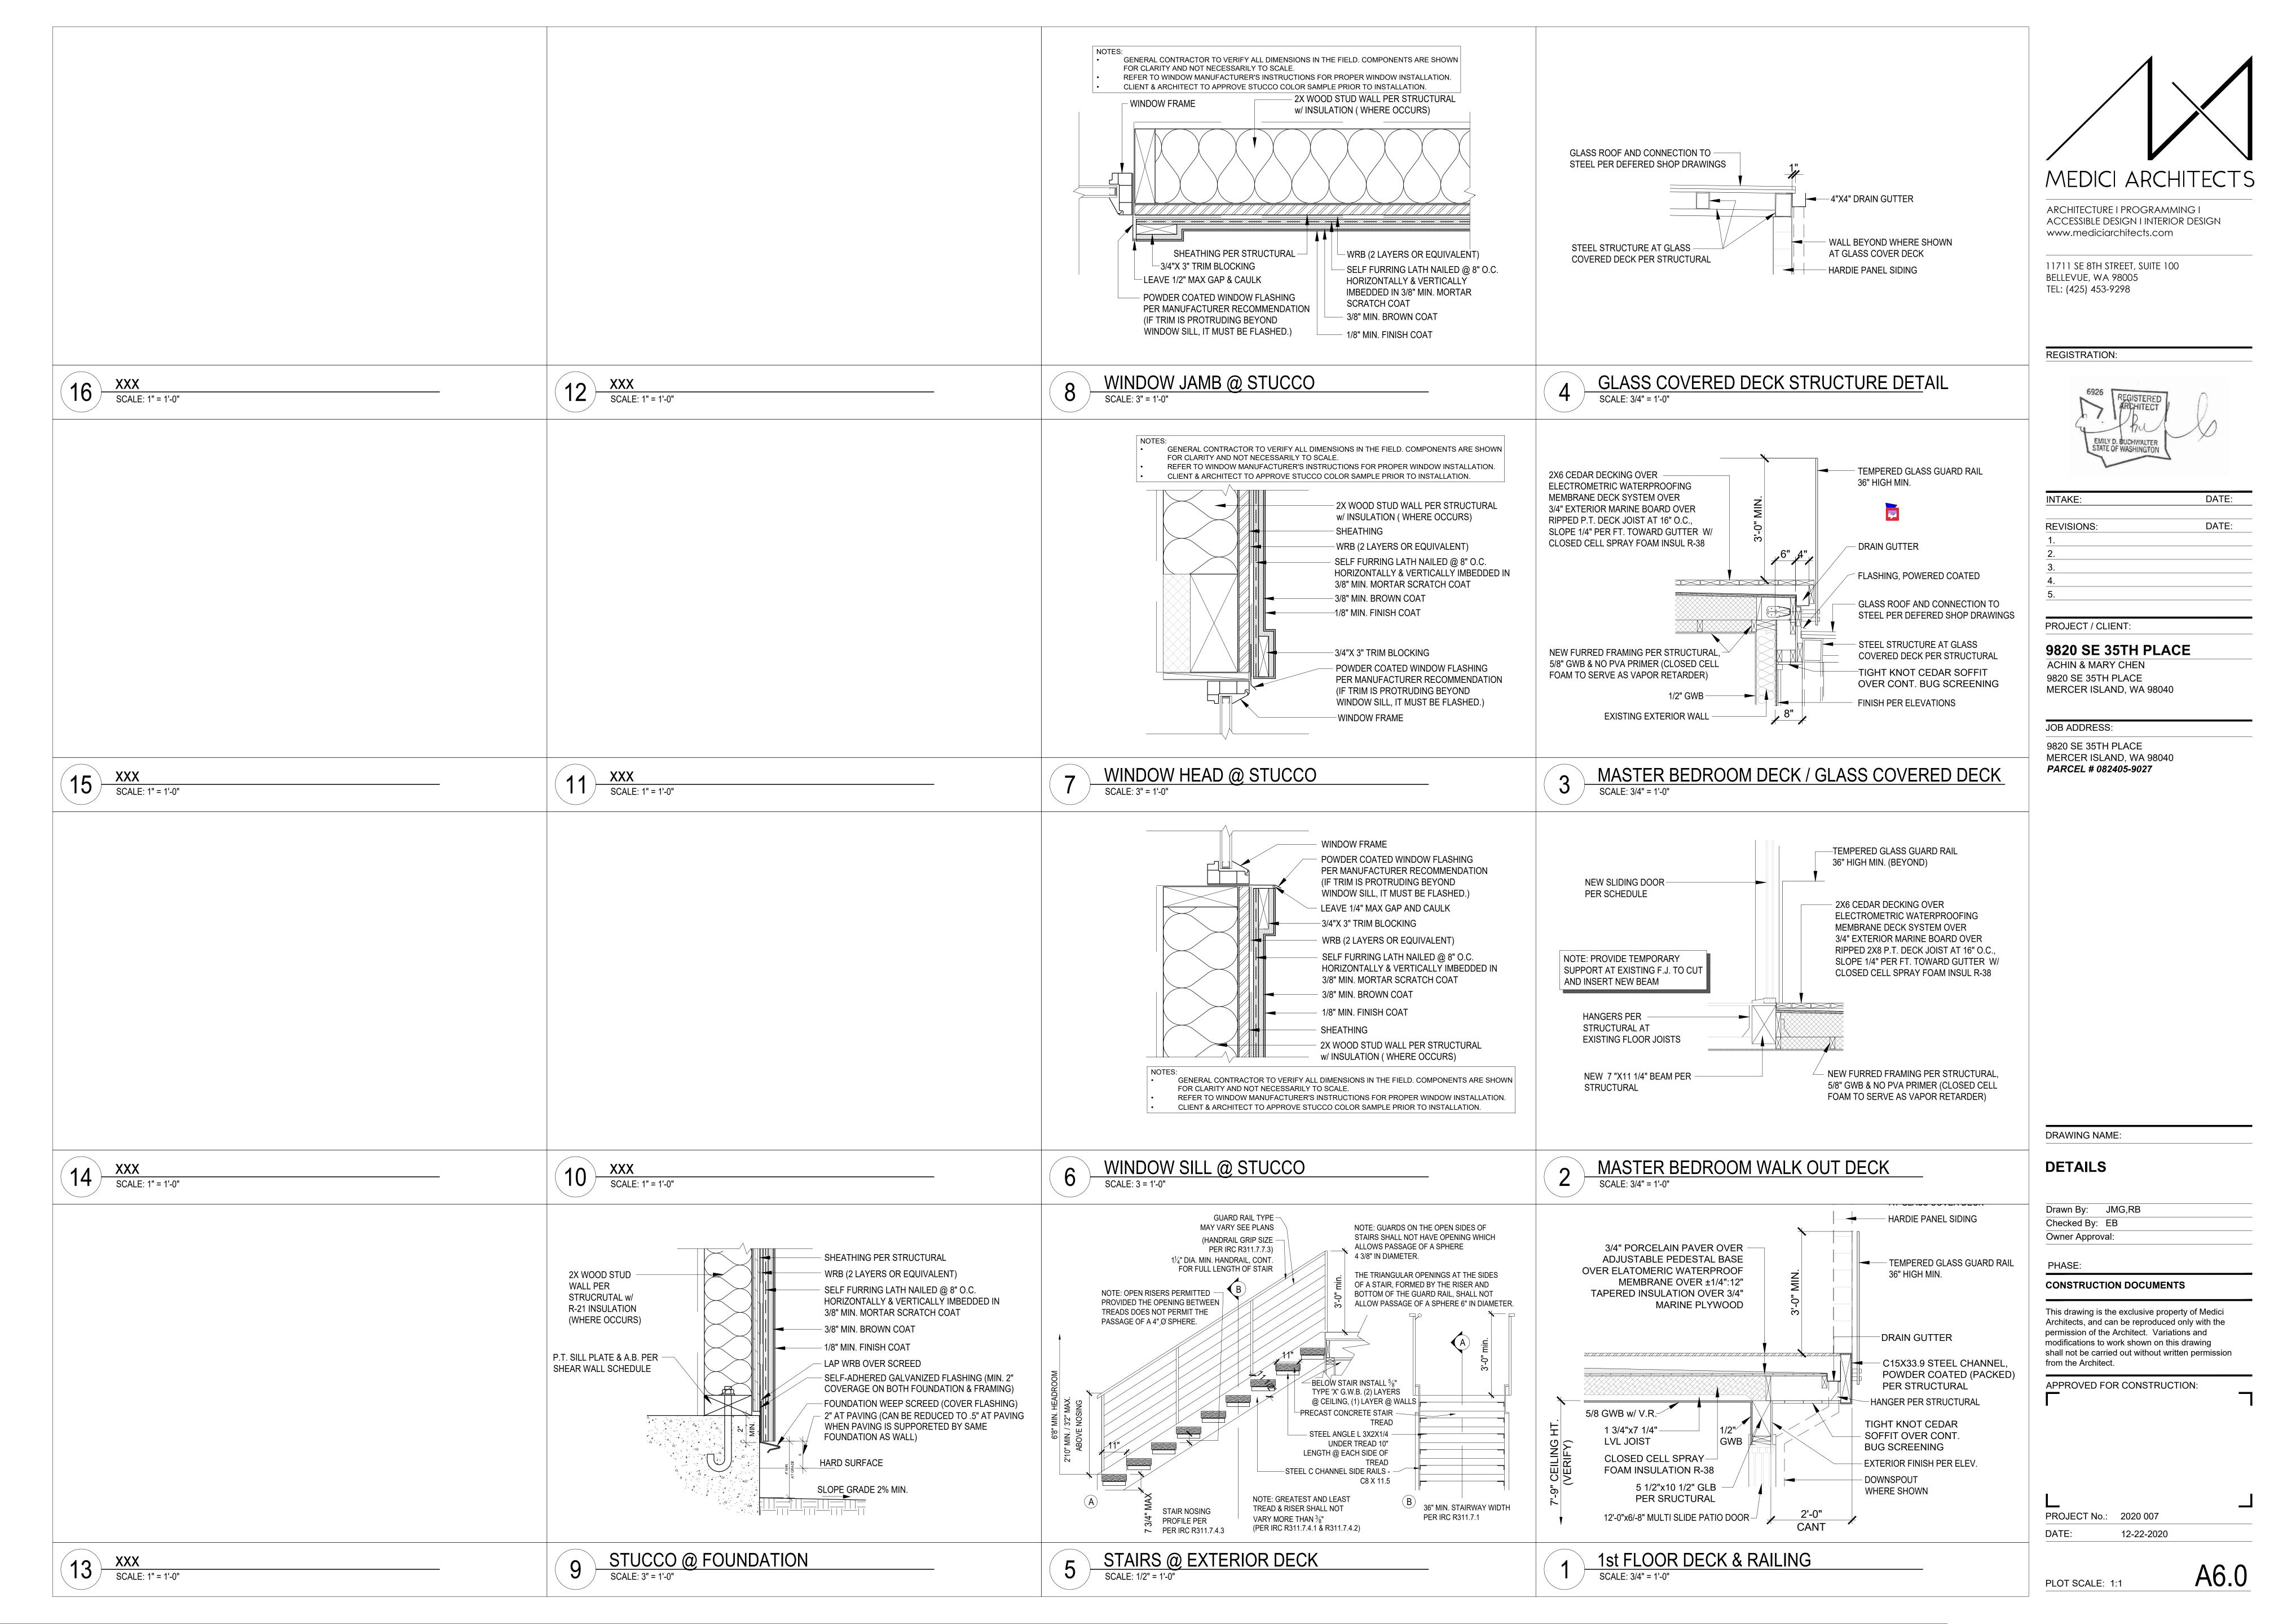
PROJECT No.: 2020 007

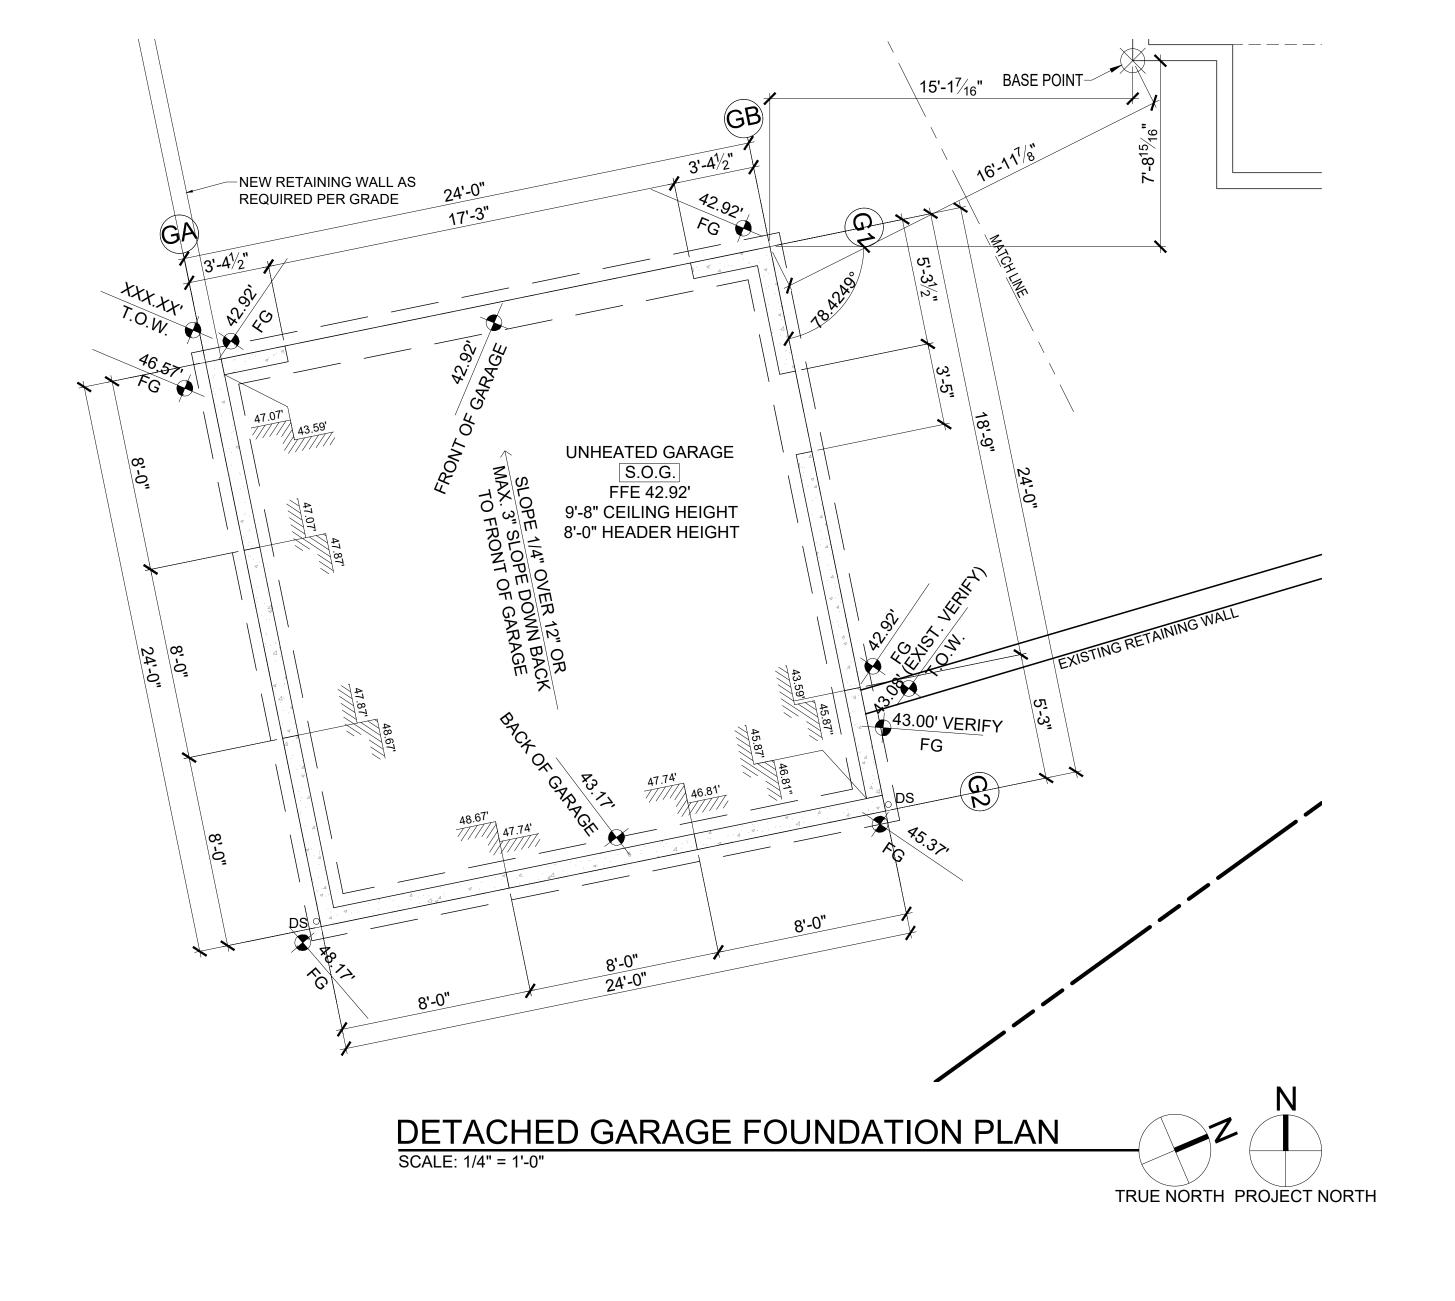
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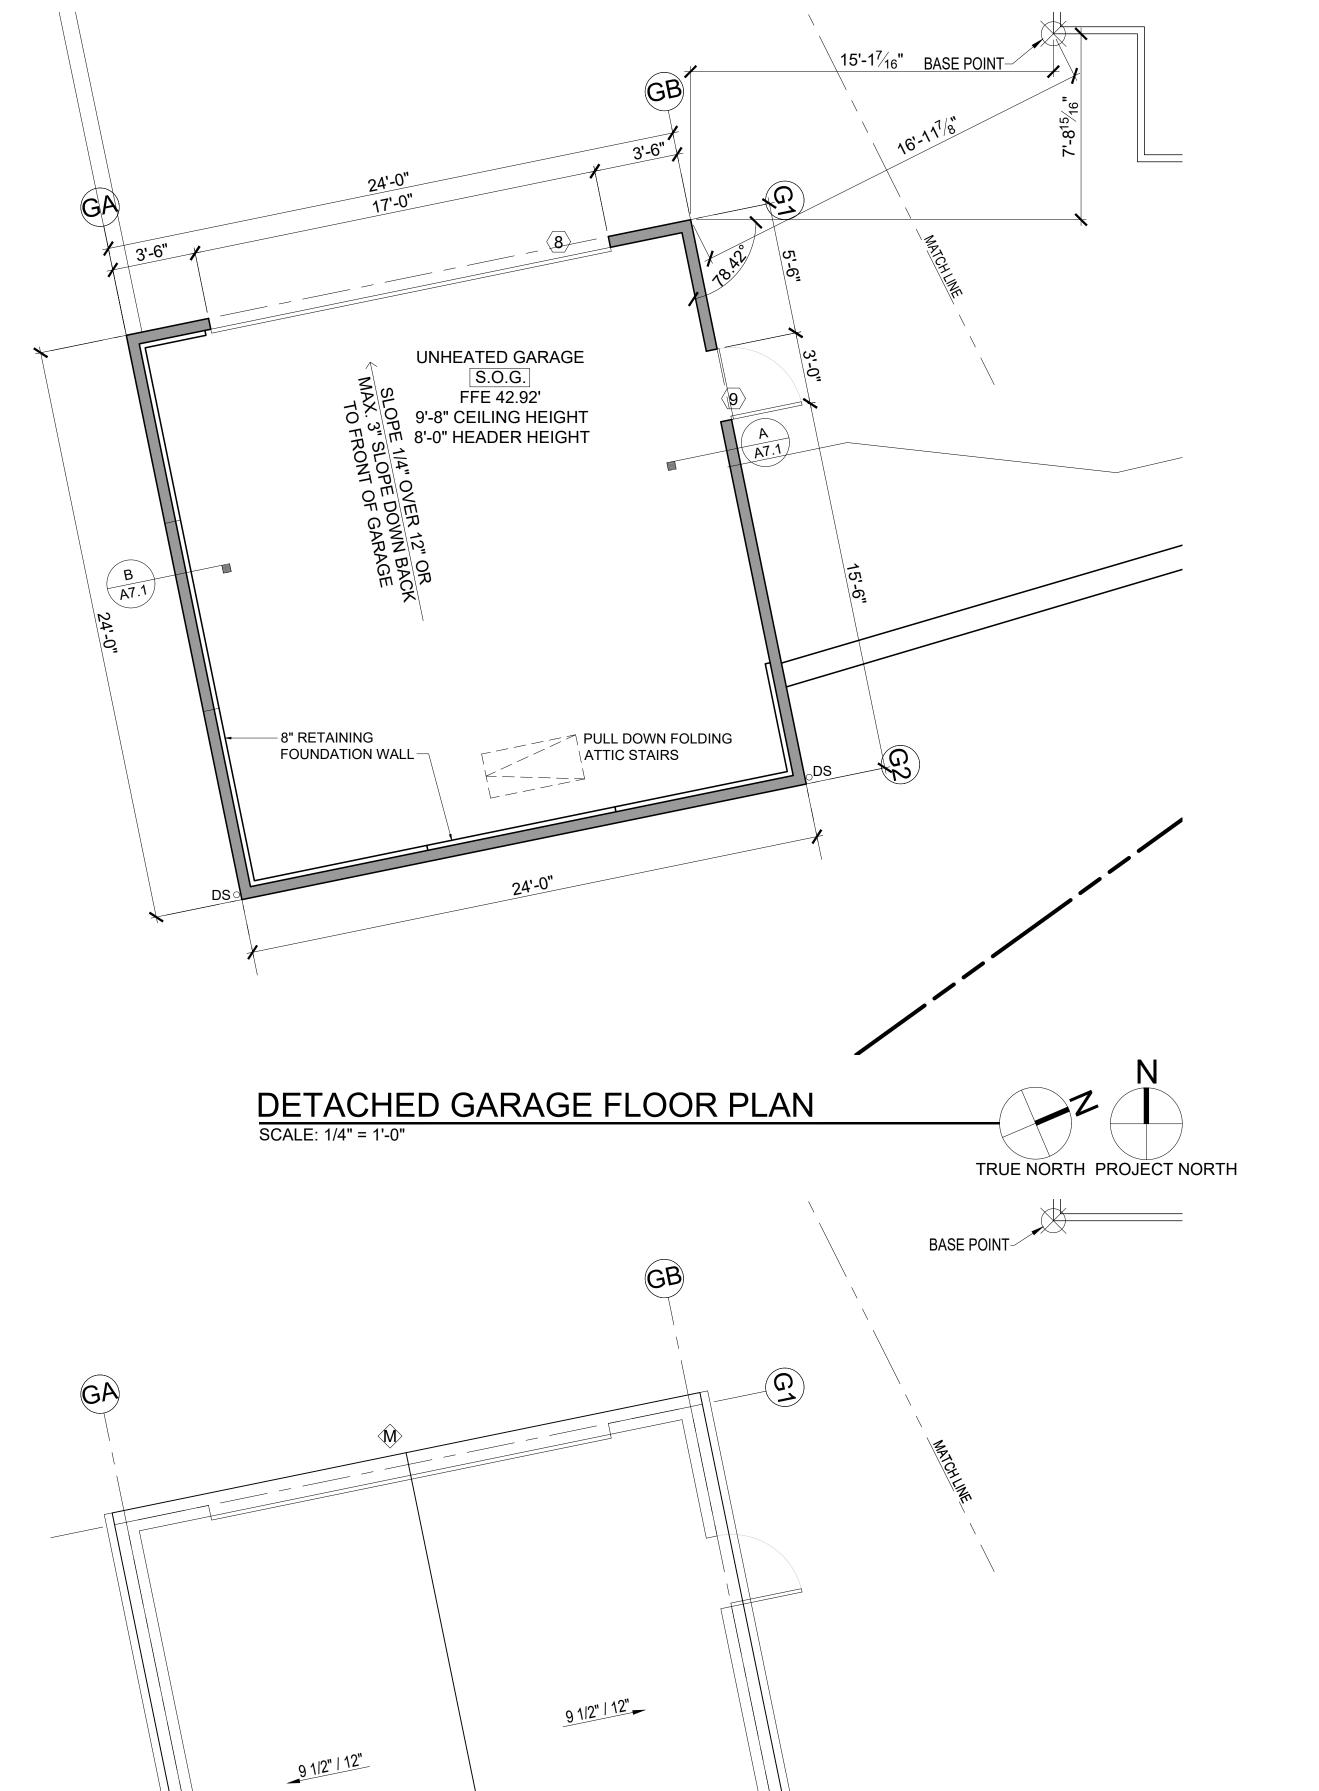
12-22-2020

PLOT SCALE: 1:1

A5.0







DETACHED GARAGE ROOF PLAN

CONTRACTOR SHALL VERIFY ALL NOTES, DIMENSIONS & CONDITIONS PRIOR TO CONSTRUCTION.

3. WINDOWS & DOORS ARE SHOWN & NOTED AS NOMINAL SIZES. REFER TO

DOOR JAMB 4.5" U.N.O.
 SEE ELEVATIONS SHEETS A7.1 FOR WINDOW & DOOR HEADER HEIGHTS

6. ALL WOOD IN CONTACT WITH CONCRETE TO BE PRESSURE TREATED.

7. EXTERIOR WALLS TO BE 2x4 STUDS @ 16" O.C., U.N.O.
 8. INSTALL SIMPSON CONC. TO WOOD HOLDOWNS PER STRUCTURAL DRAWINGS, ALSO SEE MANUFACTURER'S SPECS.

10. FIXTURES SHALL BE SPACED IN ACCORDANCE WITH FIGURE R307.1.

2. ALL POSTS, BEAMS & HEADERS SEE STRUCTURAL DRAWINGS.

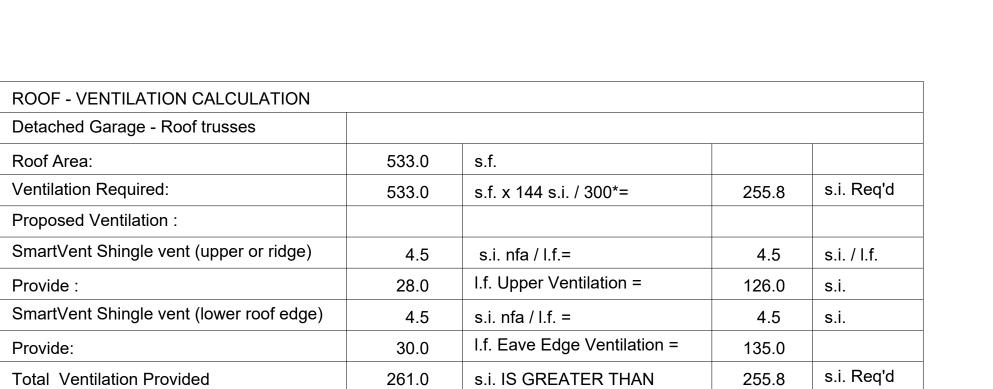
SCALE: 1/4" = 1'-0"

FLOOR PLAN NOTES

ABOVE FINISHED FLOOR.

SHEET A4.0 WINDOW AND DOOR SIZES.

9. SEE SHEET A0.1 FOR ADDITIONAL NOTES.

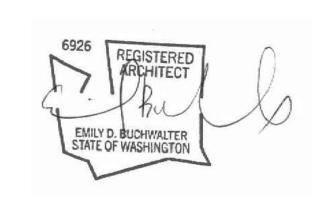




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JOB ADDRESS: 9820 SE 35TH PLACE MERCER ISLAND, WA 98040 PARCEL # 082405-9027

DRAWING NAME:

DETACHED GARAGE CONSTRUCTION PLAN

Drawn By: JMG,RB Checked By: EB Owner Approval:

PHASE:

from the Architect.

TRUE NORTH PROJECT NORTH

SYMBOL LEGEND

DOORS

2X WALLS

BRICK WALLS

WINDOWS

WITH STRUCTURAL PLAN

CO

9

SMOKE DETECTOR

CARBON MONOXIDE DETECTOR

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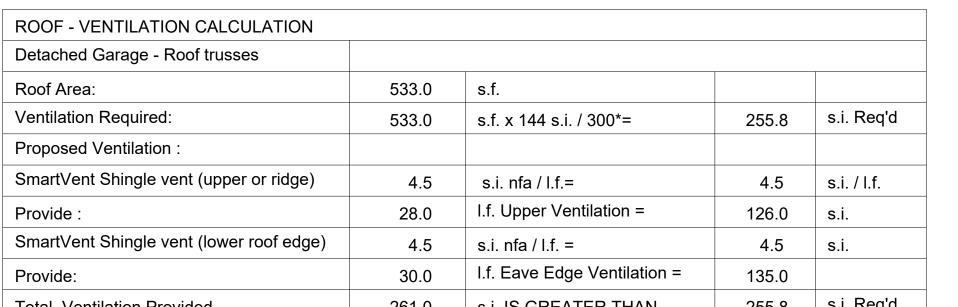
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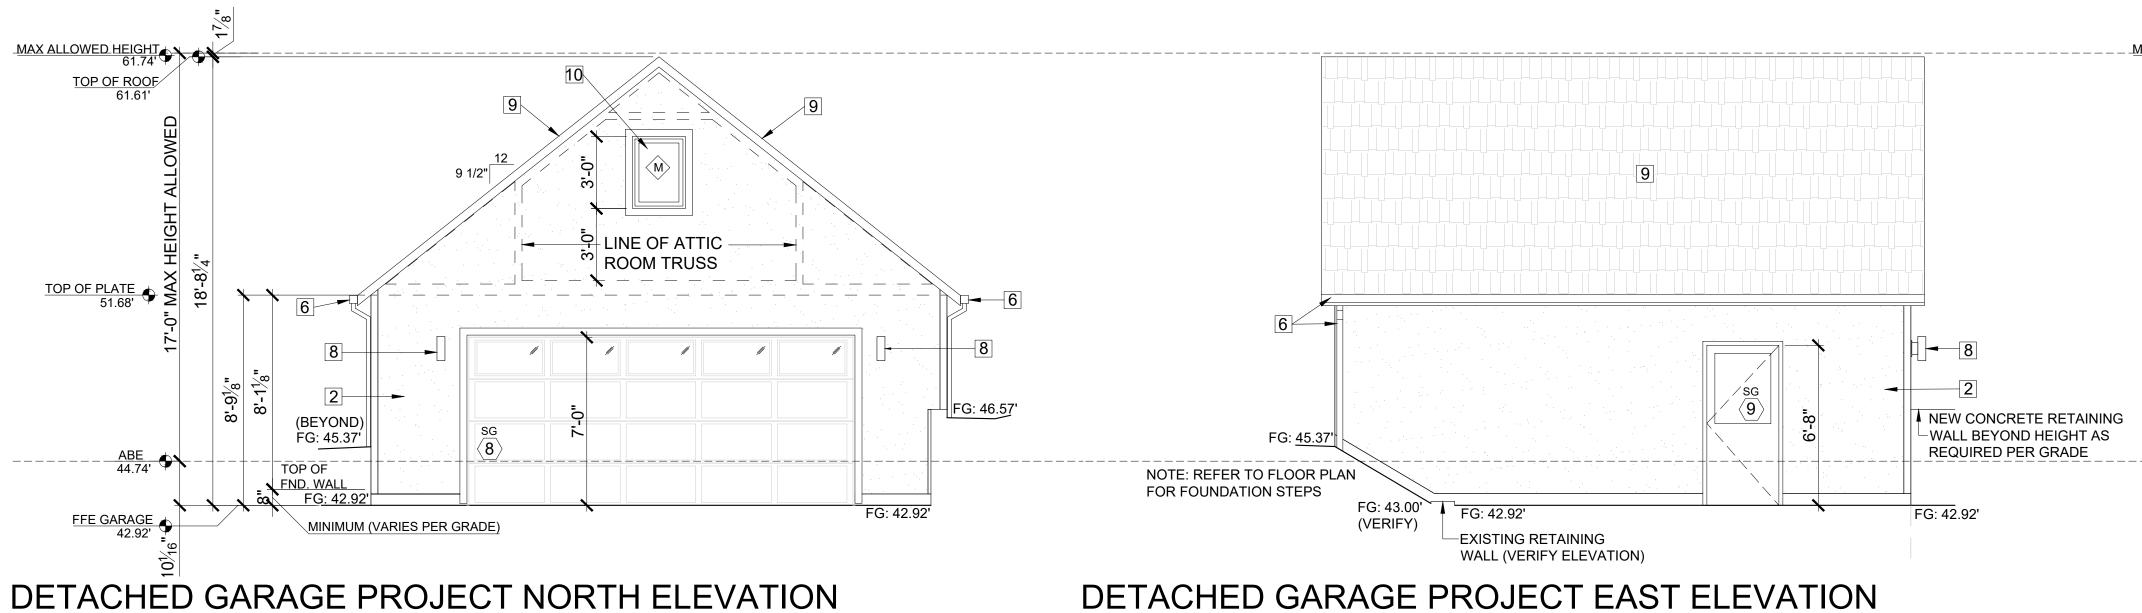
PLOT SCALE: 1:1

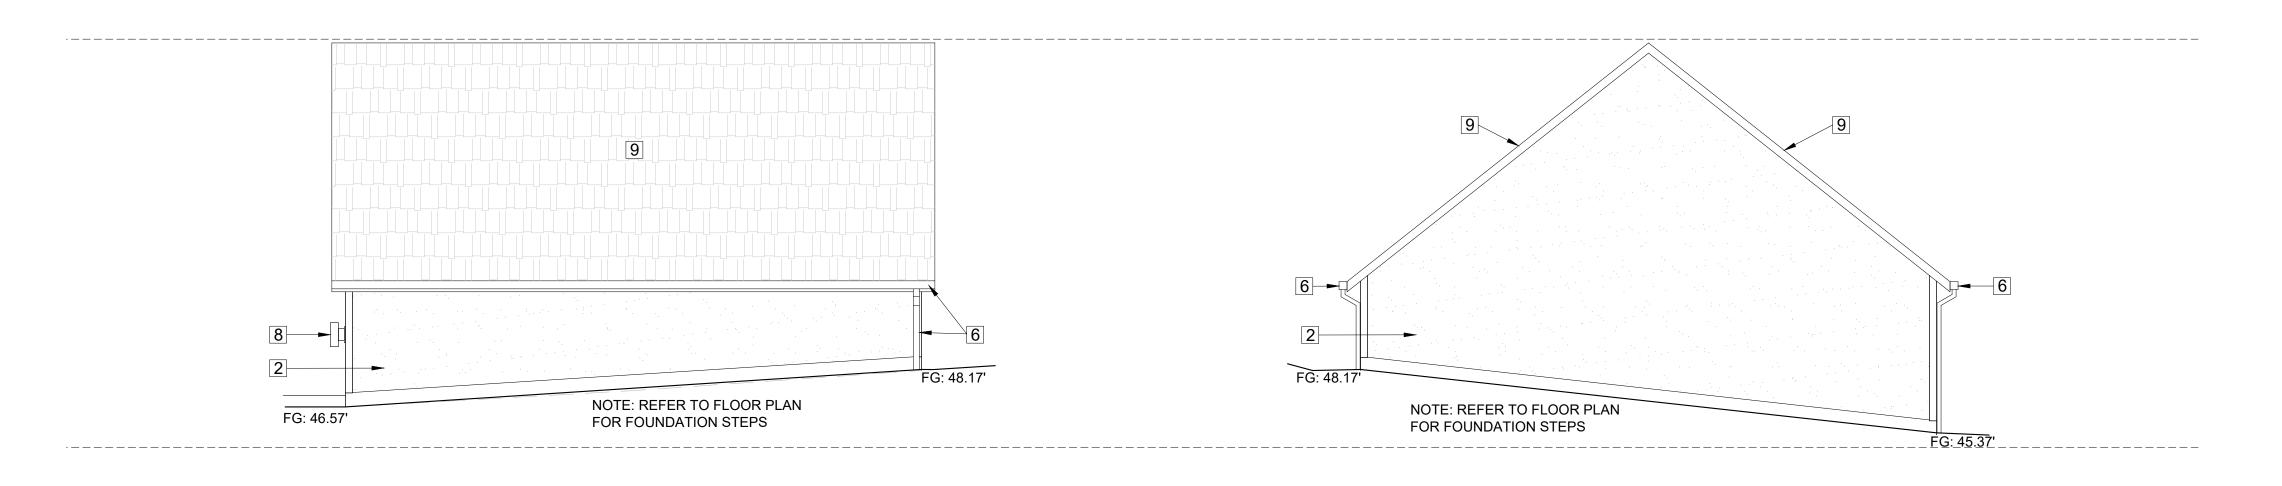
12-22-2020



ELEVATIONS NOTES & KEY NOTES:

- VERIFY SHEAR WALL NAILING & HOLDOWNS PER STRUCTURAL PLAN & SCHEDULE PRIOR TO INSTALLING SIDING.
- 2. STUCCO VENEER: 3-COAT PORTLAND CEMENT STUCCO SHALL HAVE A SCRATCH, BROWN AND FINISH COATS OF PORTLAND CEMENT EXTERIOR PLASTER PER IRC SECTION R703.6.2; SAND FINISH COAT WITH INTEGRAL COLOR, OVER EXTERIOR METAL LATH PER IRC SECTION R703.6.1. TOTAL THICKNESS APPROXIMATELY 7/8". PROVIDE WEEP SCREEDS PER IRC SECTION R703.6.2.1
- 3. CAULK ALL EXTERIOR JOINTS & PENETRATIONS.
- 4. AT NEW AND REMODELED CONSTRUCTION AREAS PROVIDE APPROVED CORROSION
- RESISTANT FLASHING AT EXTERIOR WALL ENVELOPE PER I.R.C. R703.4.
- 5. AT NEW AND REMODELED CONSTRUCTION AREAS PROVIDE FLASHING AT ROOF PENETRATIONS PER I.R.C. R903.2 & R903.2.1.
- 6. AT NEW AND REMODELED CONSTRUCTION AREAS PROVIDE PRE FINISHED CONTINUOUS ALUMINUM GUTTERS, SCUPPER AND DOWN SPOUTS COLOR TO MATCH ADJACENT EXTERIOR MATERIAL FINISH. DIRECT CONNECT FOOTING DRAINS AND DOWN SPOUTS PER CIVIL DRAWINGS.
- 7. SEE SHEET A0.1 FOR ADDITIONAL NOTES.
- 8. LIGHTING AT EXTERIOR DOORS, TYP.
- MATCH EXISTING SHAKE ROOF AND FINISH TO MATCH, INSTALL PER INDUSTRY STANDARDS.
- 10. WINDOWS: (CLIMATE ZONE 4C OF THE 2015 WSEC TABLE R402.1.1) ALL WINDOWS SHALL BE DOUBLE-PANED MINIMUM, PERFORMANCE AND CONSTRUCTION TO CONFORM WITH IRC SECTION R612. HARDWARE FINISH SHALL MATCH DOOR HARDWARE. ALL CASEMENT OPENINGS SHALL HAVE ROTO HARDWARE. ALL OPENINGS WEATHER-STRIPPED BY MANUFACTURER; GENERAL CONTRACTOR SHALL INSTALL "Z"-FLASHING AT HEADS OF ALL WINDOWS AND SEAL WINDOW PERIMETER PER MANUFACTURER'S SPECIFICATIONS.

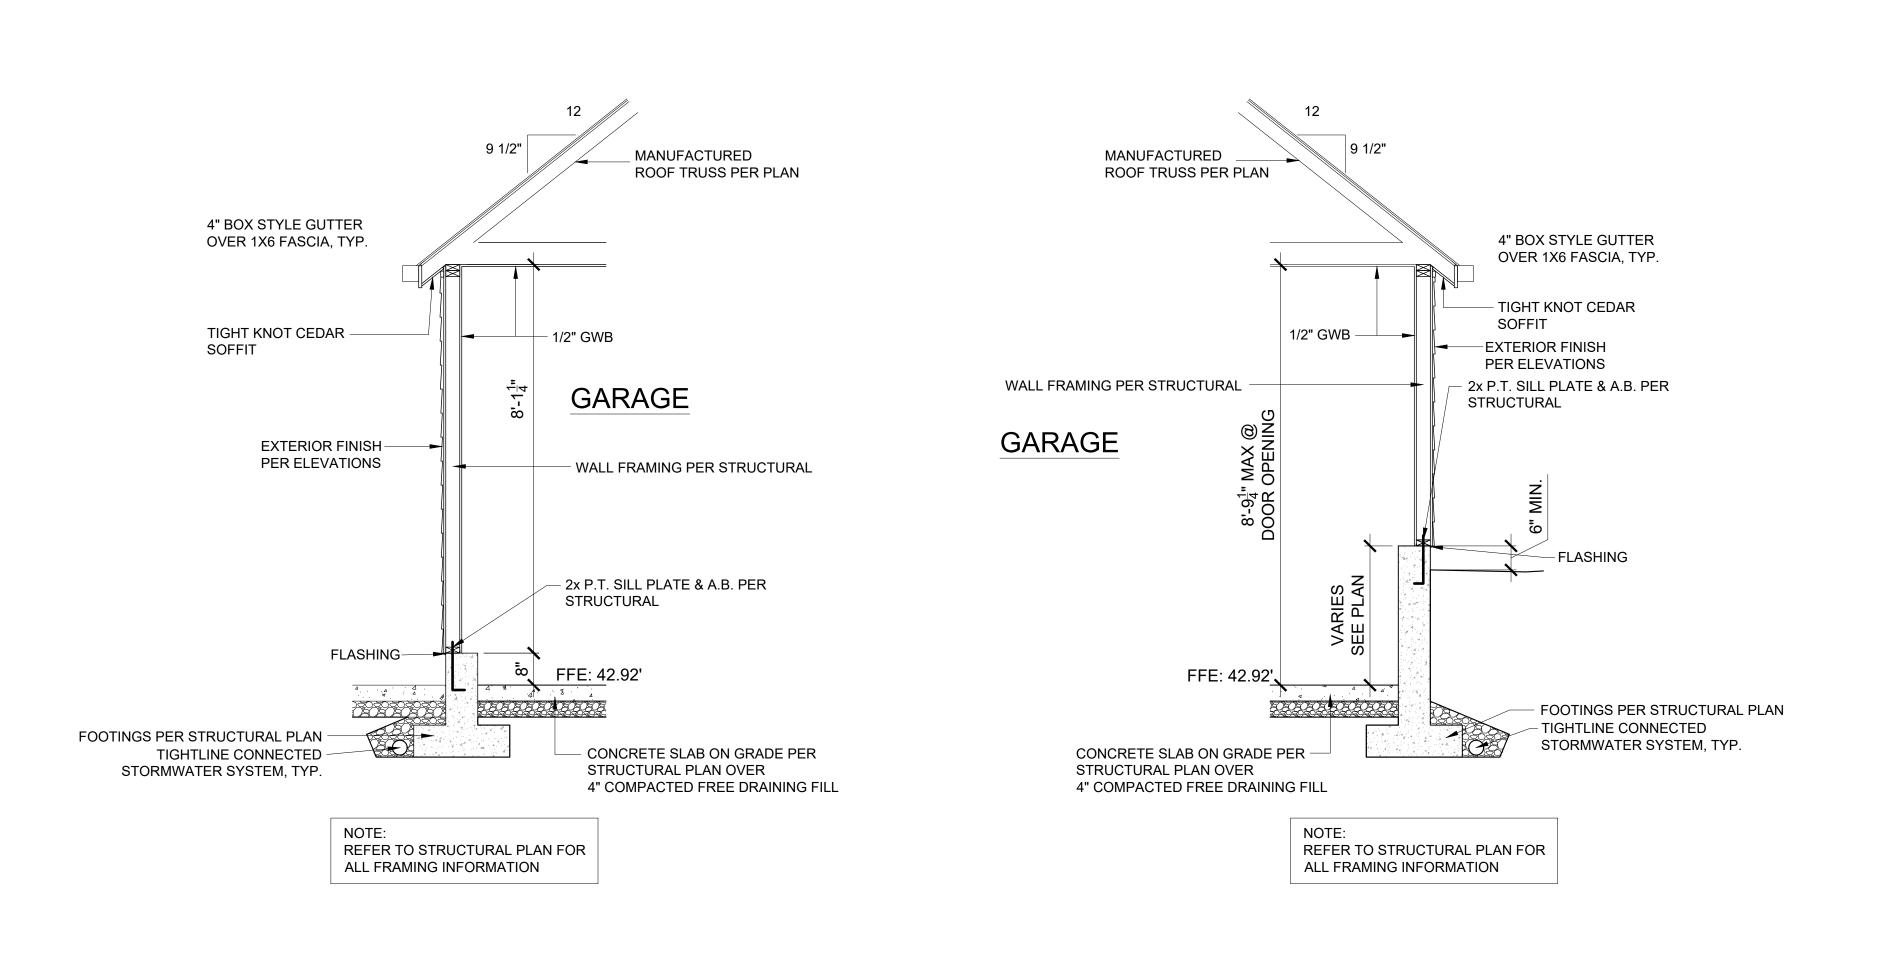




SCALE: 1/4" = 1'-0"

DETACHED GARAGE PROJECT WEST ELEVATION

DETACHED GARAGE PROJECT SOUTH ELEVATION



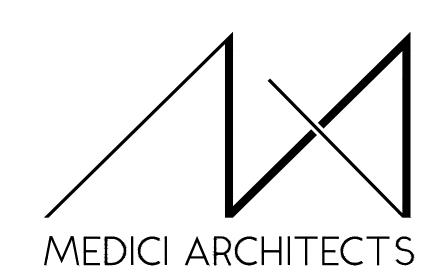
A DETACHED GARAGE WALL SECTION

SCALE: 1/2" = 1'-0"

@ FULL HEIGHT FRAMED WALL

B DETACHED GARAGE WALL SECTION

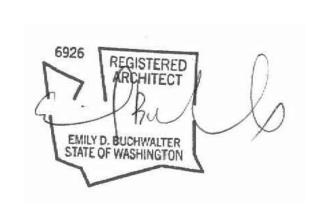
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PARCEL # 082405-9027

DRAWING NAME:

DETACHED GARAGE
ELEVATIONS

Drawn By: JMG,RB

Owner Approval:
PHASE:

Checked By: EB

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PROJECT No.: 2020 007

DATE: 12-22-2020

GENERAL STRUCTURAL NOTES (THE FOLLOWING APPLY UNLESS SHOWN OTHERWISE ON THE PLANS.)

1. ALL MATERIALS, WORKMANSHIP, DESIGN, AND CONSTRUCTION FOR NEW CONSTRUCTION SHALL CONFORM TO THE DRAWINGS, SPECIFICATIONS, AND THE INTERNATIONAL BUILDING CODE (IBC), 2015 EDITION.

2. STRUCTURAL DRAWINGS SHALL BE USED IN CONJUNCTION WITH ARCHITECTURAL DRAWINGS FOR BIDDING AND CONSTRUCTION. CONTRACTOR SHALL VERIFY DIMENSIONS AND CONDITIONS FOR COMPATIBILITY AND SHALL NOTIFY ARCHITECT OF ANY DISCREPANCIES PRIOR TO CONSTRUCTION. SEE ARCHITECTURAL DRAWINGS FOR EXACT LOCATIONS AND DIMENSIONS OF DOOR AND WINDOW OPENINGS. SEE MECHANICAL DRAWINGS FOR SIZE AND LOCATION OF MISCELLANEOUS MECHANICAL OPENINGS.

3. CONTRACTOR SHALL VERIFY ALL EXISTING DIMENSIONS, MEMBER SIZES, AND CONDITIONS PRIOR TO COMMENCING ANY WORK. ALL DIMENSIONS OF EXISTING CONSTRUCTION SHOWN ON THE DRAWINGS ARE INTENDED AS GUIDELINES ONLY AND MUST BE VERIFIED.

4. DEMOLITION: CONTRACTOR SHALL VERIFY ALL EXISTING CONDITIONS BEFORE COMMENCING ANY DEMOLITION. SHORING SHALL BE INSTALLED TO SUPPORT EXISTING CONSTRUCTION AS REQUIRED AND IN A MANNER SUITABLE TO THE WORK SEQUENCE. EXISTING REINFORCING SHALL BE SAVED WHERE AND AS NOTED ON THE PLANS. SAW CUTTING, IF AND WHERE USED, SHALL NOT CUT EXISTING REINFORCING THAT IS TO BE SAVED. DEMOLITION DEBRIS SHALL NOT BE ALLOWED TO DAMAGE OR OVERLOAD THE EXISTING STRUCTURE. LIMIT CONSTRUCTION LOADING (INCLUDING DEMOLITION DEBRIS) ON EXISTING FLOOR SYSTEMS TO 40 PSF.

4.1 ALL OPENINGS THROUGH EXISTING CONCRETE WALLS, SLABS AND BEAMS SHALL BE ACCOMPLISHED BY SAW CUTTING AND/OR CORING WHEREVER POSSIBLE. SAW CUT TO TERMINATE AT CORING AT CORNERS OF OPENING. DO NOT OVERCUT CORNERS.

4.2 CONTRACTOR SHALL VERIFY ALL EXISTING CONDITIONS AND LOCATION OF MEMBERS PRIOR TO CUTTING ANY OPENINGS.

4.3 SMALL ROUND OPENINGS THROUGH CONCRETE SHALL BE ACCOMPLISHED BY CORE DRILLING IF POSSIBLE.

4.4 WHERE NEW REINFORCING TERMINATES AT EXISTING CONCRETE, DOWEL BARS SHALL BE DRILLED AND EPOXIED INTO EXISTING CONCRETE TO MATCH NEW HORIZONTAL REINFORCING AS NOTED ON PLANS.

BASEMENT AND CRAWL SPACES. ALL ROT SHALL BE REMOVED AND DAMAGED MEMBERS SHALL BE REPLACED OR REPAIRED AS DIRECTED BY THE STRUCTURAL ENGINEER OR ARCHITECT. 6. CONTRACTOR SHALL PROVIDE TEMPORARY BRACING FOR THE STRUCTURE AND STRUCTURAL COMPONENTS OF THE NEW CONSTRUCTION UNTIL ALL FINAL CONNECTIONS HAVE BEEN COMPLETED IN ACCORDANCE WITH THE PLANS. THE CONTRACTOR SHALL ALSO PROVIDE TEMPORARY BRACING AND SHORING OF THE EXISTING BUILDING(S) IN WHICH PORTIONS OF THE

5. CONTRACTOR SHALL CHECK FOR DRYROT AT ALL EXTERIOR WALLS. EXISTING TOILET ROOM FLOORS AND WALLS. AREAS SHOWING WATER STAINS. AND ALL WOOD MEMBERS IN THE

EXISTING STRUCTURE ARE TO BE REMOVED OR MODIFIED. THIS TEMPORARY BRACING AND SHORING SHALL REMAIN IN PLACE UNTIL NEW CONSTRUCTION AND/OR STRUCTURAL MODIFICATIONS ARE COMPLETED. THE CONTRACTOR SHALL DESIGN, PROVIDE MATERIALS FOR AND INSTALL (AND REMOVE IF NECESSARY) SUCH TEMPORARY WORK. 7. CONTRACTOR SHALL BE RESPONSIBLE FOR ALL SAFETY PRECAUTIONS AND THE METHODS, TECHNIQUES, SEQUENCES OR PROCEDURES REQUIRED TO PERFORM HIS WORK.

STRUCTURAL DESIGN OF THE BUILDING IS BASED ON RESISTANCE TO DEAD LOADS, CODE SPECIFIED LATERAL LOADS, AND MAXIMUM EXPECTED SERVICE LOADS. NO CONSIDERATION HAS BEEN GIVEN TO LOADS WHICH WILL BE INDUCED BY ERECTION PROCEDURES. THE CONTRACTOR SHALL VERIFY, TO THE SATISFACTION OF HIM/HERSELF AND THE OWNER, THE ABILITY OF THE STRUCTURE TO RESIST ALL ERECTION LOADS WITHOUT EXCEEDING THE ALLOWABLE STRESSES OF THE MATERIALS USED. WHERE ERECTION LOADS WOULD OVERSTRESS THE STRUCTURE, THE CONTRACTOR SHALL SUBMIT DESIGN DOCUMENTS FOR TEMPORARY BRACING AND STRENGTHENING, INCLUDING FABRICATION AND ERECTION DRAWINGS, TO THE ARCHITEC FOR REVIEW. THESE DOCUMENTS SHALL BEAR THE SEAL AND SIGNATURE OF A REGISTERED STRUCTURAL ENGINEER IN THE STATE OF WASHINGTON. THE CONTRACTOR SHALL PROVIDE, INSTALL AND IF NECESSARY REMOVE SUCH TEMPORARY WORK AS REQUIRED.

8. CONTRACTOR-INITIATED CHANGES SHALL BE SUBMITTED IN WRITING TO THE ARCHITECT AND STRUCTURAL ENGINEER FOR APPROVAL PRIOR TO FABRICATION OR CONSTRUCTION. CHANGES SHOWN ON SHOP DRAWINGS ONLY WILL NOT SATISFY THIS REQUIREMENT.

9. DRAWINGS INDICATE GENERAL AND TYPICAL DETAILS OF CONSTRUCTION. WHERE CONDITIONS ARE NOT SPECIFICALLY INDICATED, BUT ARE OF SIMILAR CHARACTER TO DETAILS SHOWN, SIMILAR DETAILS OF CONSTRUCTION SHALL BE USED, SUBJECT TO REVIEW AND APPROVAL BY THE ARCHITECT AND THE STRUCTURAL ENGINEER.

10. ALL STRUCTURAL SYSTEMS WHICH ARE TO BE COMPOSED OF COMPONENTS TO BE FIELD ERECTED SHALL BE SUPERVISED BY THE SUPPLIER DURING MANUFACTURING, DELIVERY,

HANDLING, STORAGE AND ERECTION IN ACCORDANCE WITH INSTRUCTIONS PREPARED BY THE SUPPLIER.

11. INSPECTIONS: INSPECTIONS OF THE WOOD FRAMING. THE STEEL REBAR AND WOOD FORMS FOR CONCRETE FOOTINGS & FOUNDATIONS, AND CONCRETE SLABS ARE REQUIRED PER IBC SECTION 110.3.

12. SHOP DRAWINGS FOR REINFORCING STEEL STRUCTURAL STEEL, GLUED LAMINATED MEMBERS, ENGINEERED LUMBER SHALL BE SUBMITTED TO THE ARCHITECT AND STRUCTURAL ENGINEER FOR REVIEW PRIOR TO FABRICATION OF THESE ITEMS.

ENGINEER OF RECORD SHALL REVIEW SHOP DRAWINGS FOR DESIGN INTENT ONLY. DIMENSIONS AND QUANTITIES ARE NOT GUARANTEED BY THE ENGINEER OF RECORD, AND THEREFORE, MUST BE VERIFIED BY THE GENERAL CONTRACTOR. DRAWINGS FOR COMPONENTS DESIGNED PRIMARILY BY OTHERS SHALL BE APPROVED BY THE COMPONENT DESIGNER PRIOR TO CURSORY REVIEW BY THE ENGINEER OF RECORD FOR LOADS IMPOSED ON THE BASIC STRUCTURE. SUBMITTALS SHALL INCLUDE A REPRODUCIBLE AND A COPY; REPRODUCIBLE WILL BE REVIEWED AND RETURNED. SHOP DRAWINGS MUST BE REVIEWED AND STAMPED BY CONTRACTOR PRIOR TO REVIEW BY ENGINEER.

13. PRE-MANUFACTURED, PRE-ENGINEERED STRUCTURAL COMPONENTS SHALL BE DESIGNED BASED ON THE CRITERIA PRESENTED IN THE CONTRACT DOCUMENTS. THE COMPONENT DESIGNER IS RESPONSIBLE FOR CODE CONFORMANCE, TEMPORARY AND PERMANENT BRACING AND ALL NECESSARY CONNECTIONS, INCLUDING CONNECTIONS TO THE PRIMARY STRUCTURE, NOT SPECIFICALLY CALLED OUT ON THE ARCHITECTURAL OR STRUCTURAL DRAWINGS. SHOP DRAWINGS SHALL INDICATE THE MAGNITUDE AND DIRECTION OF ALL LOADS IMPOSED ON THE PRIMARY STRUCTURE. SHOP DRAWINGS AND CALCULATIONS SHALL BE SUBMITTED PER PARAGRAPH "A.14." OF THESE NOTES.

15. DEFERRED SUBMITTALS — THE FOLLOWING ITEMS ARE CONSIDERED TO BE DEFERRED SUBMITTALS UNDER SECTION 107.3.4.1 OF THE INTERNATIONAL BUILDING CODE AND MUST BE SUBMITTED TO THE ARCHITECT OR THE ENGINEER FOR REVIEW. THESE ITEMS WILL THEN BE FORWARDED TO THE BUILDING OFFICIAL FOR APPROVAL. THE DEFERRED SUBMITTAL ITEMS SHALL NOT BE INSTALLED UNTIL THEIR DESIGN AND SUBMITTAL DOCUMENTS HAVE BEEN APPROVED BY THE BUILDING OFFICIAL. DESIGN SUBMITTALS SHALL BEAR THE STAMP AND SIGNATURE OF A REGISTERED STRUCTURAL ENGINEER IN THE STATE OF WASHINGTON

B. DESIGN CRITERIA

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1. DESIGN LOADS
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25 PSF (SNOW*, IS=1.0) ROOF LIVE LOAD ROOF DEAD LOAD 15 PSF (20 PSF @ GLASS ROOF) FLOOR LIVE LOAD (RESIDENTIAL) 40 PSF (REDUCIBLE) FLOOR DEAD LOAD 15 PSF DECK LIVE LOAD 60 PSF (REDUCIBLE) DECK DEAD LOAD 25 PSF

* PRE-ENGINEERED GLASS STAIR TREADS, GLASS GUARDRAILS AND GLASS ROOF.

WIND (ASCE 7-10) $V_{\text{w}} = 110 \text{ MPH}, V_{\text{m}} = 85 \text{ MPH}, (3 \text{ SEC GUST})$ ENCLOSED BUILDING, EXPOSURE "C", IW=1.0, KZT = 1.0

EARTHQUAKE (ASCE 7-10)

SITE CLASS D OCCUPANCY CATEGORY II (IE = 1.0) SEISMIC DESIGN CATEGORY D SS = 1.382G, S1 = 0.531GSDS=0.921G, SD1 = 0.531G

R=6.5, R=1.3

 $V_{\text{scr}} = C_{\text{sW}} = 0.129W$ EQUIVALENT LATERAL FORCE PROCEDURE

0.35 COEFFICIENT OF FRICITION

LATERAL LOADS ARE RESISTED BY STRUCTURAL WOOD PANEL SHEAR WALLS & DIAPHRAGMS

ALLOWABLE SOIL PRESSURE** 1,500 PSF LATERAL EARTH PRESSURE** 35 PCF ACTIVE\100 PSF SURCHARGE\7H SEISMIC 55 PCF AT-REST\14H SEISMIC 250 PSF PASSIVE

*FOR SNOW DRIFT CALCULATIONS, PG = 15 PSF **SOILS REPORT REFERENCE: N/A

C. FOUNDATION

1. FOUNDATION EXCAVATION, BACKFILL AND COMPACTION SHALL CONFORM TO SPECIFICATION REQUIREMENTS. THIS CONSTRUCTION WORK, INCLUDING DRAINAGE, SHORING AND SUCH OTHER RELATED WORK AS REQUIRED, SHALL BE CONDUCTED BY THE CONTRACTOR UNDER THE OBSERVATION AND DIRECTION OF THE GEOTECHNICAL ENGINEER.

2. FOOTINGS SHALL BEAR ON SOLID UNDISTURBED EARTH (CONTROLLED, COMPACTED STRUCTURAL FILL OR BOTH) AT LEAST 18" BELOW LOWEST ADJACENT FINISHED GRADE. MATERIAL

3. FOOTINGS MAY BE POURED IN NEAT EXCAVATIONS PROVIDED SIZE IS INCREASED 3" AT EACH INTERFACE WITH SOIL.

4. ALL FOOTING EXCAVATIONS SHALL BE HAND CLEANED PRIOR TO PLACING CONCRETE.

TO BE COMPACTED TO 95% MINIMUM OF MAXIMUM DRY DENSITY AS DETERMINED BY ASTM D1557.

5. ALL ABANDONED FOOTINGS, UTILITIES, ETC. THAT INTERFERES WITH NEW CONSTRUCTION SHALL BE REMOVED.

6. CONTRACTOR SHALL PROVIDE FOR DESIGN AND INSTALLATION OF ALL CRIBBING, SHEATHING, AND SHORING REQUIRED TO SAFELY RETAIN EXCAVATIONS.

7. BACKFILL BEHIND ALL WALLS WITH WELL DRAINING, GRANULAR FILL MATERIAL, AND PROVIDE PERFORATED PIPE DRAINS AS DESCRIBED IN THE SOILS REPORT. BACKFILL BEHIND WALLS SHALL NOT BE PLACED BEFORE THE WALL IS PROPERLY SUPPORTED BY THE FLOOR SLAB, OR TEMPORARY BRACING. ALL FOOTINGS SHALL BE CENTERED BELOW CENTERLINE OF COLUMNS OR WALLS ABOVE, UNLESS NOTED OTHERWISE.

D. CONCRETE

1. ULTIMATE STRENGTH DESIGN PER INTERNATIONAL BUILDING CODE AND ACI 318-14.

2. CONCRETE SHALL MEET THE FOLLOWING MINIMUM REQUIREMENTS

2.1 CONCRETE SHALL ATTAIN A 28-DAY STRENGTH OF F'C = 3,500 PSI AND MIX SHALL CONTAIN NOT LESS THAN 5-1/2 SACKS OF CEMENT PER CUBIC YARD AND SHALL BE PROPORTIONED TO PRODUCE A SLUMP OF 5" OR LESS, EXPOSURE CLASS F1, S0, WO & CO. DESIGN IS BASED ON F'C = 2.500 PSL.

3. THE MINIMUM AMOUNTS OF CEMENT AND MAXIMUM AMOUNTS OF WATER MAY BE CHANGED IF A CONCRETE DESIGN MIX IS SUBMITTED TO THE STRUCTURAL ENGINEER AND THE BUILDING DEPARTMENT FOR APPROVAL TWO WEEKS PRIOR TO PLACING ANY CONCRETE. THE CONCRETE PERFORMANCE MIX SHALL INCLUDE THE AMOUNTS OF CEMENT, FINE AND COARSE AGGREGATE, WATER AND ADMIXTURES AS WELL AS THE WATER CEMENT RATIO, SLUMP, CONCRETE YIELD AND SUBSTANTIATING STRENGTH DATA IN ACCORDANCE WITH ACI 318, CHAPTERS

ALL CONCRETE EXPOSED TO FREEZING TEMPERATURES WHILE CURING AND ALL CONCRETE PERMANENTLY EXPOSED TO WEATHER SHALL BE AIR-ENTRAINED WITH AN AIR-ENTRAINING AGENT CONFORMING TO ACI 318. TOTAL AIR CONTENT SHALL BE 6% IN ACCORDANCE WITH TABLE 19.3.3.1.

NO ADMIXTURES. OTHER THAN FOR AIR-ENTRAINMENT AS NOTED ABOVE. SHALL BE USED WITHOUT PRIOR REVIEW BY THE STRUCTURAL ENGINEER.

REINFORCING

REINFORCING STEEL SHALL BE DEFORMED BARS CONFORMING TO ASTM A615 (INCLUDING SUPPLEMENT S1), GRADE 60, FY = 60,000 PSI. REINFORCEMENT FOR COLUMNS, WALLS, WALL TO FOOTING DOWELS, AND WOOD SHEAR WALL HOLD DOWNS TO BE A706 UNLESS CERTIFIED MILL CERTIFICATES CONFORMING TO ACI 318 20.2.2.5 ARE PROVIDED.

WELDED WIRE REINFORCEMENT: ASTM A82 AND ASTM A185, SPLICE WITH AT LEAST ONE FULL MESH. PLACE AT MID-DEPTH, OR SLIGHTLY ABOVE, OF SLAB. MATERIAL TO BE SUPPLIED IN FLAT SHEETS.

5. REINFORCING STEEL SHALL BE DETAILED (INCLUDING HOOKS AND BENDS) IN ACCORDANCE WITH ACI 318 (LATEST EDITION). LAP ALL CONTINUOUS REINFORCEMENT PER NOTE D.6.

PROVIDE CORNER BARS AT ALL WALL INTERSECTIONS. LAP CORNER BARS PER NOTE D.6. LAP ADJACENT MATS OF WELDED WIRE REINFORCEMENT A MINIMUM OF 8" AT SIDES AND ENDS.

NO BARS PARTIALLY EMBEDDED IN HARDENED CONCRETE SHALL BE FIELD BENT UNLESS SPECIFICALLY SO DETAILED OR APPROVED BY THE STRUCTURAL ENGINEER.

6. REINFORCING STEEL LAPS AND EMBEDMENT SHALL BE AS NOTED BELOW, UNLESS NOTED OTHERWISE:

DEVELOPMENT LENGTH - COMPRESSION 20 BAR DIAM. – 24" MINIMUM DEVELOPMENT LENGTH — TENSION 48 BAR DIAM. — (#11 BAR — 54 BAR DIA.) DEVELOPMENT LENGTH - TENSION, TOP BAR* BAR DIAM. — (#11 BAR — 70 BAR DIA.)

DIAM. - 24" MINIMUM LAP SPLICE LENGTH - COMPRESSION LAP SPLICE LENGTH - TENSION

64 BAR DIAM. – (#11 BAR – 70 BAR DIAM.) LAP SPLICE LENGTH - TENSION, TOP BAR 80 BAR DIAM. — (#11 BAR — 90 BAR DIAM.)

*TOP BARS ARE HORIZONTAL REINFORCEMENT SO PLACED THAT MORE THAN 12" OF CONCRETE IS CAST IN THE MEMBER BELOW THE BAR.

ALL HOOKS SHALL BE "STANDARD" IN ACCORDANCE WITH ACI 318. REINFORCING SHALL NOT BE TACK WELDED. DO NOT WELD GRADE 60 REINFORCING.

MANUFACTURED BY DICKERHOFF AND WINDMANN, INC., IN CONFORMANCE WITH ASTM A722 (FPU = 150,000). 8. MECHANICAL SPLICING OF REINFORCING BARS, WHERE INDICATED ON THE DRAWINGS, SHALL BE BY AN INTERNATIONAL CODE COUNSEL (ICC) APPROVED SYSTEM (SUCH AS LENTON, FOX-HOWLETT, ETC.) AND SHALL DEVELOP 125% OF THE SPECIFIED YIELD STRENGTH OF THE BARS. SPLICE LOCATIONS OF ALTERNATE BARS SHALL BE OFFSET BY A DISTANCE WHICH

7. HIGH STRENGTH THREADED RODS (STRESSED AND NON-STRESSED) SHALL BE DYWIDAG THREADBARS WITH APPROPRIATE ANCHORAGE PLATES, NUTS, AND COUPLERS AS

9. CONCRETE PROTECTION (COVER) FOR REINFORCING STEEL SHALL BE AS FOLLOWS:

CONFORMS TO THE ICC REPORT OF THE SPLICE USED.

FOOTINGS AND OTHER UNFORMED SURFACES, EARTH FACE 3 FORMED SURFACES EXPOSED TO EARTH (I.E. WALLS BELOW GROUND) OR WEATHER (#6 BARS OR LARGER) 2" (#5 BARS OR SMALLER) 1-1/2" COLUMN TIES OR SPIRALS AND BEAM STIRRUPS 1-1/2" JOISTS, SLABS AND WALLS (INTERIOR FACE)

10. NON-SHRINK GROUT SHALL BE FURNISHED BY AN APPROVED MANUFACTURER AND SHALL BE MIXED AND PLACED IN STRICT ACCORDANCE WITH THE MANUFACTURER'S PUBLISHED RECOMMENDATIONS. GROUT SHALL BE NON-SHRINK, CEMENT-BASED AND HAVE A MINIMUM COMPRESSIVE STRENGTH AT 28 DAYS OF F'C = 5000 PSI WHEN TESTED IN ACCORDANCE WITH ASTM C109.

11. ADHESIVE ANCHOR SYSTEM SHALL BE SET-XP OR SET-3G EPOXY BY SIMPSON STRONG-TIE, HIT-HY 200-A OR HIT-RE 500 V3 BY HILTI, AC200+ BY DEWALT, OR APPROVED

12. ALL WOOD PLATES IN DIRECT CONTACT WITH CONCRETE OR MASONRY SHALL BE PRESSURE—TREATED (SEE WOOD SECTION).

E. STRUCTURAL STEEL

1. STRUCTURAL STEEL DESIGN, FABRICATION, AND ERECTION SHALL BE BASED ON THE AISC 360 "SPECIFICATION FOR THE DESIGN, FABRICATION AND ERECTION OF STRUCTURAL STEEL FOR BUILDINGS," LATEST EDITION, PLUS ALL REFERENCED CODES.

2. ALL "W" (WIDE FLANGE BEAM AND COLUMN) SHAPES SHALL CONFORM TO ASTM A992. HP SHAPES SHALL CONFORM TO ASTM A572, FY = 50 KSI. PLATES, BARS AND OTHER ROLLED SHAPES SHALL CONFORM TO ASTM A36. FY = 36 KSI. UNLESS CALLED OUT OTHERWISE ON PLAN. STEEL PIPE SHALL BE SCHEDULE 40 CONFORMING TO ASTM A53. TYPE E OR S, GRADE B, FY = 35 KSI. RECTANGULAR HSS SHALL CONFORM TO ASTM A500, GRADE B, FY = 46 KSI, ROUND HSS SHALL CONFORM TO ASTM A500, GRADE B, FY = 42 KSI.

3. ANCHOR BOLTS SHALL CONFORM TO ASTM A307 AND HAVE A WELDED HEAD. EMBED ANCHOR BOLTS A MINIMUM OF 7" INTO CONCRETE.

5. ALL CONNECTION BOLTS AT STEEL/STEEL CONNECTIONS SHALL BE ASTM A325 OR ASTM A490 AND SHALL BE INSTALLED, TIGHTENED, AND INSPECTED IN ACCORDANCE WITH THE AISC "SPECIFICATION FOR STRUCTURAL JOINTS USING ASTM A325 OR A 490 BOLTS." THE CRITERIA FOR SNUG-TIGHT CONNECTIONS SHALL APPLY TO ALL CONNECTIONS UNLESS SPECIFICALLY NOTED AS SLIP-CRITICAL ON THE STRUCTURAL DRAWINGS. WHERE CONNECTIONS ARE NOTED AS SLIP-CRITICAL, THE CONTRACTOR SHALL INSTALL PER CRITERIA FOR SLIP-CRITICAL CONNECTIONS. SLIP-CRITICAL CONNECTIONS SHALL USE LOAD INDICATOR WASHERS OR TENSION CONTROL BOLTS. ALL BOLT HOLES SHALL BE STANDARD SIZE, UNLESS NOTED OTHERWISE.

5. THE CONTRACTOR SHALL BE RESPONSIBLE FOR THE COORDINATION OF THE SELECTION OF OPTIONAL DETAILS SHOWN ON THE DRAWINGS. THE CONTRACTOR SHALL ALSO BE RESPONSIBLE FOR ALL ERECTION AIDS AND JOINT PREPARATIONS THAT INCLUDE, BUT ARE NOT LIMITED TO: ERECTION ANGLES, LIFT HOLES, AND OTHER AIDS; WELDING PROCEDURES; REQUIRED ROOT OPENINGS; ROOT FACE DIMENSIONS; GROOVE ANGLES; BACKING BARS; COPES; SURFACE ROUGHNESS VALUES; AND TAPERS OF UNEQUAL PARTS.

6. EXPANSION BOLTS INTO CONCRETE SHALL BE "STRONG-BOLT 2" WEDGE ANCHORS BY SIMPSON STRONG-TIE, "KWIK BOLT TZ" WEDGE ANCHORS BY HILTI, POWER-STUD+ SD2, OR APPROVED EQUAL INSTALLED IN STRICT ACCORDANCE WITH THE MANUFACTURER'S PUBLISHED RECOMMENDATIONS, INCLUDING MINIMUM EMBEDMENT REQUIREMENTS. SPECIAL INSPECTION IS REQUIRED FOR ALL EXPANSION BOLT AND INSERT INSTALLATION. SUBMIT MANUFACTURER'S DATA SHEETS AND ICC REPORTS FOR ENGINEER'S REVIEW.

7. ALL WELDING SHALL BE IN CONFORMANCE WITH AISC AND AWS STANDARDS AND SHALL BE PERFORMED BY WABO CERTIFIED WELDERS USING E70XX ELECTRODES. WELDS, UNLESS OTHERWISE NOTED, SHALL BE 36" CONTINUOUS FILLET WELDS. WELDS SHOWN ON DRAWINGS ARE MINIMUM SIZES. INCREASE WELD SIZE TO AWS MINIMUM SIZES, BASED ON PLATE THICKNESS. WELDING OF REINFORCING BARS (IF REQUIRED) SHALL BE PERFORMED USING LOW HYDROGEN ELECTRODES. WELDING WITHIN 4" OF COLD BENDS IN REINFORCING STEEL IS NOT PERMITTED. SEE REINFORCING NOTE FOR MATERIAL REQUIREMENTS OF WELDED BARS. WELDING PROCEDURES SHALL BE SUBMITTED TO THE OWNER'S TESTING AGENCY FOR REVIEW BEFORE STARTING FABRICATION OR ERECTION.

ALL WELDS SHALL BE VISUALLY INSPECTED AT THE SITE BY A QUALIFIED INSPECTOR.

ALL COMPLETE PENETRATION WELDS SHALL BE ULTRASONICALLY TESTED AT THE PLANT OR SITE BY A QUALIFIED INSPECTOR.

FIELD WELD ARROWS ARE SHOWN ONLY WHERE A FIELD WELD IS REQUIRED BY THE STRUCTURAL DESIGN. THE CONTRACTOR IS RESPONSIBLE FOR DETERMINING IF A WELD SHOULD BE SHOP OR FIELD WELDED IN ORDER TO FACILITATE THE STRUCTURAL STEEL ERECTION.

F. CARPENTRY

MISC. LIGHT FRAMING:

1. GLUED LAMINATED MEMBERS SHALL BE FABRICATED IN CONFORMANCE WITH ANSI STANDARD A190.1. EACH MEMBER SHALL BEAR AN AITC OR APA EWS IDENTIFICATION MARK AND SHALL BE ACCOMPANIED BY AN AITC OR APA EWS CERTIFICATE OF CONFORMANCE. ALL SIMPLE SPAN BEAMS SHALL BE DOUGLAS FIR COMBINATION 24F-V4, FB = 2,400 PSI, FV = 240 PSI. ALL CANTILEVERED BEAMS SHALL BE DOUGLAS FIR COMBINATION 24F-V8, FB = 2400 PSI, FV = 240 PSI. CAMBER ALL GLULAM BEAMS TO 2,000' RADIUS, UNLESS SHOWN OTHERWISE ON THE PLANS.

2. FRAMING LUMBER SHALL BE GRADED AND MARKED IN CONFORMANCE WITH WCLIB STANDARD GRADING RULES FOR WEST COAST LUMBER, LATEST EDITION. FURNISH TO THE FOLLOWING MINIMUM STANDARDS:

MEMBER	SIZE	SPECIES GRADE	MIN. BASIC DESIGN STRES
JOISTS AND RAFTERS:	2X, 3X 4X	HEM.FIR #2 HEM.FIR #2	FB = 850 P FB = 850 P
BEAMS AND STRINGERS:	6X AND LARGER	DOUG.FIR #1	FB = 1350 PS
POSTS AND TIMBERS: PLATES AT SHEAR WALLS AND BEARING WALLS:	6X6, 6X8	DOUG.FIR #1	FC = 1000 PS FB = 1200 PS
STUDS, PLATES, &		HEM.FIR #2	FB = 850 P

ALL LUMBER WITH A LEAST DIMENSION OF 2" (NOMINAL) SHALL BE STAMPED SURFACE—DRY AND SHALL HAVE A MOISTURE CONTENT WHEN SURFACED AND WHEN INSTALLED OF NOT MORE THAN 19 PERCENT. LUMBER WITH A LEAST DIMENSION OF 4" (NOMINAL) OR GREATER SHALL BE STAMPED SURFACE-GREEN AND AIR-DRIED TO A MOISTURE CONTENT OF NOT MORE THAN 19 PERCENT PRIOR TO ITS USE IN FRAMING THE STRUCTURE.

3. MANUFACTURED LUMBER SHALL BE AS MANUFACTURED BY TRUS JOIST OR APPROVED EQUAL. REQUESTS FOR APPROVAL AS EQUAL WILL REQUIRE SUBMITTAL OF ICC REPORT EQUIVALENT TO ESR-1387 FOR LAMINATED STRAND LUMBER (LSL), LAMINATED VENEER LUMBER (LVL), OR PARALLEL STRAND LUMBER (PSL). THE MINIMUM ALLOWABLE DESIGN VALUES ARE AS FOLLOWS:

LSL - FB = 2,250; FV = 400 PSI; E = 1,500,000 PSI LVL - FB = 2,600; FV = 285 PSI; E = 1,800,000 PSI PSL - FB = 2,900; FV = 290 PSI; E = 2,000,000 PSI

4. SHEATHING SHALL BE APA PERFORMANCE RATED PANELS PER APA "PLYWOOD DESIGN SPECIFICATION", INCLUDING APPLICABLE SUPPLEMENTS, UNLESS NOTED OTHERWISE. PLYWOOD OR ORIENTED-STRAND BOARD (OSB) PANELS SHALL BE GRADE CD AND ALSO CONFORM TO DOC PS-1 & PS-2. ALL PANELS SHALL BE IDENTIFIED AS EXPOSURE 1 UNLESS NOTED OTHERWISE. PANEL RATING TO BE AS FOLLOWS UNLESS NOTED OTHERWISE:

19/32" (OR 5/8") THICK, 40/20 15/32" THICK, 32/16, OR 1/2" THICK, 24/0

FLOORS: 23/32" (OR 3/4") THICK, TONGUE & GROOVE, (48/24)

UNLESS NOTED OTHERWISE ON THE PLANS. ROOF AND FLOOR SHEATHING SHALL BE LAID UP WITH GRAIN PERPENDICULAR TO SUPPORTS AND NAILED WITH 8D NAILS @ 6"OC TO FRAMED PANEL EDGES AND OVER STUD WALLS SHOWN ON PLANS AND @ 12"OC (10"OC AT FLOORS) TO INTERMEDIATE SUPPORTS. PROVIDE APPROVED SHEATHING EDGE CLIPS @ 16"OC AT UNBLOCKED ROOF SHEATHING EDGES. ALL FLOOR SHEATHING EDGES SHALL HAVE APPROVED TONGUE-AND-GROOVE JOINTS AND EDGE CLIPS. PROVIDE SOLID BLOCKING AT ALL EDGES ONLY WHERE NOTED ON PLANS. TOENAIL BLOCKING TO SUPPORTS WITH 16D NAILS, UNLESS NOTED OTHERWISE.

UNLESS NOTED OTHERWISE ON THE PLANS. WALL SHEATHING MAY BE LAID UP HORIZONTALLY OR VERTICALLY. UNSUPPORTED EDGES SHALL BE BLOCKED AND ALL EDGES SHALL BE NAILED WITH 8D @ 6"OC. NAIL WITH 8D @ 12"OC AT INTERMEDIATE SUPPORTS. NAIL SHEAR WALL SHEATHING TO ALL HOLDOWN STUDS USING EDGE NAIL SPACING WHEN HOLDOWN STUD DOES NOT OCCUR AT PANEL EDGES.

SHEATHING NAILS SHALL BE DRIVEN FLUSH BUT SHALL NOT FRACTURE THE SURFACE OF THE SHEATHING.

HEM.FIR #2 FB = 850 PSI

5. INTERIOR WOOD MEMBERS IN DIRECT CONTACT WITH CONCRETE OR MASONRY SHALL BE PRESSURE—TREATED WITH SODIUM BORATE (SBX). WOOD MEMBERS EXPOSED TO WEATHER (UNPAINTED) OR IN DIRECT CONTACT WITH SOIL SHALL BE PRESSURE—TREATED WITH ALKALINE COPPER QUATERNARY (ACQ). NOTE THAT ACQ IS EXTREMELY CORROSIVE TO METALS. SBX IS NONTOXIC TO THE ENVIRONMENT. PROVIDE TWO LAYERS OF ASPHALT IMPREGNATED BUILDING PAPER BETWEEN UNTREATED LEDGERS, BLOCKING, ETC., AND CONCRETE OR MASONRY. ALL METAL CONNECTORS IN CONTACT WITH "ACQ" PRESSURE-TREATED LUMBER OR FIRE-RETARDANT-TREATED LUMBER SHALL BE TYPE 304 OR 316 STAINLESS STEEL. THIS INCLUDES WASHERS, SCREWS, NAILS, HANGERS, AND ANY OTHER MISCELLANEOUS LT. GAGE METAL CONNECTORS. WHERE ACQ LUMBER IS MISTAKENLY USED OR FOR FIRE-RETARDANT-TREATED LUMBER USED IN INTERIOR CONDITIONS, ASTM A 653, TYPE G185 ("HOT-DIP" GALVANIZED TO 1.85 OUNCES PER SQUARE FOOT) METAL CONNECTORS MAY BE USED IN LIEU OF STAINLESS STEEL. METAL CONNECTORS 1/2" THICK OR GREATER NEED NOT BE GALVANIZED FOR INTERIOR USE, NOR DO THEY NEED TO BE STAINLESS STEEL FOR EXTERIOR USE. METAL CONNECTORS 1/2" THICK PLUS MUST BE GALVANIZED FOR EXTERIOR USE, UNLESS SPECIFIED OTHERWISE BY THE ARCHITECT.

6. WOOD FASTENER NOTES — THE FOLLOWING APPLY UNLESS OTHERWISE SHOWN ON THE PLANS:

6.1 NOTATIONS ON DRAWINGS RELATING TO FRAMING CLIPS, JOIST HANGERS AND OTHER CONNECTING DEVICES REFER TO CATALOG NUMBERS OF CONNECTORS MANUFACTURED BY THE SIMPSON STRONG-TIE COMPANY, DUBLIN, CALIFORNIA. EQUIVALENT DEVICES BY OTHER MANUFACTURERS MAY BE SUBSTITUTED, PROVIDED THEY HAVE ICC APPROVAL FOR EQUAL OR GREATER LOAD CAPACITIES. SUBMIT MANUFACTURER'S CATALOG AND ICC REPORTS TO ARCHITECT AND ENGINEER FOR REVIEW WHEN REQUESTING SUBSTITUTIONS. ALL SPECIFIED FASTENERS MUST BE USED AND PROPER INSTALLATION PROCEDURES MUST BE OBSERVED IN ORDER TO OBTAIN ICC APPROVED LOAD CAPACITIES. VERIFY THAT THE DIMENSIONS OF THE SUPPORTING MEMBER ARE SUFFICIENT TO RECEIVE THE SPECIFIED FASTENERS.

6.2 NAILS SHALL BE MANUFACTURED IN CANADA OR THE UNITED STATES IN SIZES AND TYPES AS FOLLOWS, UNLESS NOTED OTHERWISE:

PNEUMATIC NAILING — PLAIN SHANK, COATED OR GALVANIZED 8D = .131 DIAMETER X 2-1/2" MINIMUM LENGTH 10D = .148 DIAMETER X 3" MINIMUM LENGTH 16D = .162 DIAMETER X 3-1/4" MINIMUM LENGTH 20D = .192 DIAMETER X 4" MINIMUM LENGTH HAND NAILING — SINKERS, COATED 8D = 11-1/2 GAGE X 2-3/8" 10D = 11 GAGE X 2-7/8"

 $16D = 9 GAGE \times 3-1/4$ "

7. WOOD FRAMING NOTES - THE FOLLOWING APPLY UNLESS OTHERWISE SHOWN ON THE PLANS:

7.1 ALL WOOD FRAMING DETAILS NOT SHOWN OTHERWISE SHALL BE CONSTRUCTED TO THE MINIMUM STANDARDS OF THE INTERNATIONAL BUILDING CODE. MINIMUM NAILING, UNLESS OTHERWISE NOTED, SHALL CONFORM TO TABLE 2304.10.1 OF THE INTERNATIONAL BUILDING CODE. COORDINATE THE SIZE AND LOCATION OF ALL OPENINGS WITH MECHANICAL AND ARCHITECTURAL DRAWINGS.

7.2 WALL FRAMING: ALL STUD WALLS SHOWN AND NOT OTHERWISE NOTED SHALL BE 2X4 STUDS @ 16"OC AT INTERIOR WALLS AND 2X6 STUDS @ 16"OC AT EXTERIOR WALLS. TWO STUDS MINIMUM SHALL BE PROVIDED AT THE END OF ALL WALLS AND AT EACH SIDE OF ALL OPENINGS. UNLESS NOTED OTHERWISE A (2) 2X8 HEADER SHALL BE PROVIDED OVER ALL OPENINGS IN 2X4 STUD WALLS AND A (3) 2X8 HEADER OVER ALL OPENINGS IN 2X6 WALLS. SOLID BLOCKING FOR WOOD COLUMNS SHALL BE PROVIDED THROUGH FLOORS TO SUPPORT BELOW. PROVIDE CONTINUOUS SOLID BLOCKING AT MID-HEIGHT OF ALL STUD WALLS OVER 8'-0" IN HEIGHT.

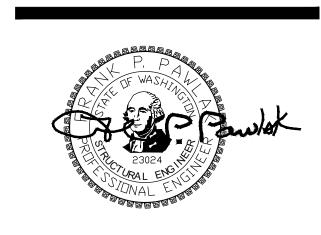
ALL STUD WALLS SHOWN ON STRUCTURAL DRAWINGS SHALL HAVE THEIR LOWER PLATES ATTACHED TO WOOD FRAMING BELOW WITH 16D NAILS AT 12"OC STAGGERED OR BOLTED TO CONCRETE OR MASONRY WITH % DIAMETER BY 10" LONG ANCHOR BOLTS, EMBEDDED 7" AND SPACED AT 4'-0"OC MAXIMUM, UNLESS NOTED OTHERWISE (UNO) ON PLANS. SHEAR WALLS REQUIRE MINIMUM 3"X3"X¼" SQUARE PLATE WASHERS AT ALL ANCHOR BOLTS. REFER TO THE STRUCTURAL PLANS AND SHEAR WALL SCHEDULE FOR REQUIRED SHEATHING AND

7.3 FLOOR AND ROOF FRAMING: PROVIDE DOUBLE JOISTS UNDER ALL PARALLEL PARTITIONS AND AROUND ALL OPENINGS IN FLOORS OR ROOFS UNLESS OTHERWISE NOTED. PROVIDE BRIDGING @ 8'-0"OC AND SOLID BLOCKING AT ALL BEARING POINTS. COORDINATE THE SIZE AND LOCATION OF ALL OPENINGS WITH ARCHITECTURAL AND MECHANICAL DRAWINGS.

TOENAIL JOISTS TO BEARING SUPPORTS WITH 16D NAILS. UNLESS NOTED OTHERWISE, ATTACH JOISTS TO FLUSH HEADERS OR BEAMS WITH SIMPSON "LU" SERIES METAL JOIST HANGERS TO SUIT JOIST SIZE. ALL DOUBLE JOISTS, BEAMS, AND SLOPED AND/OR SKEWED JOISTS SHALL BE CONNECTED TO FLUSH MEMBERS WITH U-SERIES JOIST HANGERS UNLESS

NOTED OTHERWISE. SKEW AND SLOPE ALL CONNECTORS AS REQUIRED. FACE—NAIL ALL MULTI—JOIST BEAMS TOGETHER WITH 16D SPIKES @ 24"OC STAGGERED.

1735 Westlake Ave N, Ste 205 Seattle, WA 98109 Phone: 206.456.307



တ 98 AC

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11-4-20 PERMIT

REVISIONS

NO. DATE

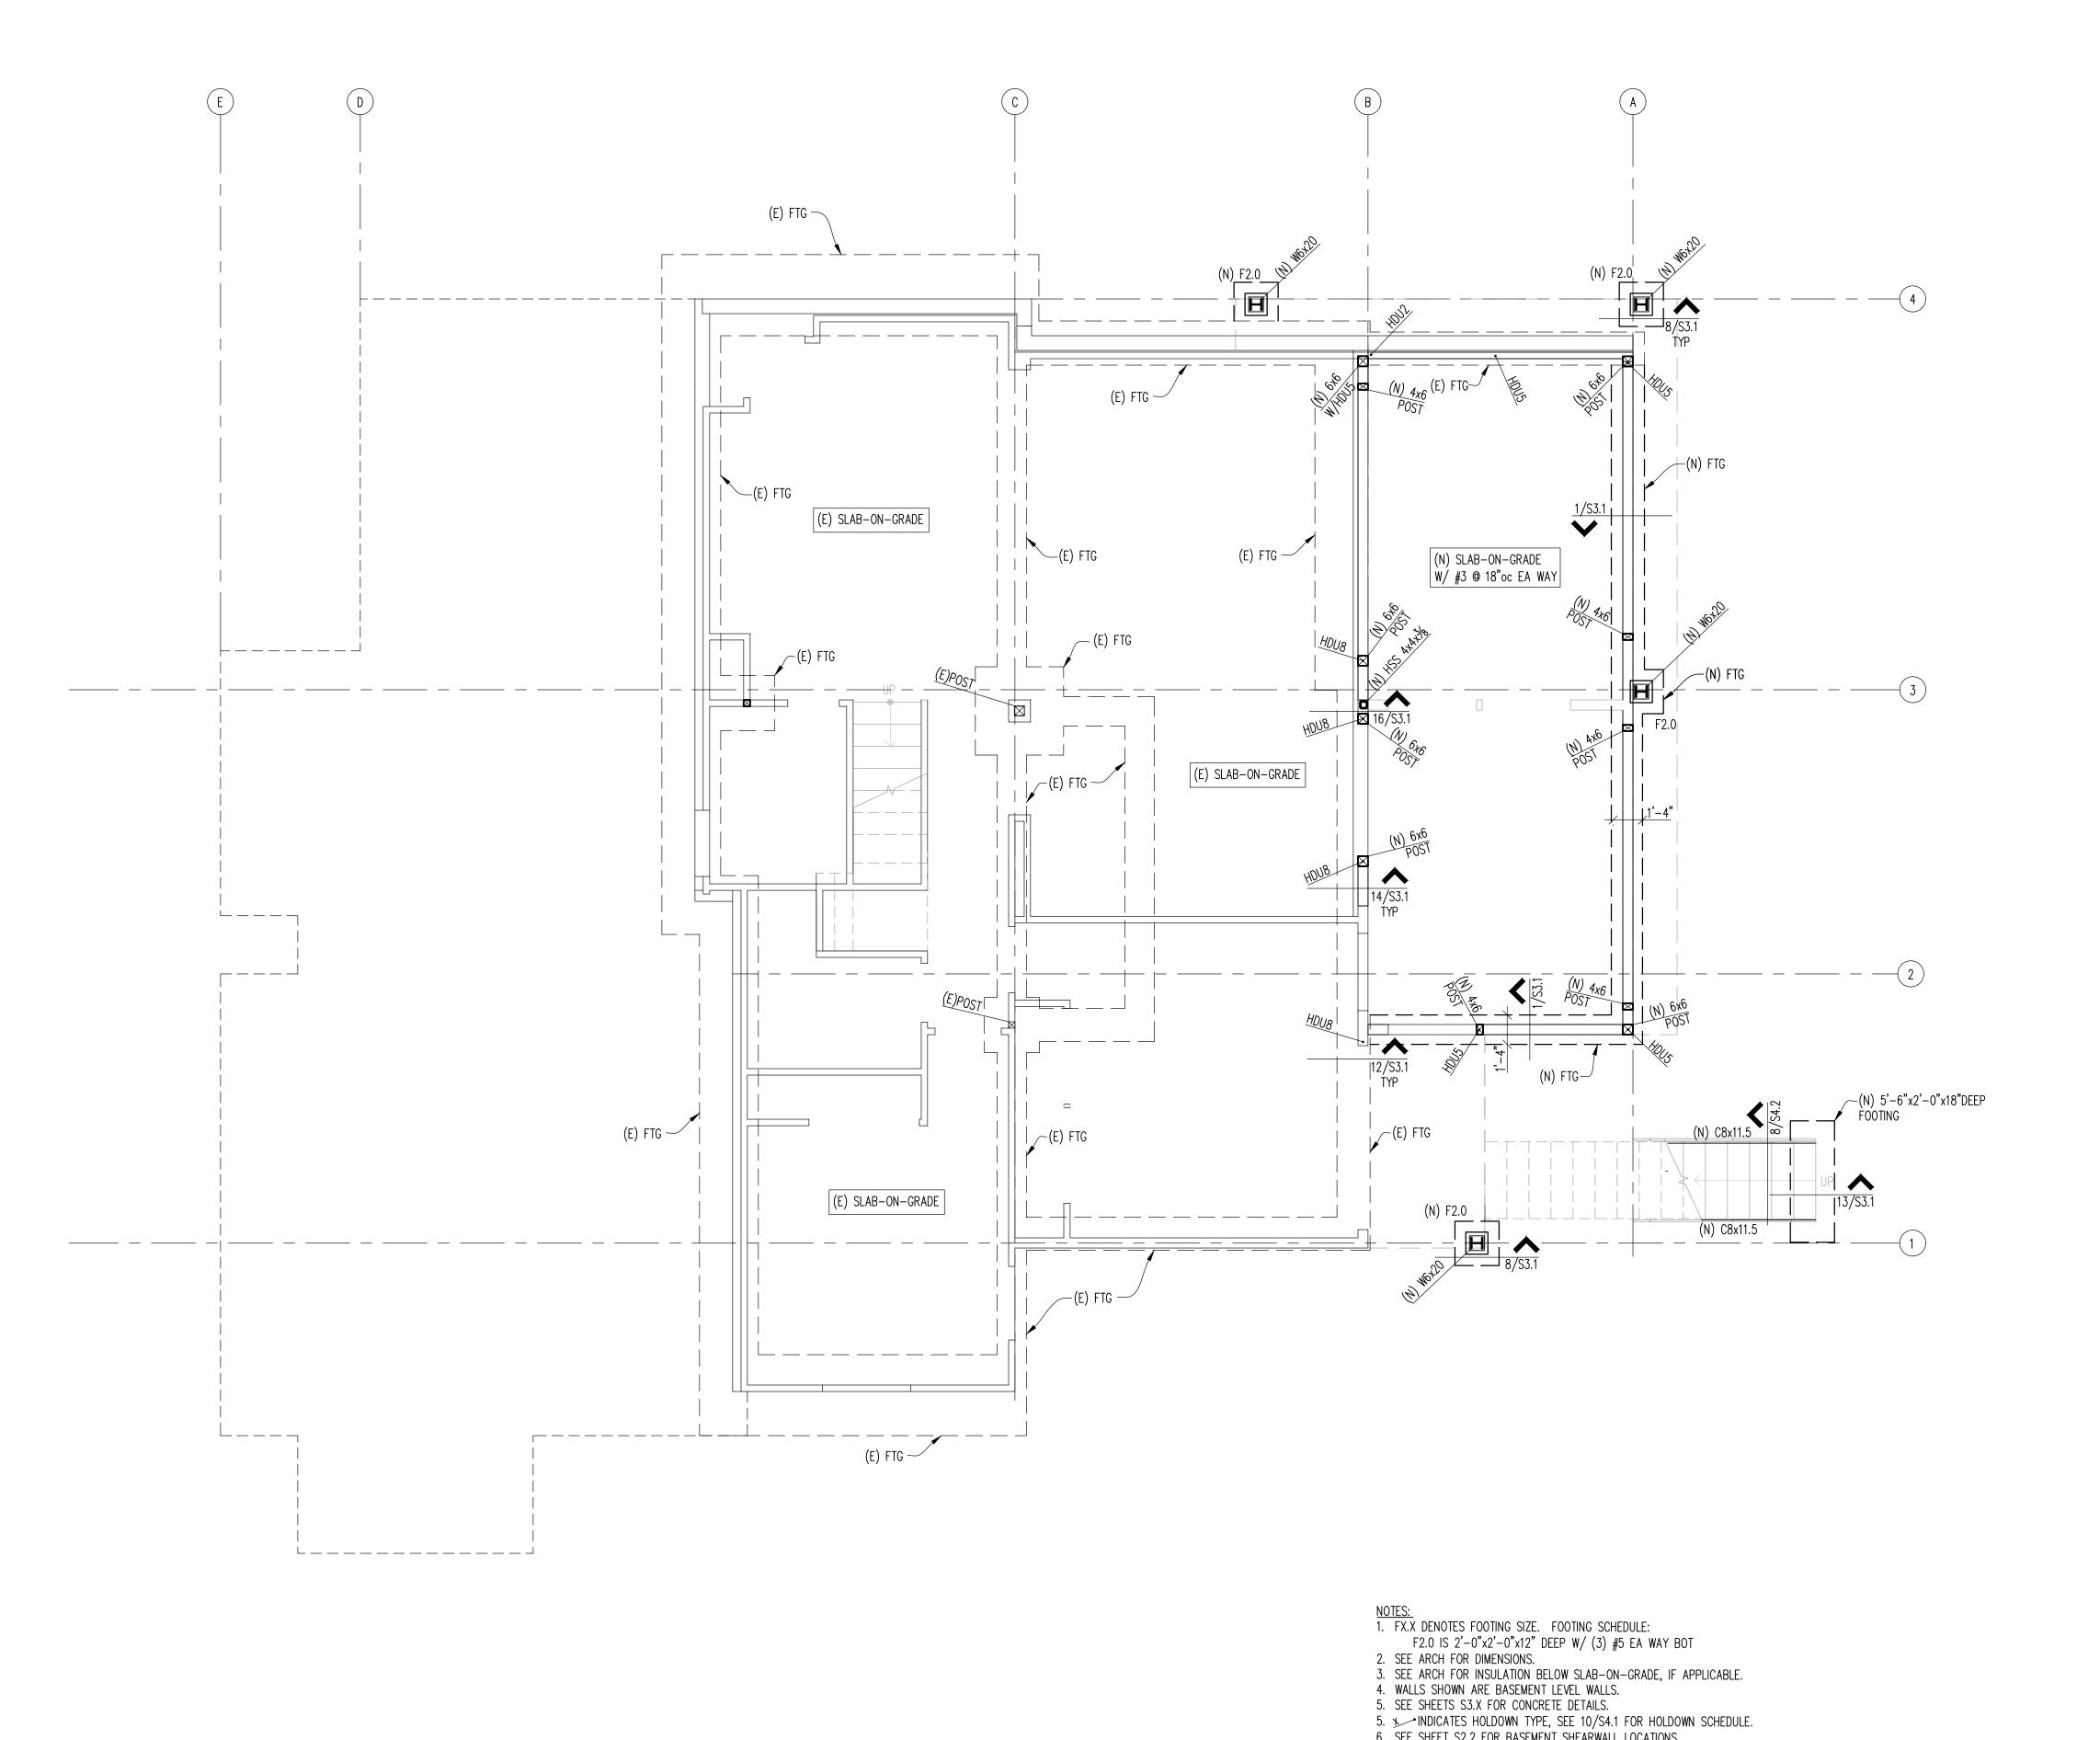
GENERAL **STRUCTURAL NOTES**

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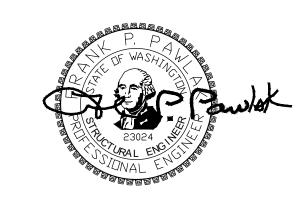
S1.1

SHEET NO.

GENERAL STRUCTURAL NOTES



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98 AC

NO. DATE ____ <u>11-4-20</u> PERMIT

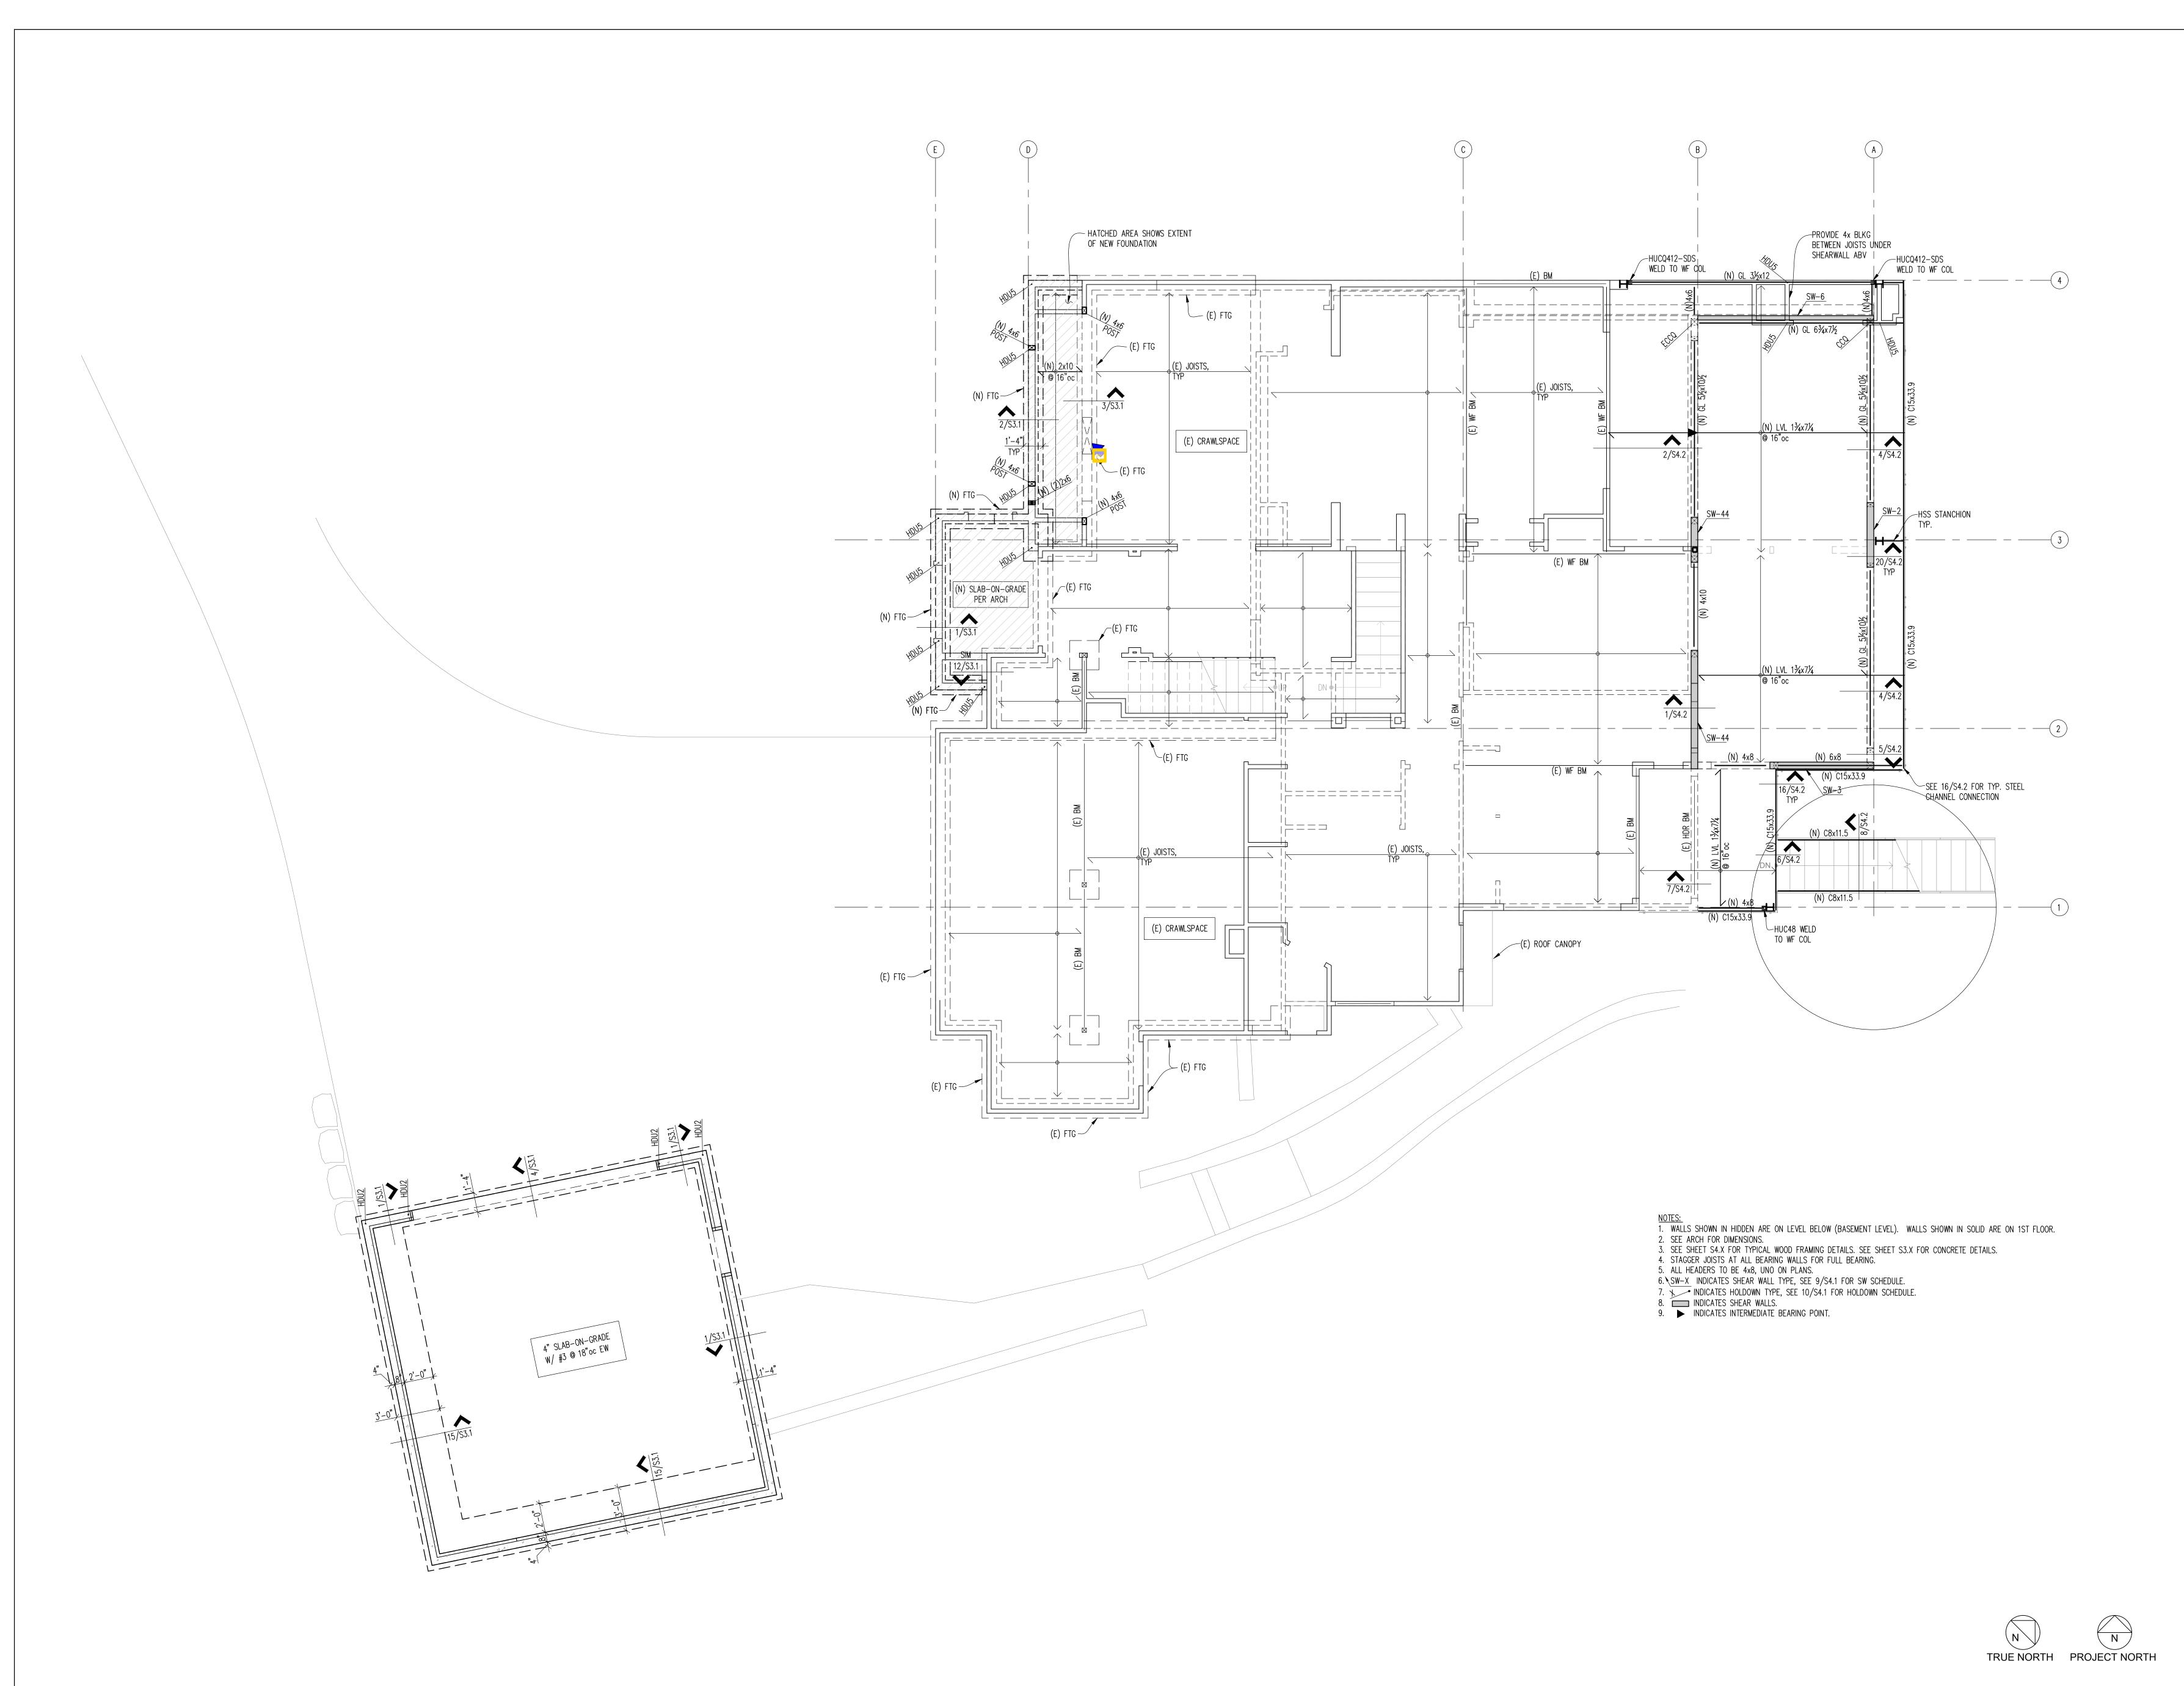
SHEET TITLE

FOUNDATION PLAN

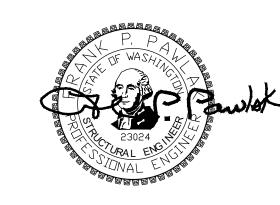
S2.1

TRUE NORTH PROJECT NORTH

6. SEE SHEET S2.2 FOR BASEMENT SHEARWALL LOCATIONS.







PROJECT

9820 SE 35TH PLACE ACHIN & MARY CHEN 9820 SE 35TH PL

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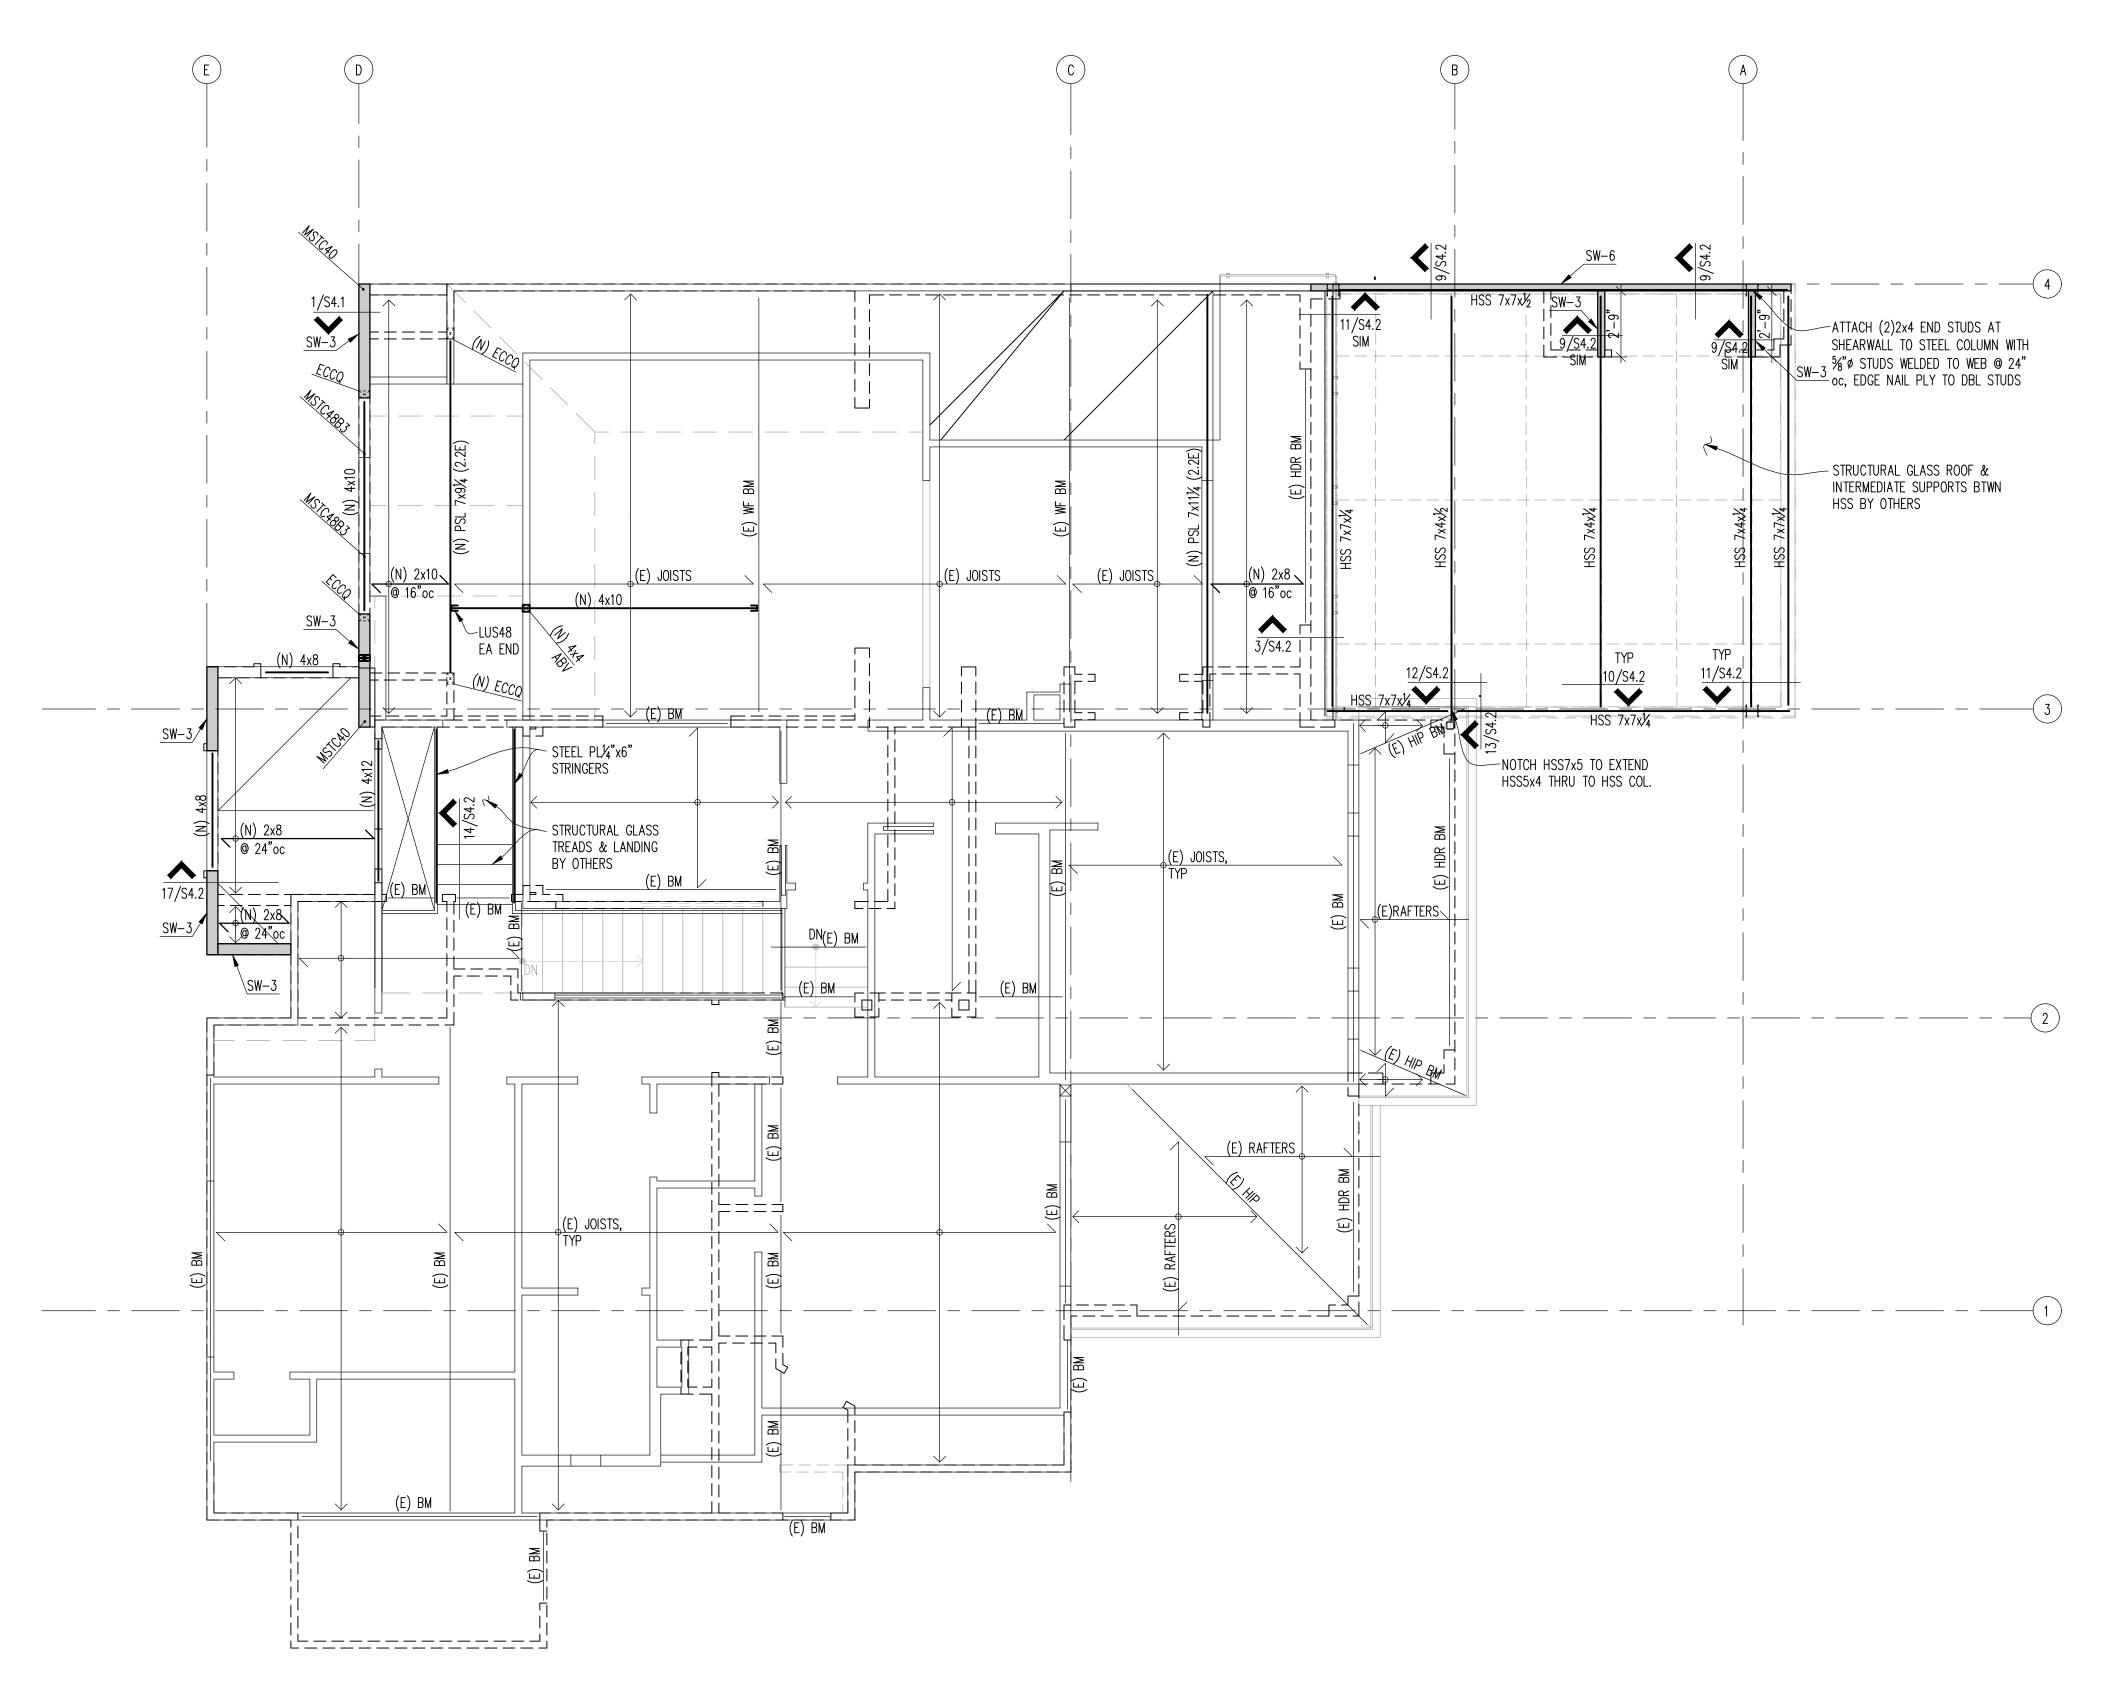
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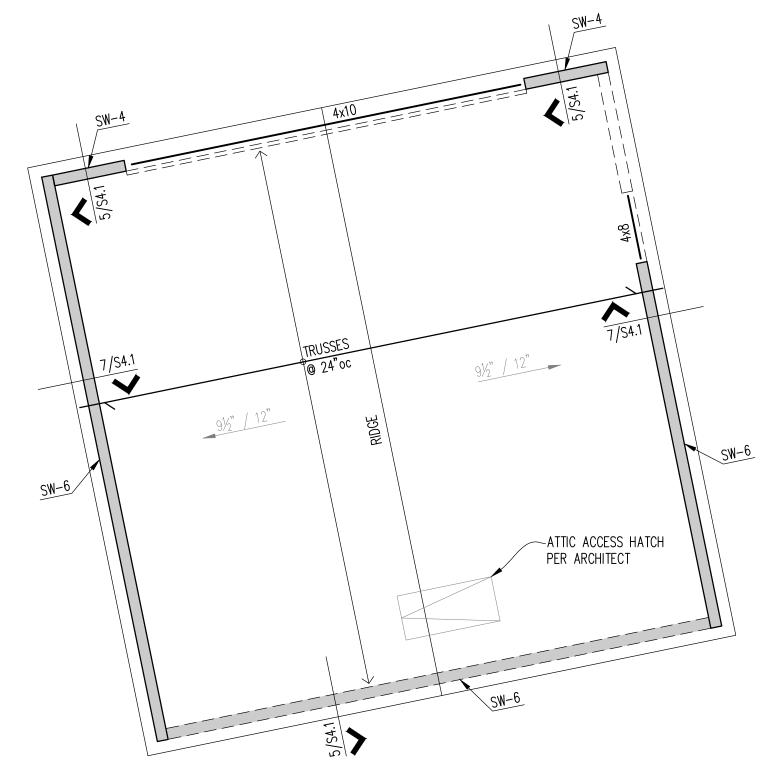
1ST FLOOR FRAMING PLAN

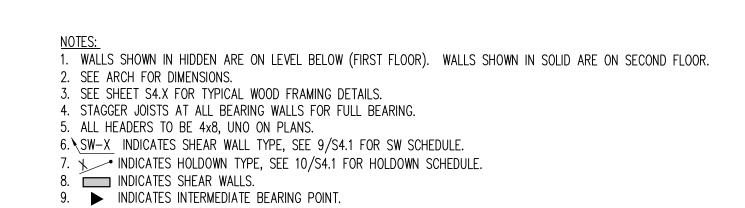
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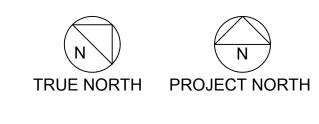
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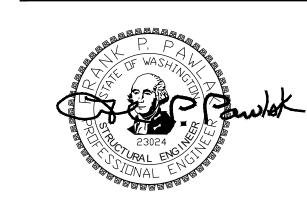












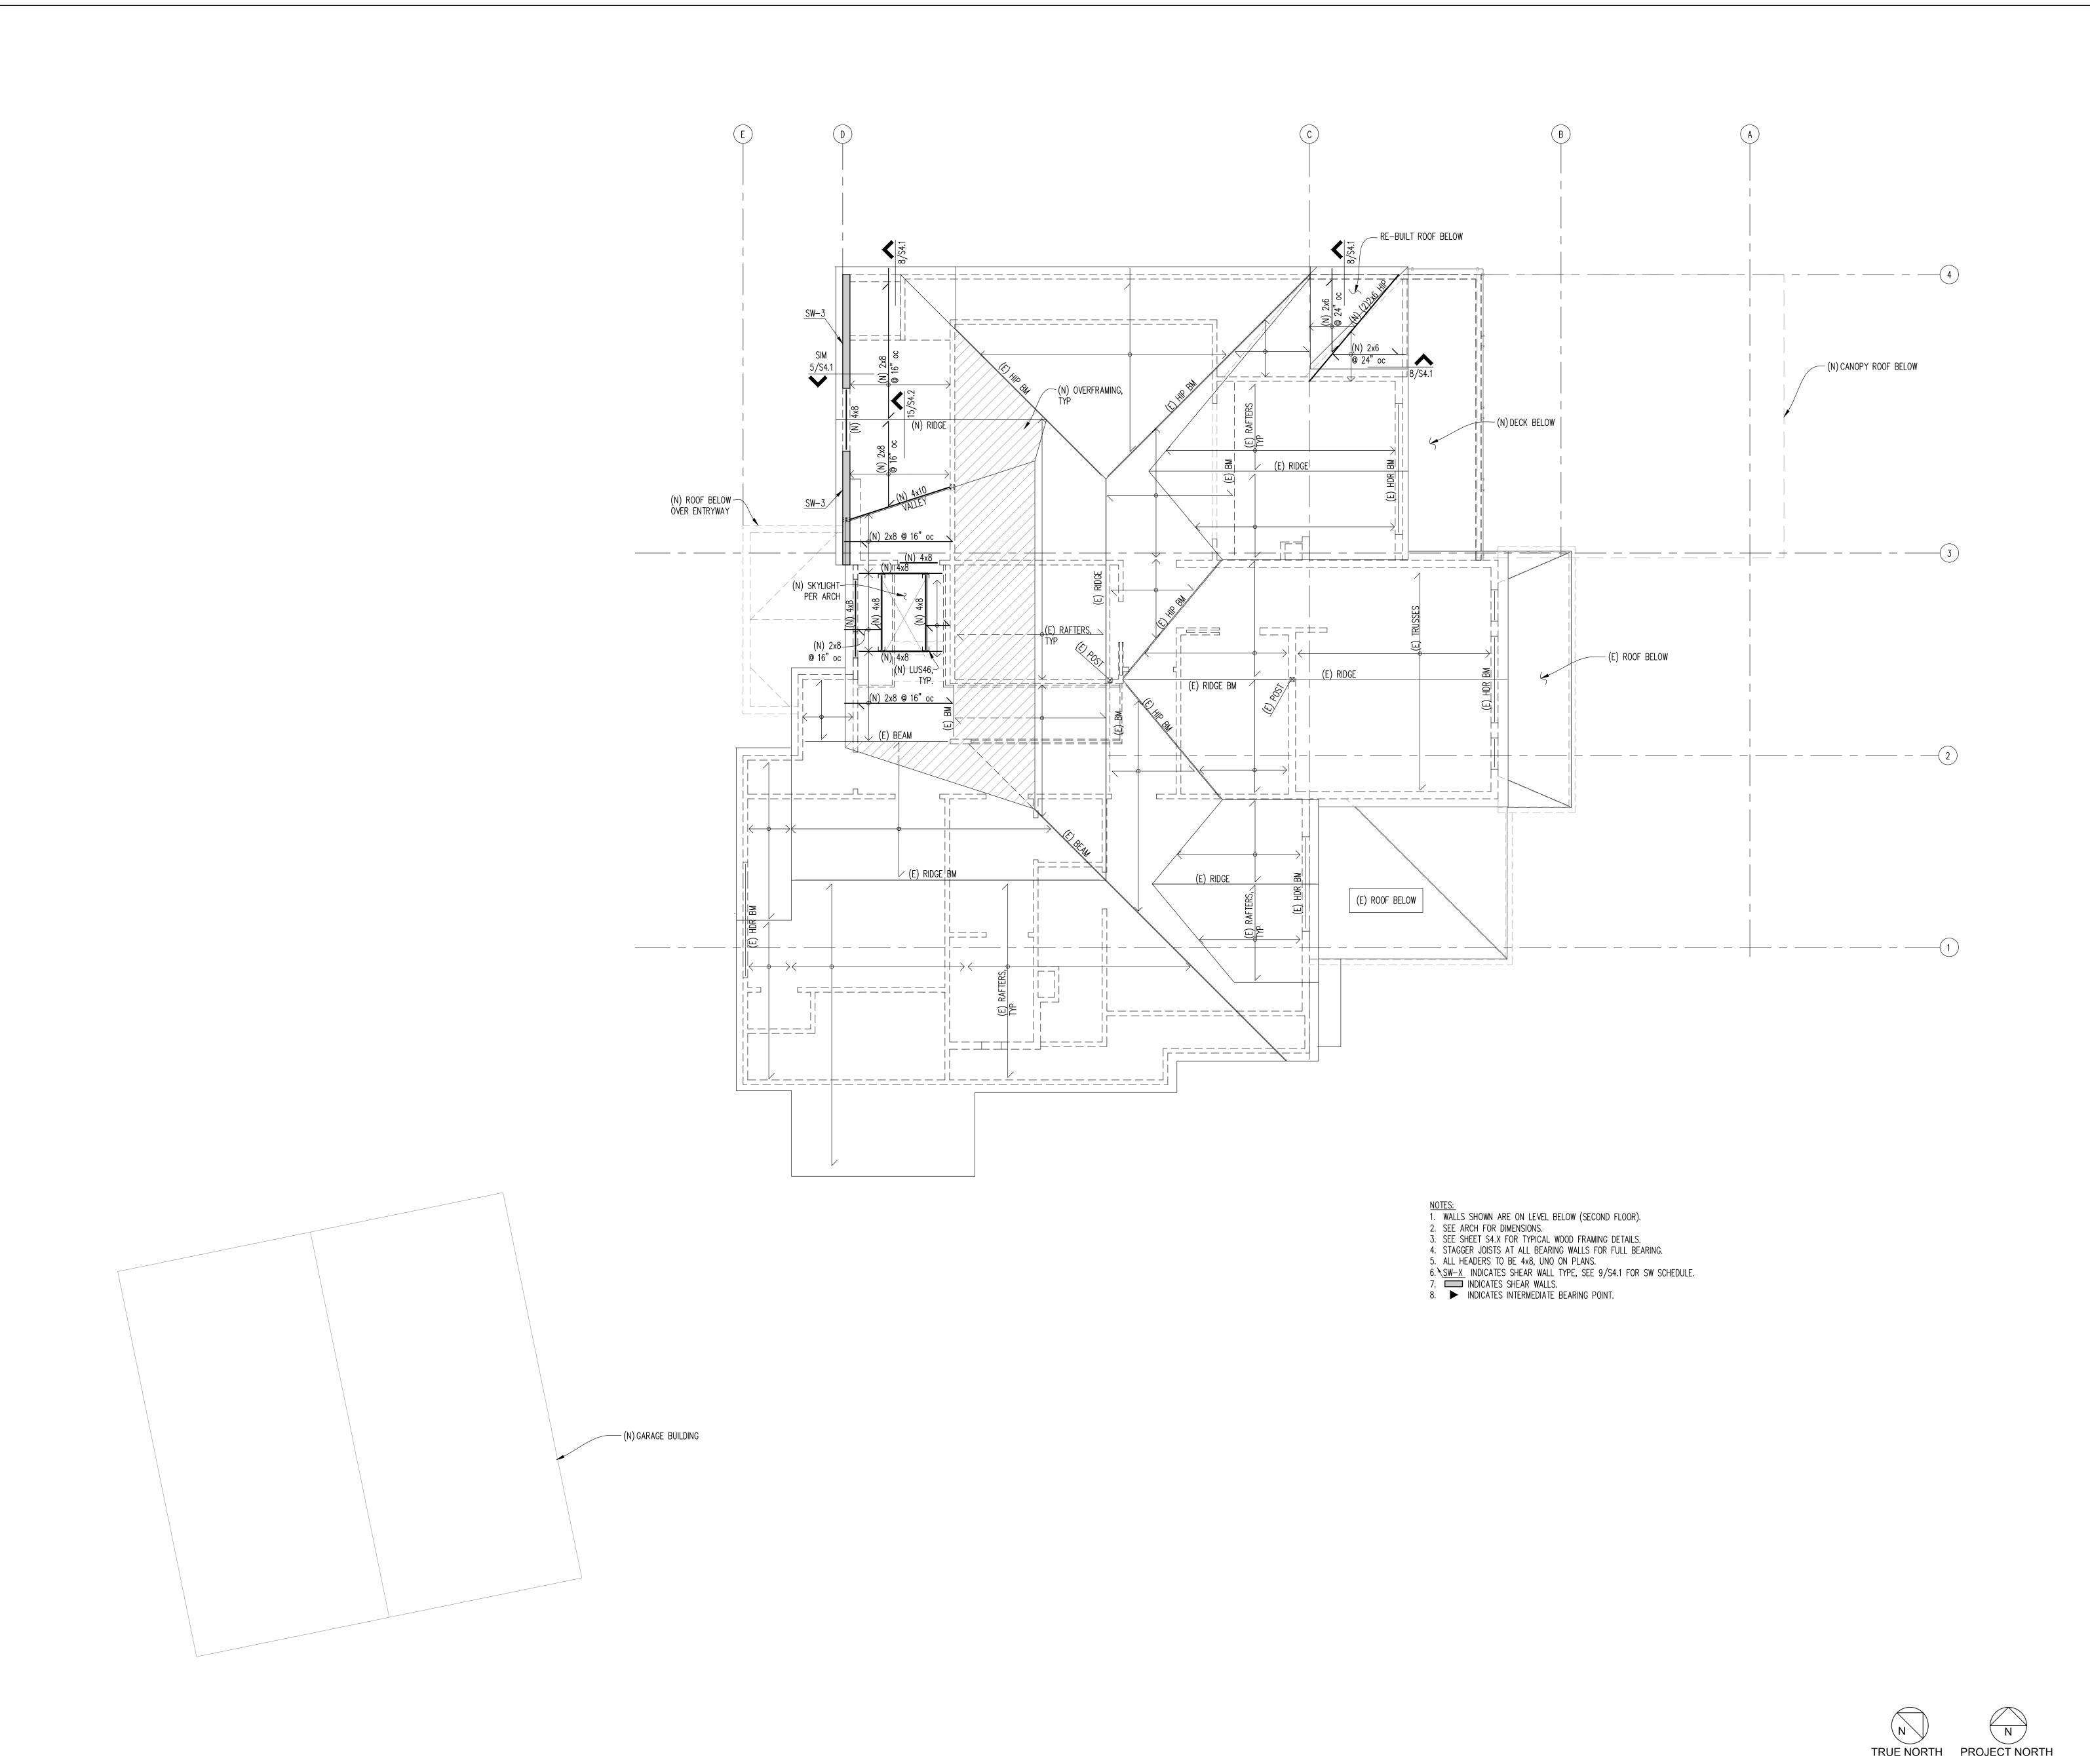
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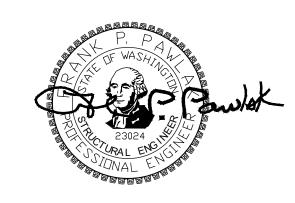
2ND FLOOR FRAMING PLAN

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S2.3







PROJECT

9820 SE 35TH PLACE ACHIN & MARY CHEN 9820 SE 35TH PL

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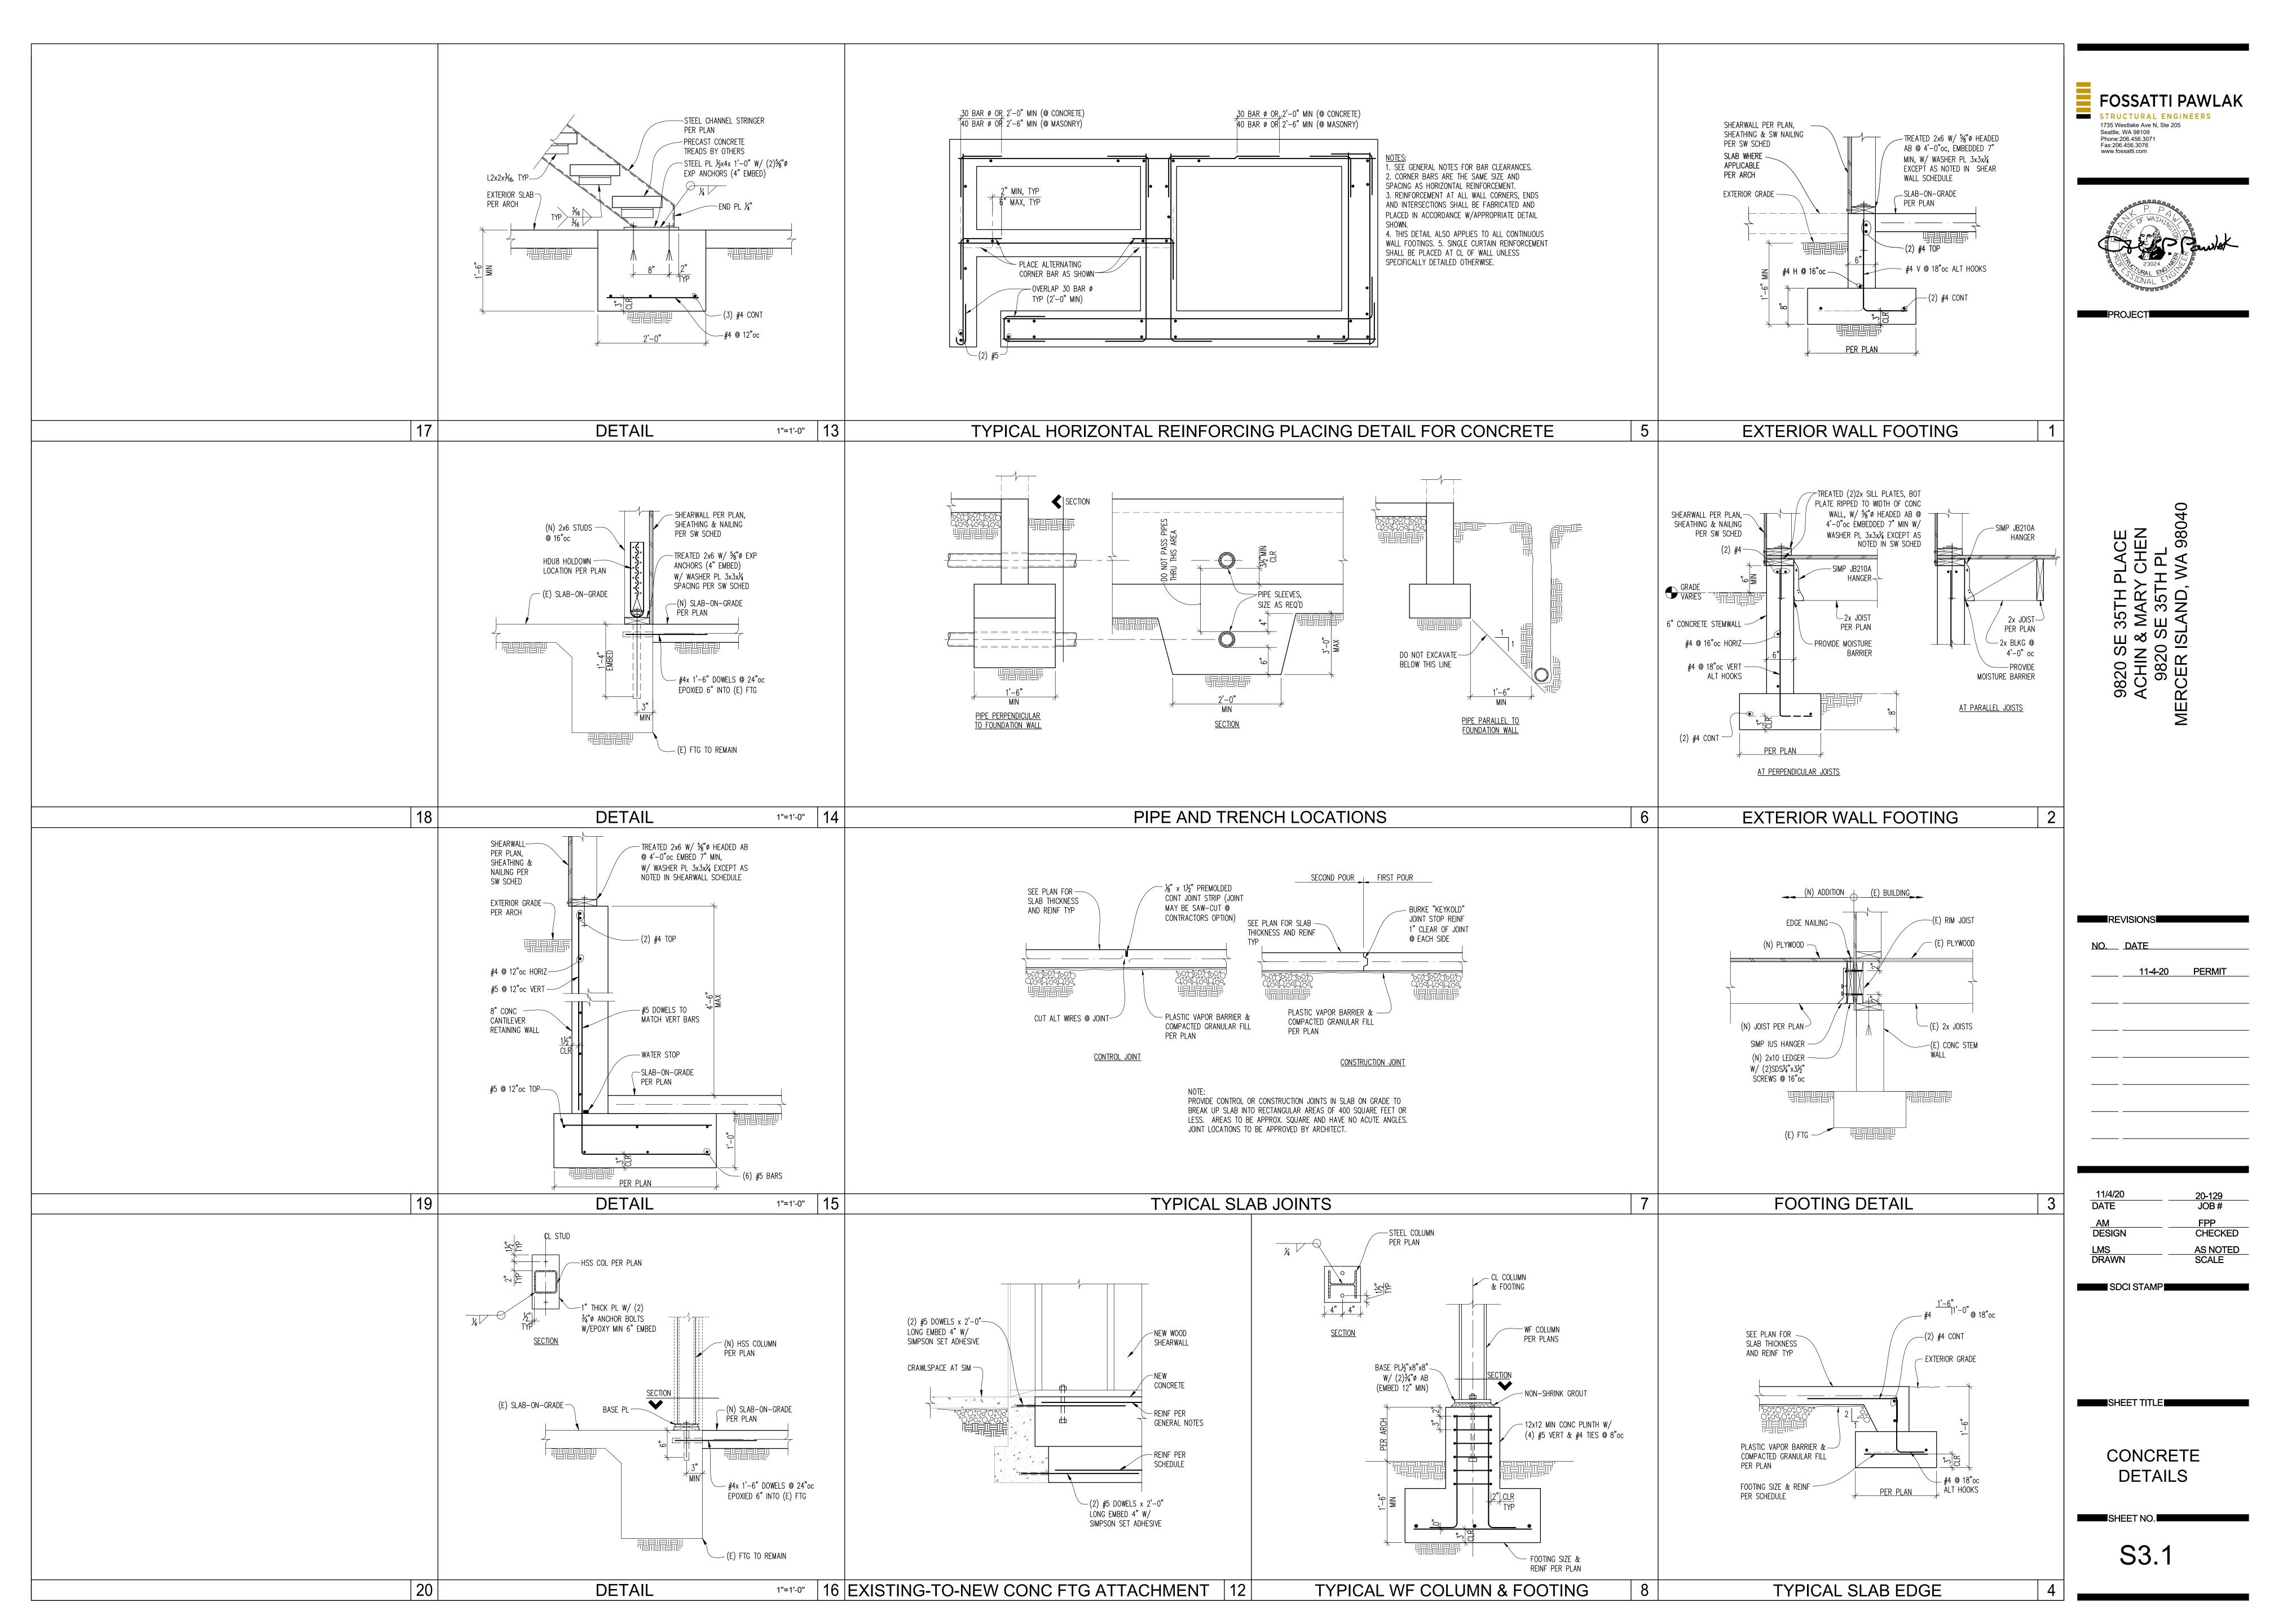
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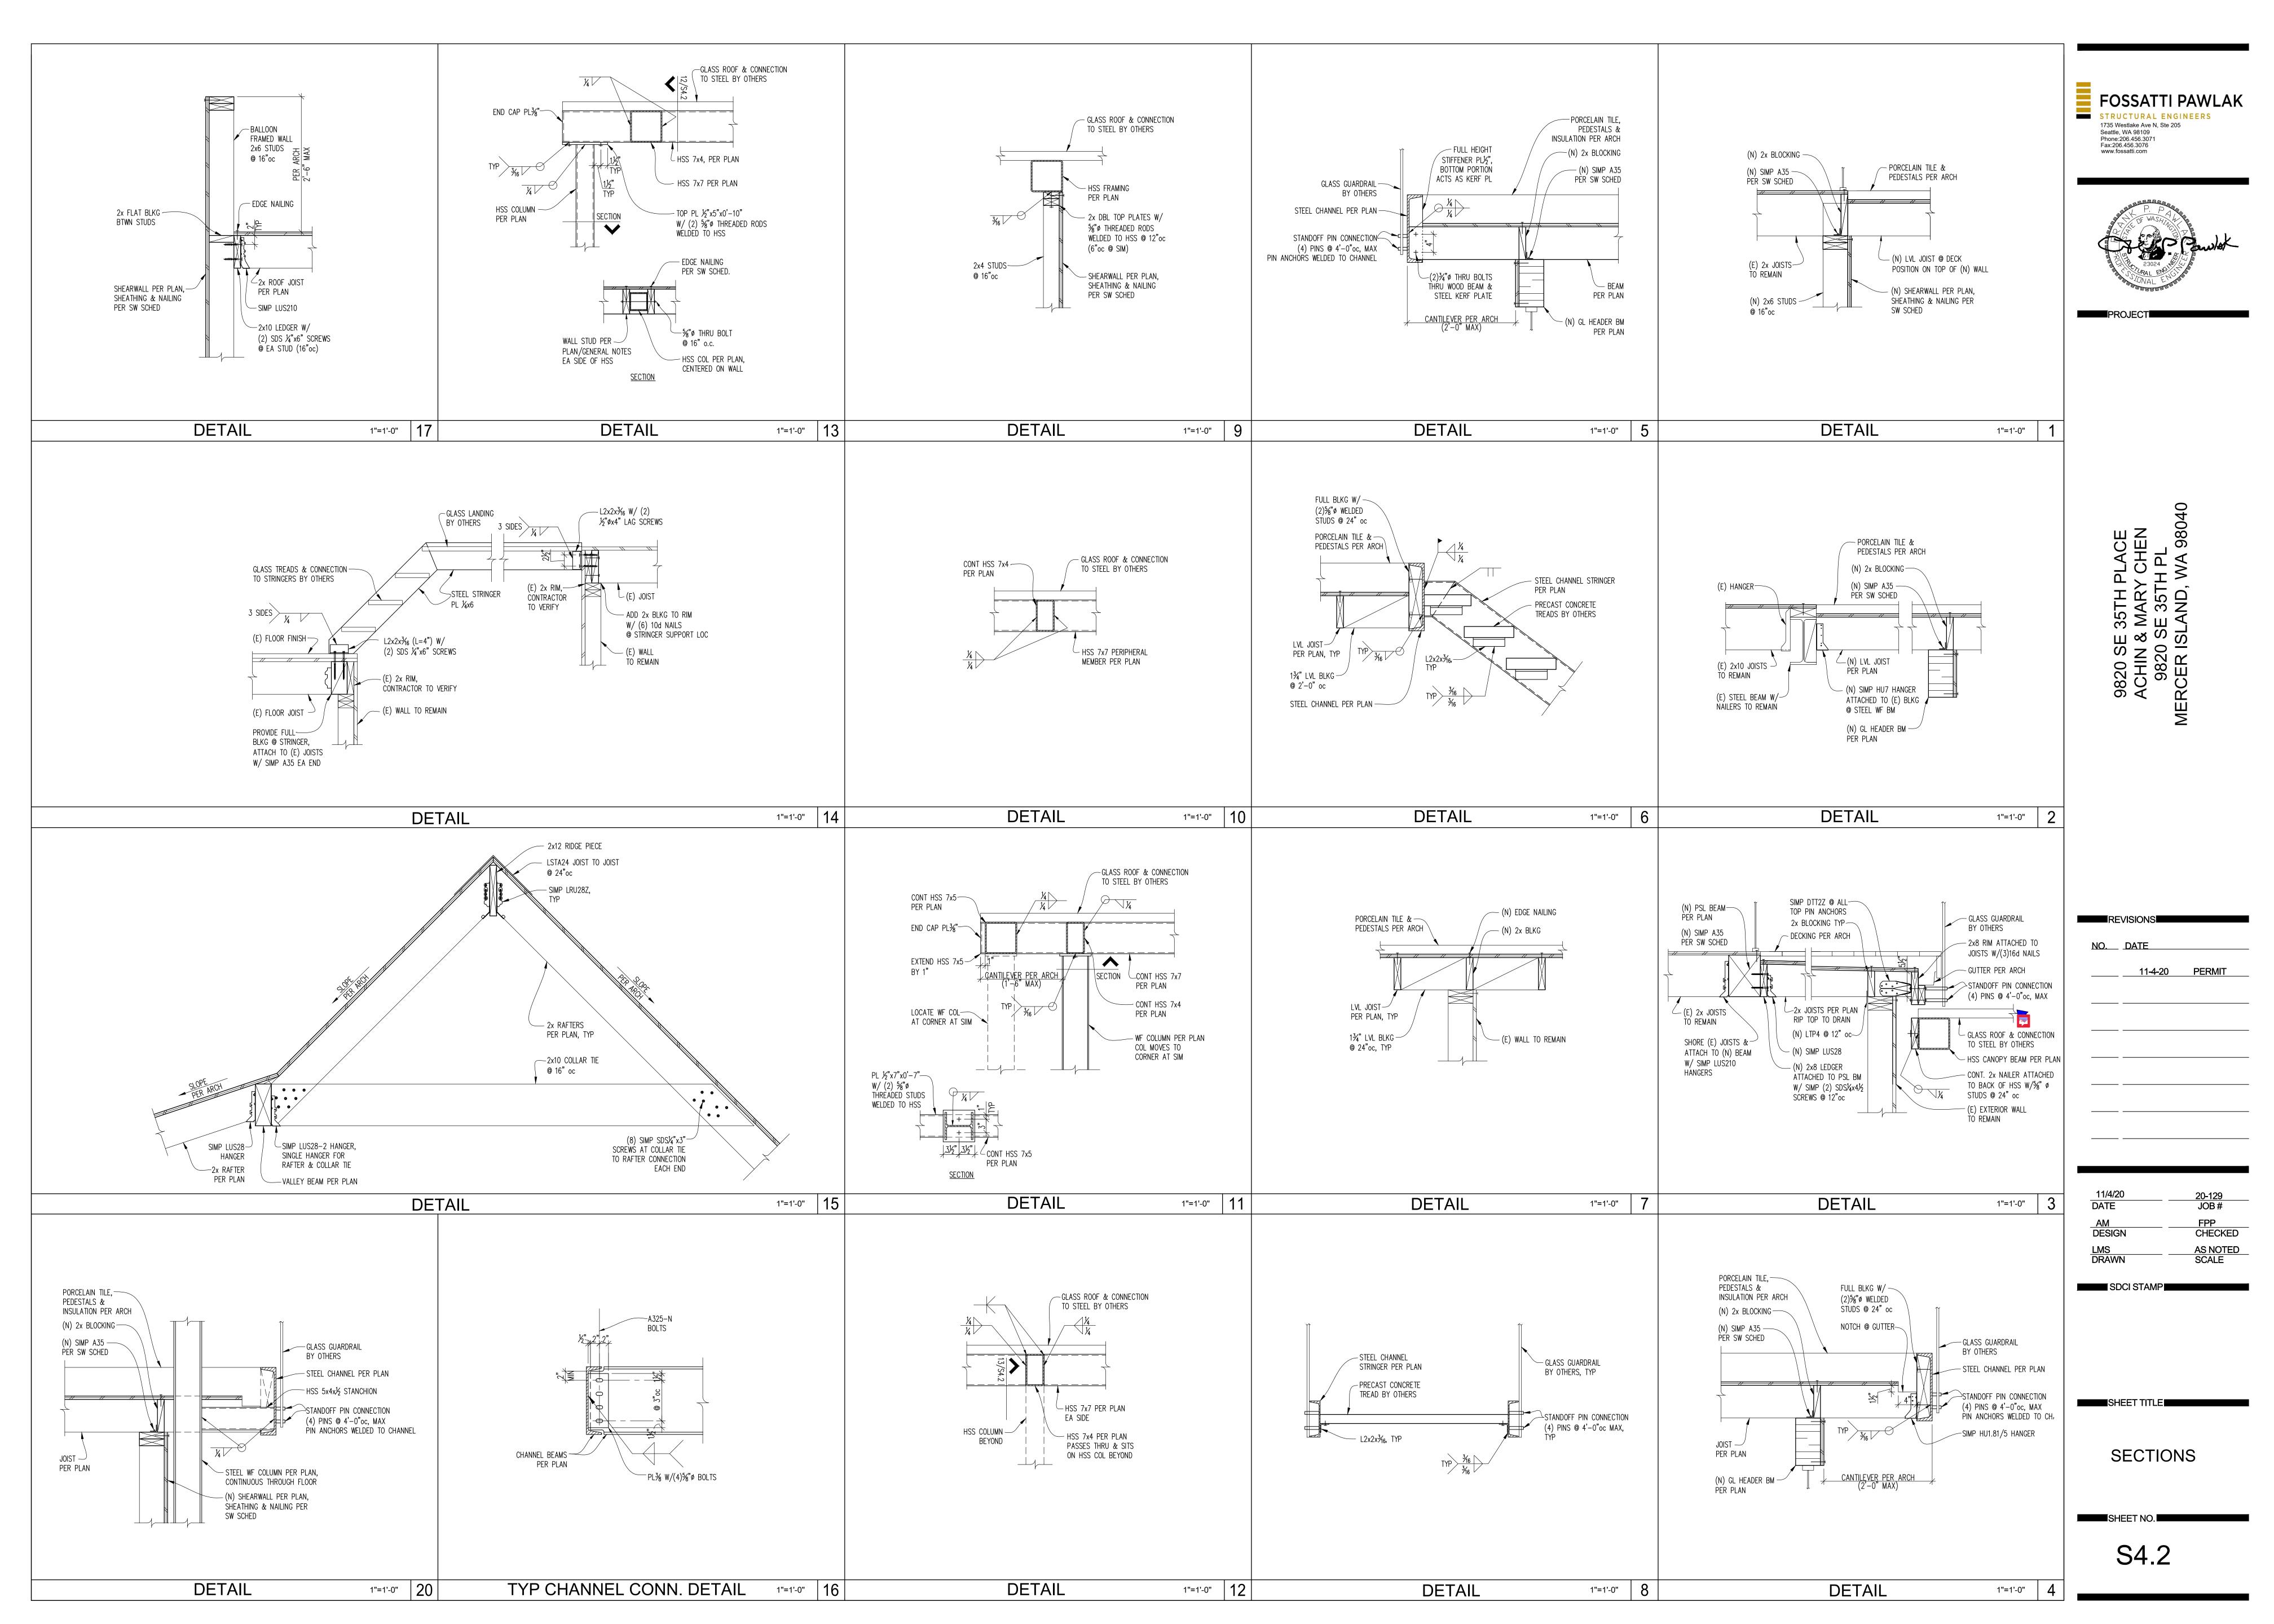
ROOF FRAMING PLAN

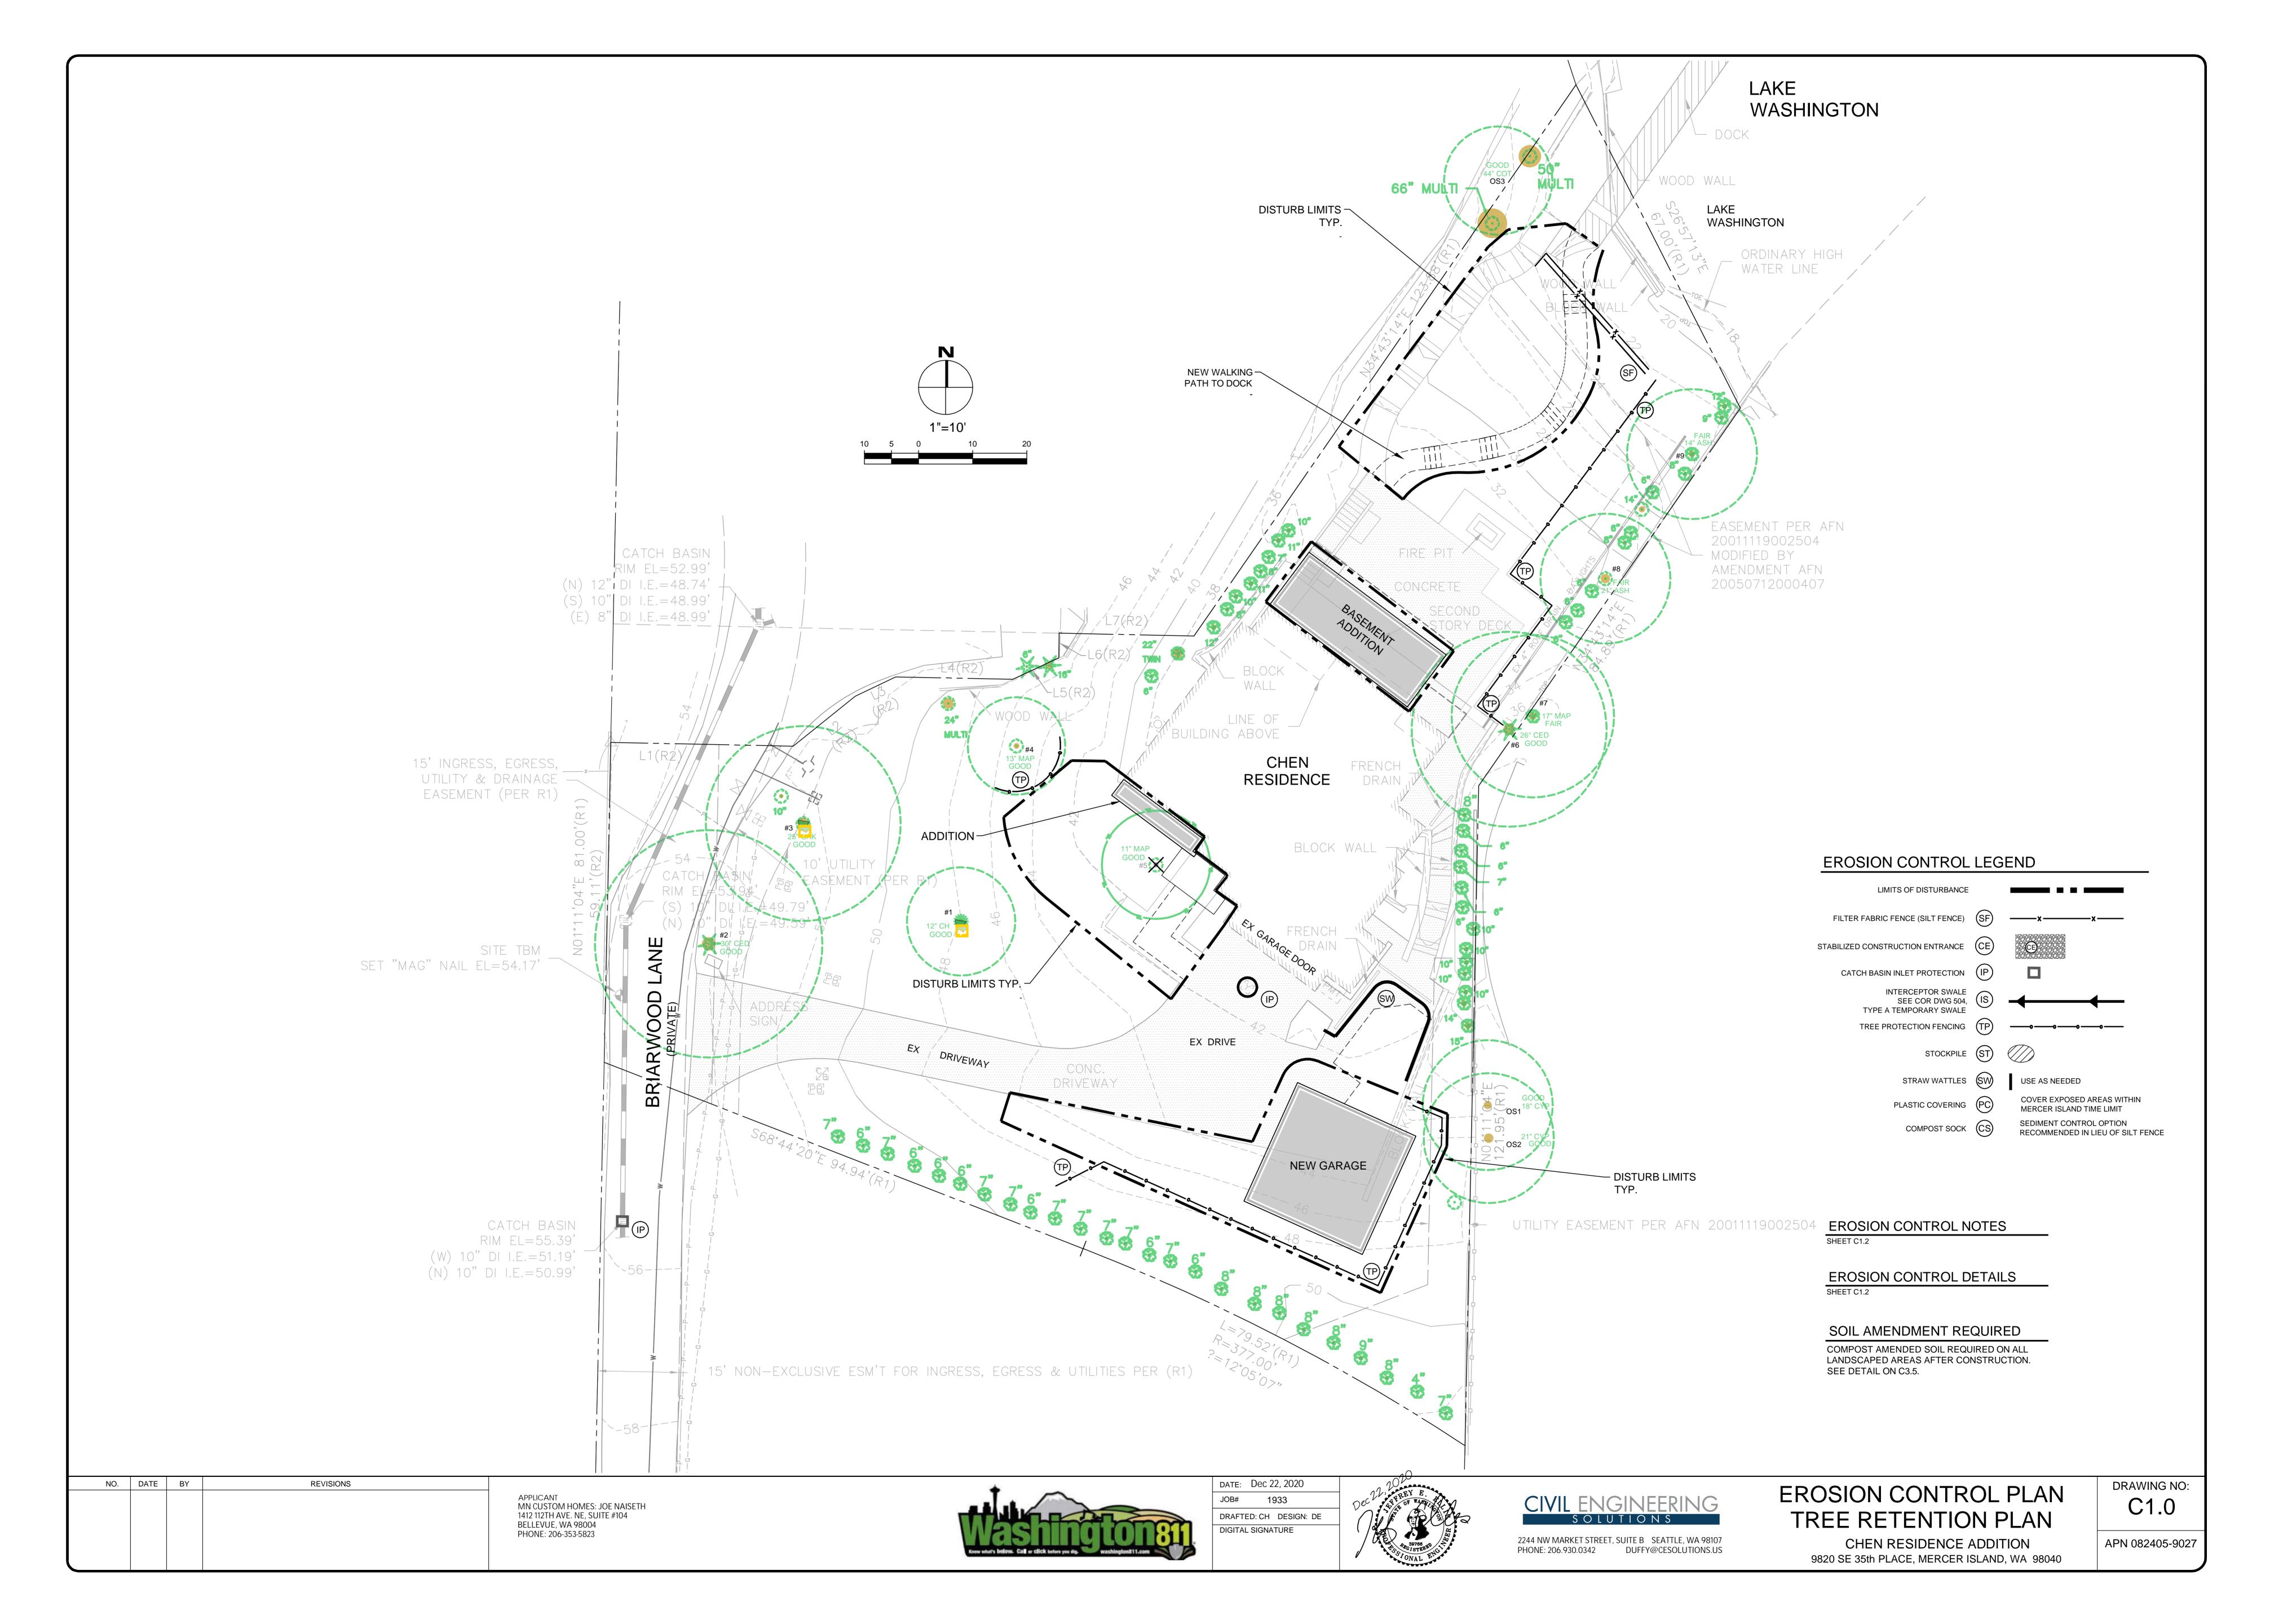
S2.4

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MANN APPLICATION PANEL EDGE NAIL WALL TOP PLATE (NOTE 6.13) CONCRETE	DEGE STUDS E & BLOCKING (NOTE 14) 2 x N/A N/A 242 3 x 5½"oc 10"oc 353 3 x 4"oc 8"oc 456 3 x (2) @ 6½"oc 5½"oc 706 3 x (2) @ 5½"oc 5½"oc 706 3 x (2) @ 5½"oc 5½"oc 706 3 x (2) @ 5½"oc 10"oc 353 3 x (2) @ 6½"oc 5½"oc 706 3 x (2) @ 6½"oc 5½"oc 706 3 x (2) @ 5½"oc 10"oc 706 3 x (2) @ 5½"oc 10"oc 100 595 3 x (2) @ 5½"oc 100 5½"oc 706 3 x (2) @ 5½"oc 100 5½"oc 100 5½"oc 706 3 x (2) @ 5½"oc 100 5½"oc 100 5½"oc 706 3 x (2) @ 5½"oc 100 5½"oc 100 5½"oc 706 3 x (2) @ 5½"oc 100 5½"oc 100 5½"oc 706 3 x (2) @ 5½"oc 100 5½"oc 100 5½"oc 706 3 x (2) @ 5½"oc 100 5½"oc 100 5½"oc 100 5½"oc 706 3 x (2) @ 5½"oc 100 5½"o	D WHERE SHEATHING IS DISCONTINUOUS, i.e., WHERE ADJACENT SHEATHING EDGES ARE ITTED. LATERAL TIE PLATES MAY BE SUBSTITUTED FOR WALL PLATE TO BLOCKING LS. USE COMMON NAILS OR EQUIVALENT NAILS SUPPLIED BY CONNECTOR MANUFACTURER FOR LATERAL TIE PLATES AT SPACING SHOWN IN TABLE. WOOD JOINTS SO THAT JOINTS ON EACH SIDE OF THE WALL DO NOT OCCUR AT THE SAME WALLS NOTED ON PLANS. ENDS OF WALLS ARE DESIGNATED BY EXTERIOR OF BUILDING, ID OF WALL, UNO. PROVIDE EDGE NAILING TO STUD(S) GRIPPED BY HOLDOWN. E AND 7" MINIMUM EMBEDMENT JT AND THE SILL PLATE. USE 4½"x4½"x½" PL WASHERS WHERE 2x6 STUD WALLS ARE N ½" OF THE EDGE OF THE BOTTOM PLATE ON THE SIDE(S) WITH SHEATHING. LAP WITH RIMBOARD/BLOCKING ABOVE, IT IS ACCEPTABLE TO NAIL SHEATHING TO ND ELIMINATE THE A35 CLIPS BETWEEN THE RIMBOARD/BLOCKING AND WALL TOP PLATE. ESISTANT.	2x BLOCKING SIMP A35 PER SW SCHEDULE SIMP H2.5A @ 4'-0"oc FASCIA PER ARCH OVERHANG PER ARCH 2x6 OUTRIGGERS @ 24"oc SHEARWALL PER PLAN, SHEATHING & NAILING PER SW SCHEDULE TRUSS PER PLAN, RAFTERS AT SIM.	PTB NAILS PER SW SCHED FOR SW ABOVE 2x RIM JOIST SIMP A35—PER SW SCHED PLYWOOD JOINT AT TOP OF JOIST OR MIDDLE OF DBL TOP PLATE, TYP 2x BLKG	FOSSATTI PAWLAK STRUCTURAL ENGINEERS 1735 Westlake Ave N, Ste 205 Seattle, WA 98109 Phone: 206. 456. 3071 Fax: 206. 456. 3076 www.fossatti.com
NOTCH PLYWOOD AS REQUID FOR STRAP SOLID BLOCKING SAME THICKNESS AS STUD OR POST PROMBE DOUBLE KING STUDS/POST AT STRAP & NAILING PER PLANS & HOLDOWN SCHED PROMBE DOUBLE KING STUDS/POST AT STRAP LOCATIONS, SEE SCHED SECTION SECTION SECTION SECTION	MSTC28 3" x 16 GA	PER OR MULTIPLE JOISTS, SAME THICKNESS AS SW CHORD ABOVE 1. A MIN OF 18" OR ROD NITERIOR FOOTING	TYPICAL OUTRIGGER CL SPLICE (NO SPLICE WHERE BEAM IS CONTINUOUS OVER COLUMN) BEAM PER PLANS BEAM PER PLANS BEAM PER PLANS POST PER PLANS BEAM END DETAIL	TYP WALL DETAIL EXTRA STUDS AS SHOWN, SEE PLAN FOR ADDITIONAL POSTS AND TYPICAL POSTS UNDER BM EDGE NAILING PER SW SCHED, TYP THRU WALL EXTRA STUDS AS SHOWN, SEE PLAN FOR ADDITIONAL POSTS & TYP POSTS WALL PLAN CROSS WALL PLAN CROSS WALL PLAN CROSS WALL PLAN CORNER PLAN	9820 SE 35TH PLACE ACHIN & MARY CHEN 9820 SE 35TH PL MERCER ISLAND, WA 98040
SHEAR WALL SEE PLANS & SW SCHED HOLDOWN AND BOLTS (OR SCREWS) PER SCHEDULE 16d NAILS PER SW SCHED PUX" X4½" X0'-4½" BEAM PER PLAN THREADED ROD AT BEAM CENTERLINE PER SCHEDULE	SIMPSON ST2215 TOP ® EACH END HEADER OR BEAM PER PLAN SOLID BLOCKING ® MID-HEIGHT, WHERE WALL HEIGHT EXCEEDS 8'-0" (2) 10d ® EA END (2) 10d ® EA END (2) 10d ® EA END	M FIR LUMBER) FLUSH HEADER OR BEAM PER PLAN SIMPSON ST2215 BUILT-UP COLUMN (2) STUDS MIN 2x4 OR 2x6 STUDS @ 16"oc 16d @ 12"oc, TYP @ BUILT-UP COLUMNS HOLDOWN CALLED OUT SPACING PER 1/2 SW AB SW SCHEDULE SPACING TO HD	SIMPSON A35 ANGLES AS REQ'D BY SW SCHED WOOD TRUSSES PER PLAN SIMP H2.5A @ EACH TRUSS OVERHANG PER ARCH SHEATHING & NAILING PER SW SCHEDULE	(8) 16d NAILS EA SIDE OF SPLICE (NO BOT SPLICE IN THIS AREA 4'-0" MIN 16d @ 12" oc STAGGER, TYP NOTE: USE @ ALL EXTERIOR WALLS AND INTERIOR WALLS IN LINE W/ SHEAR WALLS TOP PL SPLICE AT STUD CL, TYP BOTTOM PL SPLICE AT STUD CL, TYP 3rd PL WHERE REQ'D	NO. DATE 11-4-20 PERMIT
TYP EDGE NAILING, SEE NOTES 3/8" MIN TO EDGE OF PLYWOOD SHEET & SUPPORT FACE GRAIN TO BE PERPENDICULAR TO JOISTS STAGGER PLYWOOD JOINTS, SEE PLANS 2x4 FLAT BLKG @ UNSUPPORTED PLYWOOD EDGES (PERPENDICULAR TO TRUSSES) WHERE NOTED ON PLANS OR NOTES. IN OTHER AREAS, MIN BLOCKING SPACING: 8'-0"oc. MATCH JOIST SIZE. NOTE: ALL ENDS OF PLYWOOD SHEETS TO SPLICE OVER CL JOISTS OR SUPPORTING MEMBERS. PANELS LESS THAN 12" IN WIDTH SHALL BE BLOCKED AT ALL EDGES.	TYP EDGE NAILING, SEE NOTES 36" MIN TO EDGE OF PLYWOOD SHEET & SUPPORT FLOOR JOIST PER PLAN FACE GRAIN TO BE PERPENDICULAR TO JOISTS STAGGER PLYWOOD JOINTS, SEE PLANS BLKG @ UNSUPPORTED PLYWOOD ALL EDGES (PERPENDICULAR TO JOISTS) WHERE NOTED ON PLANS OR NOTES. IN OTHER AREAS, MIN BLOCKING SPACING. 8"-0"oc. MATCH JOIST SIZE. TYP FIELD NAILING PER NOTES	EDGE NAIL TO TOP PLATE (2)2x TOP PLATE, UNO BLKG AT PANEL EDGES & AT 8'-0". EDGE NAIL AS NOTED ON SCHEDULE. SHEATHING PER SCHEDULE FIELD NAIL STUDS @ 16"oc ANCHOR BOLTS W/ WASHER, SEE SCHEDULE SILL PLATE PER SCHED HOLDOWN PER PLANS FINISH FLOOR LINE NOTE: NAILING TO BE ¾" MIN TO EDGE OF SUPPORTS & SHEETS.	SIMPSON A35 ANGLES AS REQUIRED BY SHEAR WALL SCHEDULE EDGE NAILING 2x BLOCKING SIMP H2.5A @ EA RAFTER PER PLAN HEADER PER PLANS OVERHANG PER ARCH SHEARWALL PER PLAN, SHEATHING & NAILING PER SW SCHEDULE	TYP STUD WALL TOP PLATE SPLICE 2x4 STUDS 2x4 PL (2) 2x HEADER (2) 2x HEADER (3) 2x HEADER SPIKE EACH PIECE W/ (2) ROWS 16d SINKERS (a) 12" oc, STAGGERED, TYP (b) 12" oc, STAGGERED, TYP (c) 2x HEADER WITH FILLERS HEADER 2x SNUG TO PLYWOOD SIDE, TYP	11/4/20 DATE JOB # AM FPP DESIGN CHECKED LMS AS NOTED DRAWN SCALE SDCI STAMP SHEET TITLE SHEET NO.
TYPICAL ROOF SHEATHING 20	TYPICAL FLOOR SHEATHING 16	TYPICAL SHEAR WALL SHEATHING 12	TYPICAL DOWNWARD EAVE 8	TYPICAL BUILT-UP HEADER SECTIONS 4	S4.1





SILT FENCE DETAIL DOE Figure II-3.22: Silt Fence Joints in geotextile fabric shall be spliced at posts. Use staples, wire rings or equivalent to attach fabric to posts 2"x2" by 14 Ga. wire or equivalent, if standard strength fabric used to 8' if wire backing is used fence posts, or equivalent 2"x2" by 14 Ga. wire or equivalent, if standard strength fabric used Seotextile fabric Backfill trench with native soil or 3/4" -1.5" washed gravel 4"x4" trench 2"x2" wood posts, steel -NOT TO SCALE Silt Fence Revised July 2017 Please see http://www.ecy.wa.gov/copyright.html for copyright notice including permissions, State of Washington limitation of liability, and disclaimer

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CONSTRUCTION ENTRANCE

Figure II-3.1: Stabilized Construction Access NOT TO SCALE Install driveway culvert if there is a roadside ditch present 4" - 8" quarry — Driveway shall meet 12" minimum thickness the requirements of the permitting agency. . It is recommended that Provide full width the access be crowned of ingress/egress so that runoff drains off Stabilized Construction Access

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RECOMMENDED CONSTRUCTION SEQUENCE

A DETAILED CONSTRUCTION SEQUENCE IS NEEDED TO ENSURE THAT EROSION AND SEDIMENT CONTROL MEASURES ARE APPLIED AT THE APPROPRIATE TIMES. A RECOMMENDED CONSTRUCTION SEQUENCE IS PROVIDED BELOW:

1. HOLD AN ONSITE PRE-CONSTRUCTION MEETING.

2. POST SIGN WITH NAME AND PHONE NUMBER OF ESC SUPERVISOR (MAY BE CONSOLIDATED WITH THE REQUIRED NOTICE OF CONSTRUCTION SIGN).

3. FLAG OR FENCE CLEARING LIMITS.

4. INSTALL CATCH BASIN PROTECTION, IF REQUIRED.

5. GRADE AND INSTALL CONSTRUCTION ENTRANCE(S).

6. INSTALL PERIMETER PROTECTION (SILT FENCE, BRUSH BARRIER, ETC.)

7. CONSTRUCT SEDIMENT PONDS AND TRAPS.

8. GRADE AND STABILIZE CONSTRUCTION ROADS.

9. CONSTRUCT SURFACE WATER CONTROLS (INTERCEPTOR DIKES, PIPE SLOPE DRAINS, ETC.) SIMULTANEOUSLY WITH CLEARING AND GRADING FOR PROJECT DEVELOPMENT.

10. MAINTAIN EROSION CONTROL MEASURES IN ACCORDANCE WITH CITY OF MERCER ISLAND STANDARDS AND MANUFACTURER'S RECOMMENDATIONS.

11. RELOCATE SURFACE SURFACE WATER CONTROLS OR TESC MEASURES, OR INSTALL NEW MEASURES SO THAT AS SITE CONDITIONS CHANGE, THE TESC IS ALWAYS IN ACCORDANCE WITH CITY OF MERCER ISLAND TESC REQUIREMENTS.

12. COVER ALL AREAS THAT WILL BE UN-WORKED FOR MORE THAN SEVEN DAYS DURING THE DRY SEASON (MAY 1 TO SEPT 30) OR TWO DAYS DURING THE WET SEASON (OCT 1 TO APRIL 30) WITH STRAW, WOOD FIBER MULCH, COMPOST, PLASTIC SHEETING, OR EQUIVALENT.

13. STABILIZE ALL AREAS WITHIN SEVEN DAYS OF REACHING FINAL GRADE.

14. SEED, SOD, STABILIZE, OR COVER ANY AREAS TO REMAIN UNWORKED FOR MORE THAN 30 DAYS.

15. UPON COMPLETION OF THE PROJECT, STABILIZE ALL DISTURBED AREAS AND REMOVE BMPS IF APPROPRIATE

DENUDED AREAS REQUIREMENTS

ALL DENUDED AREAS MUST BE STABILIZED WITHIN 7 DAYS OF CONSTRUCTION. PLEASE READ ALL CITY TESC NOTES ON SHEET C1.2.

OCT 1 TO MARCH 31

ALL DENUDED AREAS MUST BE STABILIZED WITHIN 2 DAYS OF GRADING. IF AN EROSION PROBLEM ALREADY EXISTS ON THE SITE, OTHER COVER PROTECTION AND EROSION CONTROL WILL BE REQUIRED.

EROSION CONTROL NOTES

SUPERVISOR UNTIL ALL CONSTRUCTION IS APPROVED.

D.8.2 STANDARD ESC PLAN NOTES THE STANDARD ESC PLAN NOTES MUST BE INCLUDED ON ALL ESC PLANS. AT THE APPLICANT'S DISCRETION, NOTES THAT IN NO WAY APPLY TO THE PROJECT MAY BE OMITTED; HOWEVER, THE REMAINING NOTES MUST NOT BE RENUMBERED. FOR EXAMPLE, IF ESC NOTE #3 WERE OMITTED, THE REMAINING NOTES SHOULD BE NUMBERED 1, 2, 4, 5, 6, ETC.

1. APPROVAL OF THIS EROSION AND SEDIMENTATION CONTROL (ESC) PLAN DOES NOT CONSTITUTE AN APPROVAL OF PERMANENT ROAD OR DRAINAGE DESIGN (E.G., SIZE AND LOCATION OF ROADS, PIPES, RESTRICTORS, CHANNELS, RETENTION FACILITIES, UTILITIES, ETC.).

2. THE IMPLEMENTATION OF THESE ESC PLANS AND THE CONSTRUCTION, MAINTENANCE, REPLACEMENT, AND UPGRADING OF THESE ESC FACILITIES IS THE RESPONSIBILITY OF THE APPLICANT/ESC

3. THE BOUNDARIES OF THE CLEARING LIMITS SHOWN ON THIS PLAN SHALL BE CLEARLY FLAGGED BY SURVEY TAPE OR FENCING, IF REQUIRED, PRIOR TO CONSTRUCTION (SWDM APPENDIX D). DURING THE CONSTRUCTION PERIOD, NO DISTURBANCE BEYOND THE CLEARING LIMITS SHALL BE PERMITTED. THE CLEARING LIMITS SHALL BE MAINTAINED BY THE APPLICANT/ESC SUPERVISOR FOR THE DURATION OF CONSTRUCTION.

4. STABILIZED CONSTRUCTION ENTRANCES SHALL BE INSTALLED AT THE BEGINNING OF CONSTRUCTION AND MAINTAINED FOR THE DURATION OF THE PROJECT. ADDITIONAL MEASURES, SUCH AS CONSTRUCTED WHEEL WASH SYSTEMS OR WASH PADS, MAY BE REQUIRED TO ENSURE THAT ALL PAVED AREAS ARE KEPT CLEAN AND TRACK OUT TO ROAD RIGHT OF WAY DOES NOT OCCUR FOR THE DURATION OF THE PROJECT.

5. THE ESC FACILITIES SHOWN ON THIS PLAN MUST BE CONSTRUCTED PRIOR TO OR IN CONJUNCTION WITH ALL CLEARING AND GRADING SO AS TO ENSURE THAT THE TRANSPORT OF SEDIMENT TO SURFACE WATERS, DRAINAGE SYSTEMS, AND ADJACENT PROPERTIES IS MINIMIZED.

6. THE ESC FACILITIES SHOWN ON THIS PLAN ARE THE MINIMUM REQUIREMENTS FOR ANTICIPATED SITE CONDITIONS. DURING THE CONSTRUCTION PERIOD, THESE ESC FACILITIES SHALL BE UPGRADED AS NEEDED FOR UNEXPECTED STORM EVENTS AND MODIFIED TO ACCOUNT FOR CHANGING SITE CONDITIONS (E.G. ADDITIONAL COVER MEASURES, ADDITIONAL SUMP PUMPS, RELOCATION OF DITCHES AND SILT FENCES, PERIMETER PROTECTION ETC.) AS DIRECTED BY CITY OF MERCER ISLAND.

7. THE ESC FACILITIES SHALL BE INSPECTED DAILY BY THE APPLICANT/ESC SUPERVISOR AND MAINTAINED TO ENSURE CONTINUED PROPER FUNCTIONING. WRITTEN RECORDS SHALL BE KEPT OF WEEKLY REVIEWS OF THE ESC FACILITIES.

8. ANY AREAS OF EXPOSED SOILS, INCLUDING ROADWAY EMBANKMENTS, THAT WILL NOT BE DISTURBED FOR TWO CONSECUTIVE DAYS DURING THE WET SEASON OR SEVEN DAYS DURING THE DRY SEASON SHALL BE IMMEDIATELY STABILIZED WITH THE APPROVED ESC METHODS (E.G., SEEDING, MULCHING, PLASTIC COVERING, ETC.).

9. ANY AREA NEEDING ESC MEASURES THAT DO NOT REQUIRE IMMEDIATE ATTENTION SHALL BE ADDRESSED WITHIN SEVEN (7) DAYS.

10. THE ESC FACILITIES ON INACTIVE SITES SHALL BE INSPECTED AND MAINTAINED A MINIMUM OF ONCE A MONTH DURING THE DRY SEASON, BI-MONTHLY DURING THE WET SEASON, OR WITHIN TWENTY FOUR (24) HOURS FOLLOWING A STORM EVENT.

11. AT NO TIME SHALL MORE THAN ONE (1) FOOT OF SEDIMENT BE ALLOWED TO ACCUMULATE WITHIN A CATCH BASIN. ALL CATCH BASINS AND CONVEYANCE LINES SHALL BE CLEANED PRIOR TO PAVING. THE CLEANING OPERATION SHALL NOT FLUSH SEDIMENT-LADEN WATER INTO THE DOWNSTREAM SYSTEM.

12. ANY PERMANENT RETENTION/DETENTION FACILITY USED AS A TEMPORARY SETTLING BASIN SHALL BE MODIFIED WITH THE NECESSARY EROSION CONTROL MEASURES AND SHALL PROVIDE ADEQUATE STORAGE CAPACITY. IF THE FACILITY IS TO FUNCTION ULTIMATELY AS AN INFILTRATION SYSTEM, THE TEMPORARY FACILITY MUST BE ROUGH GRADED SO THAT THE BOTTOM AND SIDES ARE AT LEAST THREE FEET ABOVE THE FINAL GRADE OF THE PERMANENT FACILITY.

13. COVER MEASURES WILL BE APPLIED IN CONFORMANCE WITH APPENDIX D OF THE SURFACE WATER DESIGN MANUAL

14. PRIOR TO THE BEGINNING OF THE WET SEASON (OCT. 1). ALL DISTURBED AREAS SHALL BE REVIEWED TO IDENTIFY WHICH ONES CAN BE SEEDED IN PREPARATION FOR THE WINTER RAINS. DISTURBED AREAS SHALL BE SEEDED WITHIN ONE WEEK OF THE BEGINNING OF THE WET SEASON.

CITY NOTES

ANY CHANGES TO THE APPROVED PLANS REQUIRES CITY APPROVAL THROUGH

APPLICANT IS RESPONSIBLE FOR ANY DAMAGES TO UNDERGROUND UTILITIES CAUSED FROM THIS CONSTRUCTION.

CATCH BASIN FILTERS SHOULD BE PROVIDED FOR ALL STORM DRAIN CATCH BASINS/INLETS DOWNSLOPE AND WITHIN 500 FEET OF THE CONSTRUCTION AREA. CATCH BASIN FILTERS SHOULD BE DESIGNED BY THE MANUFACTURER FOR USE AT CONSTRUCTION SITES AND APPROVED BY THE CITY INSPECTOR. CATCH BASIN FILTERS SHOULD BE INSPECTED FREQUENTLY, ESPECIALLY AFTER STORM EVENTS. IF THE FILTER BECOMES CLOGGED, IT SHOULD BE CLEANED OR

4. CONTRACTORS SHALL VERIFY LOCATIONS AND DEPTHS OF UTILITES.

5. AT LEAST 48 HOURS PRIOR TO CONSTRUCTION, CALL "ONE CALL" AT 1.800.424.5555

6. DO NOT BACKFILL WITH NATIVE MATERIAL ON PUBLIC RIGHT-OF-WAY. ALL MATERIAL MUST BE IMPORTED

EROSION CONTROL: ALL "LAND DISTURBING ACTIVITY" IS SUBJECT TO PROVISIONS OF MERCER ISLAND ORDINANCE 95C-118 "STORM WATER MANAGEMENT." SPECIFIC ITEMS TO BE FOLLOWED AT YOUR SITE:

PROTECT ADJACENT PROPERTIES FROM ANY INCREASED RUNOFF OR SEDIMENTATION DUE TO THE CONSTRUCTION PROJECT THROUGH THE USE OF APPROPRIATE "BEST MANAGEMENT PRACTICES" (BMP) EXAMPLES INCLUDE, BUT ARE NOT LIMITED TO, SEDIMENT TRAPS, SEDIMENT PONDS, FILTER FABRIC FENCES. VEGETATIVE BUFFER STRIPS OR BIOENGINEERED SWALES.

CONSTRUCTION ACCESS TO THE SITE SHOULD BE LIMITED TO ONE ROUTE. STABILIZE ENTRANCE WITH QUARRY SPALLS TO PREVENT SEDIMENT FROM LEAVING THE SITE OR ENTERING THE STORM DRAINS.

10. PREVENT SEDIMENT, CONSTRUCTION DEBRIS, PAINTS, SOLVENTS, ETC., OR OTHER TYPES OF POLLUTION FROM ENTERING PUBLIC STORM DRAINS. KEEP ALL POLLUTION ON YOUR SITE.

11. ALL EXPOSED SOILS SHALL REMAIN DENUDED FOR NO LONGER THAN SEVEN (7) DAYS AND SHALL BE STABILIZED WITH MULCH, HAY, OR THE APPROPRIATE GROUND COVER. ALL EXPOSED SOILS SHALL BE COVERED IMMEDIATELY DURING ANY RAIN EVENT.

12. INSTALLATION OF CONCRETE DRIVEWAYS, TREES, SHRUBS, IRRIGATION, BOULDERS, BERMS, WALLS, GATES, AND OTHER IMPROVEMENTS ARE NOT ALLOWED IN THE PUBLIC RIGHT-OF-WAY WITHOUT PRIOR APPROVAL, AND AN ENCROACHMENT AGREEMENT AND RIGHT OF WAY PERMIT FROM THE SENIOR DEVELOPMENT ENGINEER.

13. OWNER SHALL CONTROL DISCHARGE OF SURFACE DRAINAGE RUNOFF FROM EXISTING AND NEW IMPERVIOUS AREAS IN A RESPONSIBLE MANNER. CONSTRUCTION OF NEW GUTTERS AND DOWNSPOUTS, DRY WELLS, LEVEL SPREADERS OR DOWNSTREAM CONVEYANCE PIPE MAY BE NECESSARY TO MINIMIZE DRAINAGE IMPACT TO YOUR NEIGHBORS. CONSTRUCTION OF MINIMUM DRAINAGE IMPROVEMENTS SHOWN OR CALLED OUT ON THIS PLAN DOES NOT IMPLY RELIEF FROM CIVIL LIABILITY FOR YOUR DOWNSTREAM DRAINAGE.

14. POT HOLING THE PUBLIC UTILITIES IS REQUIRED PRIOR TO ANY GRADING ACTIVITIES LESS THAN 6" OVER THE PUBLIC MAINS (WATER, SEWER AND STORM SYSTEMS). IF THERE IS A CONFLICT, THE APPLICANT IS REQUIRED TO SUBMIT A REVISION FOR APPROVAL PRIOR TO ANY GRADING ACTIVITIES OVER THE PUBLIC

15. REMEMBER: EROSION CONTROL IS YOUR FIRST INSPECTION.

16. ROOF DRAINS MUST BE CONNECTED TO THE STORM DRAIN SYSTEM AND INSPECTED BY THE PUBLIC WORKS DEPARTMENT PRIOR TO ANY BACKFILLING OF PIPE.

17. SILENT FENCE: CLEAN AND PROVIDE REGULAR MAINTENANCE OF THE SILT FENCE. THE FENCE IS TO REMAIN VERTICAL AND IS TO FUNCTION PROPERLY THROUGHOUT THE TERM OF THE PROJECT.

18. WORK IN PUBLIC RIGHT OF WAY REQUIRES A RIGHT-OF-WAY USE PERMIT.

19. REFER TO WATER SERVICE PERMIT FOR ACTUAL LOCATION OF NEW WATER METER AND SERVICE LINE DETERMINED BY MERCER ISLAND WATER DEPARTMENT.

16. THE TV INSPECTION OF THE EXISTING SIDE SEWER TO THE CITY SEWER MAIN IS REQUIRED. IF THE RESULT OF THE TV INSPECTION IS NOT IN SATISFACTORY CONDITION, AS DETERMINED BY THE CITY OF MERCER ISLAND INSPECTOR, THE REPLACEMENT OF THE EXISTING SIDE SEWER IS REQUIRED. ALTERNATELY, A PRESSURE TEST OF THE SIDE SEWER, FROM SEWER MAIN TO POINT OF CONNECTION, MAY BE SUBSTITUTED FOR THE VIDEO INSPECTION.

20. NEWLY INSTALLED SIDE SEWER REQUIRES A 4 P.S.I. AIR TEST OR PROVIDE 10' OF HYDROSTATIC HEAD TEST.

21. POT HOLING THE PUBLIC UTILITIES IS REQUIRED PRIOR TO ANY GRADING ACTIVITIES LESS THAN 6" OVER THE PUBLIC MAINS (WATER, SEWER AND STORM SYSTEMS). IF THERE IS A CONFLICT, THE APPLICANT IS REQUIRED TO SUBMIT A REVISION FOR APPROVAL PRIOR TO ANY GRADING ACTIVITIES OVER THE PUBLIC

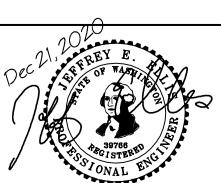
22. THE LIMITS AND EXTENDS OF THE PAVEMENT IN THE PUBLIC RIGHT OF WAY SHALL BE DETERMINED BY THE CITY ENGINEER PRIOR TO FINALIZE THE

NO. DATE BY **REVISIONS**

APPLICANT MN CUSTOM HOMES: JOE NAISETH 1412 112TH AVE. NE, SUITE #104 BELLEVUE, WA 98004 PHONE: 206-353-5823

State of Washington limitation of liability, and disclaimer.

DATE: Dec 21, 2020 DRAFTED: SS DESIGN: DE DIGITAL SIGNATURE



2244 NW MARKET STREET, SUITE B SEATTLE, WA 98107

PHONE: 206.930.0342 DUFFY@CESOLUTIONS.US

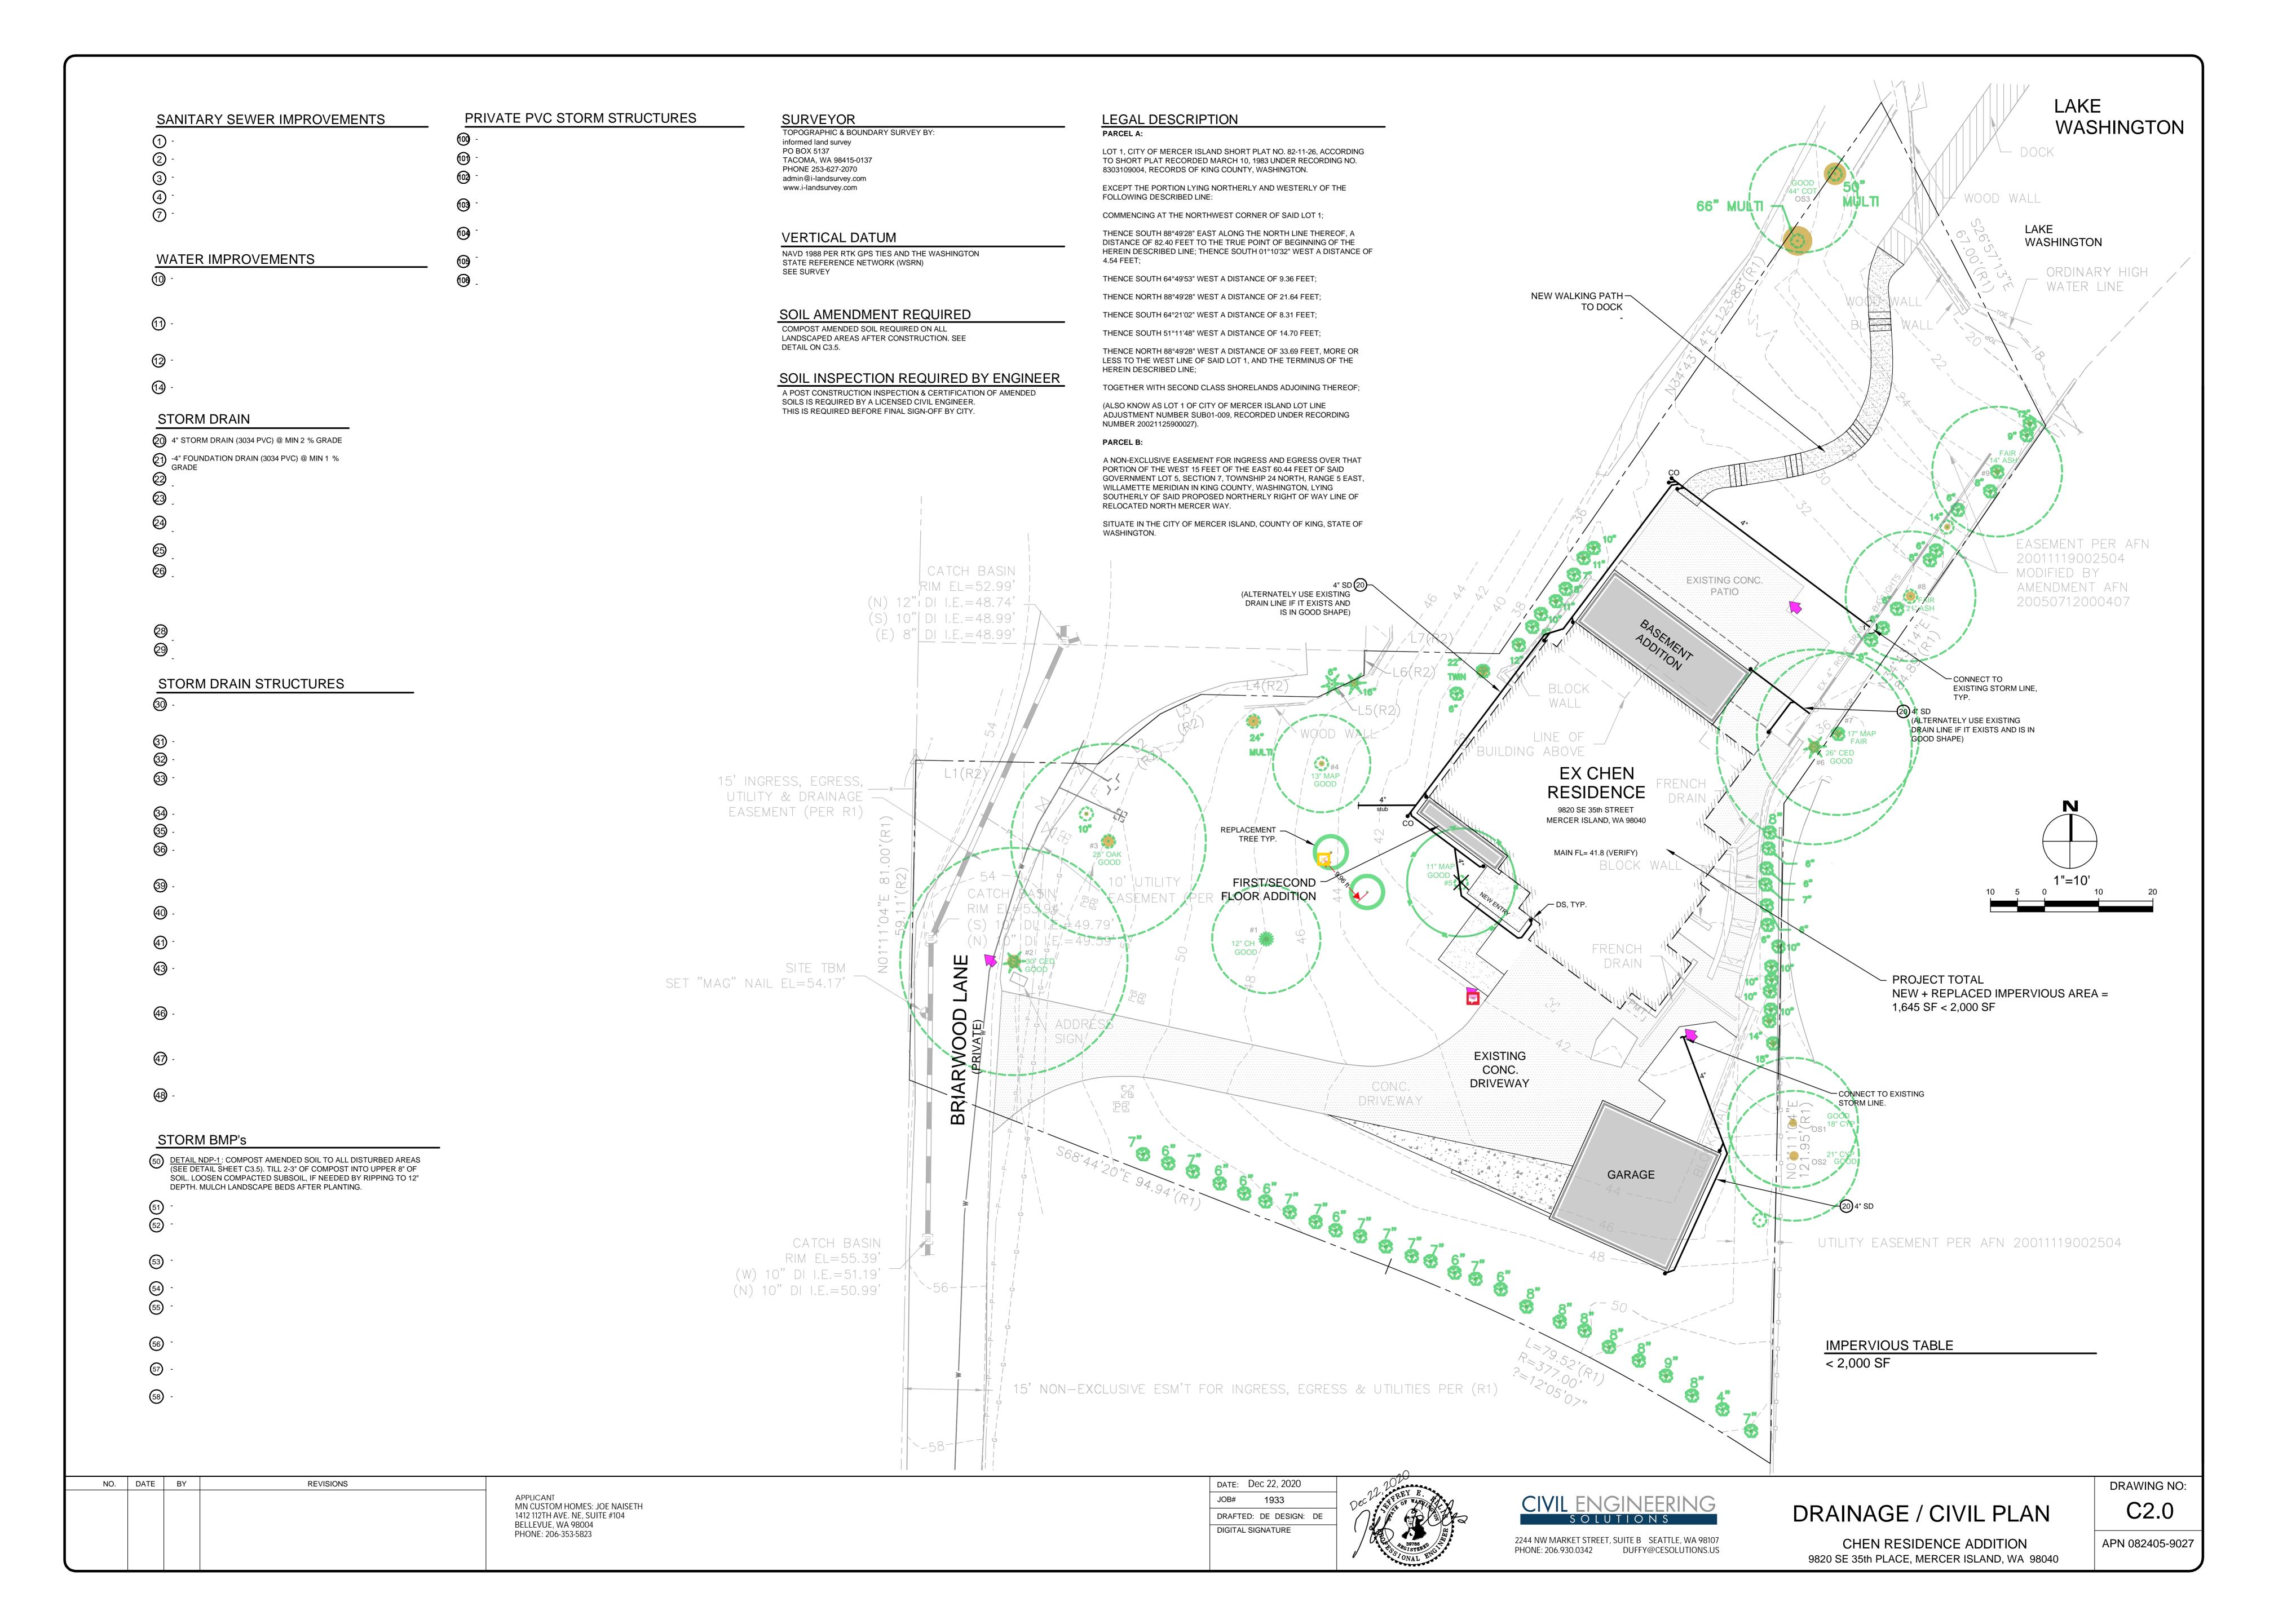
TESC & CITY NOTES TESC DETAILS

C1.2

DRAWING NO:

APN 082405-9027

CHEN RESIDENCE ADDITION 9820 SE 35th PLACE, MERCER ISLAND, WA 98040



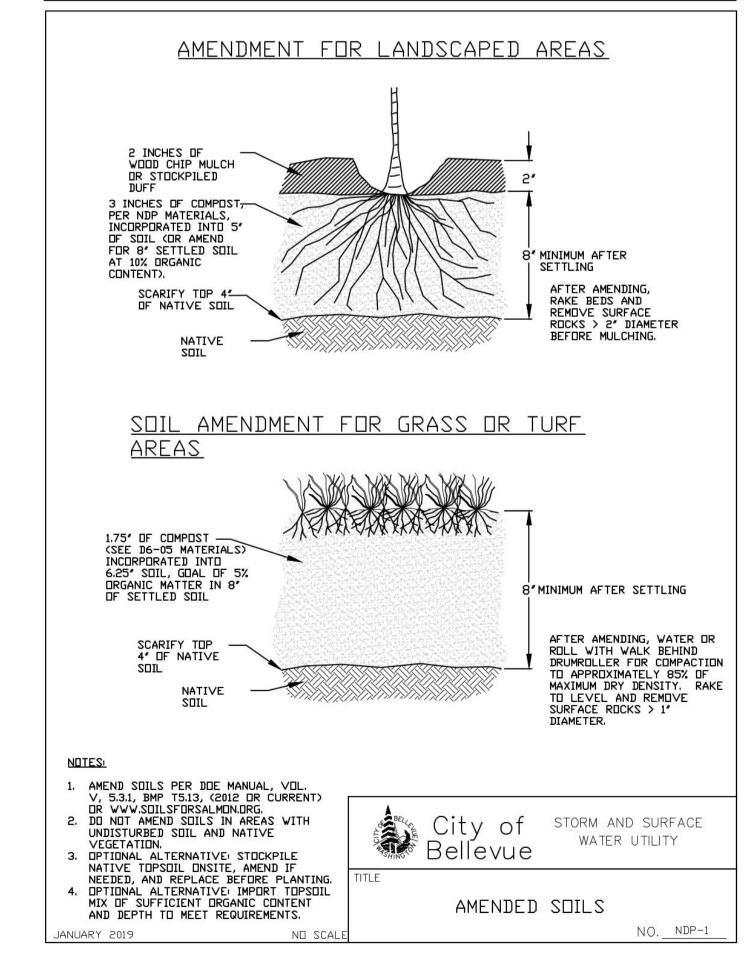
SOIL AMENDMENT REQUIRED

COMPOST AMENDED SOIL REQUIRED ON ALL LANDSCAPED AREAS AFTER CONSTRUCTION. SEE DETAIL BELOW.

SOIL INSPECTION REQUIRED BY ENGINEER

A POST CONSTRUCTION INSPECTION & CERTIFICATION OF AMENDED SOILS IS REQUIRED BY A LICENSED CIVIL ENGINEER. THIS IS REQUIRED BEFORE FINAL SIGN-OFF BY CITY.

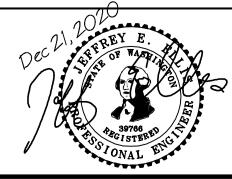
COMPOST AMENDED SOIL SPEC



NO. DATE BY REVISIONS

APPLICANT MN CUSTOM HOMES: JOE NAISETH 1412 112TH AVE. NE, SUITE #104 BELLEVUE, WA 98004 PHONE: 206-353-5823

DATE: Dec 21, 2020 DRAFTED: SS DESIGN: SS DIGITAL SIGNATURE



2244 NW MARKET STREET, SUITE B SEATTLE, WA 98107 PHONE: 206.930.0342 DUFFY@CESOLUTIONS.US

BMP DETAILS

CHEN RESIDENCE ADDITION 9820 SE 35th PLACE, MERCER ISLAND, WA 98040 DRAWING NO: C3.5

APN 082405-9027

TOPOGRAPHIC SURVEY

LEGAL DESCRIPTION

LOT 1, CITY OF MERCER ISLAND SHORT PLAT NO. 82-11-26, ACCORDING TO SHORT PLAT RECORDED MARCH 10, 1983 UNDER RECORDING NO. 8303109004, RECORDS OF KING COUNTY,

EXCEPT THE PORTION LYING NORTHERLY AND WESTERLY OF THE FOLLOWING DESCRIBED LINE: COMMENCING AT THE NORTHWEST CORNER OF SAID LOT 1;

THENCE SOUTH 88'49'28" EAST ALONG THE NORTH LINE THEREOF, A DISTANCE OF 82.40 FEET TO THE TRUE POINT OF BEGINNING OF THE HEREIN DESCRIBED LINE; THENCE SOUTH 01'10'32" WEST A

THENCE SOUTH 64°49'53" WEST A DISTANCE OF 9.36 FEET;

THENCE NORTH 88'49'28" WEST A DISTANCE OF 21.64 FEET;

THENCE SOUTH 64°21'02" WEST A DISTANCE OF 8.31 FEET;

THENCE SOUTH 51"11'48" WEST A DISTANCE OF 14.70 FEET;

THENCE NORTH 88'49'28" WEST A DISTANCE OF 33.69 FEET, MORE OR LESS TO THE WEST LINE OF SAID LOT 1, AND THE TERMINUS OF THE HEREIN DESCRIBED LINE;

TOGETHER WITH SECOND CLASS SHORELANDS ADJOINING THEREOF;

(ALSO KNOW AS LOT 1 OF CITY OF MERCER ISLAND LOT LINE ADJUSTMENT NUMBER SUB01-009, RECORDED UNDER RECORDING NUMBER 20021125900027). PARCEL B:

A NON-EXCLUSIVE EASEMENT FOR INGRESS AND EGRESS OVER THAT PORTION OF THE WEST 15 FEET OF THE EAST 60.44 FEET OF SAID GOVERNMENT LOT 5, SECTION 7, TOWNSHIP 24 NORTH, RANGE 5 EAST. WILLAMETTE MERIDIAN IN KING COUNTY, WASHINGTON, LYING SOUTHERLY OF SAID PROPOSED NORTHERLY RIGHT OF WAY LINE OF RELOCATED NORTH MERCER WAY.

SITUATE IN THE CITY OF MERCER ISLAND, COUNTY OF KING, STATE OF WASHINGTON.

(PER TITLE REPORT PROVIDED BY FIRST AMERICAN TITLE INSURANCE COMPANY, COMMITMENT NO. 4202-2978599, DATED MARCH 14, 2018 AT 7:30 AM)

6. EASEMENT, INCLUDING TERMS AND PROVISIONS CONTAINED THEREIN:

RECORDING INFORMATION: 2670081 IN FAVOR OF: PUGET SOUND POWER & LIGHT COMPANY FOR: ELECTRIC TRANSMISSION LINE

SURVEYOR'S NOTE: PORTION OF EASEMENT LOCATED OVER SUBJECT PARCEL ABANDONED AND RELEASED BY PARTIAL RELEASE OF EASEMENT RECORDING NUMBER 9906100311, RECORDS OF KING COUNTY RECORDER'S OFFICE.

7. EASEMENT, INCLUDING TERMS AND CONDITIONS CONTAINED THEREIN: GRANTED TO: MERCER ISLAND SEWER DISTRICT FOR: SEWER PIPELINE OR LINES AND ALL NECESSARY CONNECTIONS AND APPURTENANCES HERETO RECORDED: JULY 08, 1960

RECORDING INFORMATION: 5179425 AND 5179426 SURVEYOR'S NOTE: THESE ITEMS AFFECT THE PROPERTY, EASEMENT LIES FIVE FEET ON EACH SIDE OF THE SEWER LINE AS CONSTRUCTED, NOT SHOWN ON MAP.

8. ANY AND ALL OFFERS OF DEDICATION, CONDITIONS, RESTRICTIONS, EASEMENTS, BOUNDARY DISCREPANCIES OR ENCROACHMENTS, NOTES AND/OR PROVISIONS SHOWN OR DISCLOSED BY WOODSON SHORT SUBDIVISION FILE NO. MI-82-11-26 RECORDED UNDER

9. SIDE SEWER EASEMENT, INCLUDING TERMS AND PROVISIONS CONTAINED THEREIN: LOCATION: ALONG THE LINE AS CONSTRUCTED WIDTH: UNDISCLOSED

RECORDING NO.: 8404180412 SURVEYOR'S NOTE: DOCUMENT PERTAINS TO THE MAINTENANCE OF SEWER FACILITIES LOCATED IN SEWER EASEMENT SHOWN ON MERCER ISLAND SHORT SUBDIVISION RECORDING

NUMBER 198303109004. NOT SHOWN ON MAP 10. EASEMENT, INCLUDING TERMS AND PROVISIONS CONTAINED THEREIN:

RECORDED: MAY 04, 1984 RECORDING INFORMATION: 8405041140 IN FAVOR OF: PUGET SOUND POWER AND LIGHT COMPANY, A WASHINGTON

FOR: ELECTRIC TRANSMISSION AND/OR DISTRIBUTION SYSTEM

SURVEYOR'S NOTE: THIS ITEM AFFECTS THE PARCEL EASEMENT LIES FIVE ON EACH SIDE OF THE UNDERGROUND POWER LINES AS CONSTRUCTED WITHIN THE WEST 20.00 FEET OF THE PARCEL. NOT SHOWN ON MAP.

14. GRANT AND AGREEMENT OF UNDERGROUND UTILITY EASEMENT AND THE TERMS AND BETWEEN: RALPH E. SEIGEL AND ALICIA A. SEIGEL, HUSBAND AND WIFE AND: JAMES K. LEE AND MIMI D LEE, HUSBAND AND WIFE

RECORDING INFORMATION: 20011119002504 MODIFICATION AND/OR AMENDMENT BY INSTRUMENT: RECORDED: JULY 12, 2005

RECORDING INFORMATION: 20050712000407 SURVEYOR'S NOTE: EASEMENTS SHOWN ON MAP

15. THE TERMS AND PROVISIONS CONTAINED IN THE DOCUMENT ENTITLED "RELINQUISHMENT AND SURRENDER OF EASEMENT RIGHTS AND INTERESTS"

RECORDED: NOVEMBER 25, 2002

SURVEYOR'S NOTE: THIS DOCUMENT RELINQUISHES A PORTION OF THE INGRESS, EGRESS, UTILITIES AND DRAINAGE EASEMENT SHOWN OVER THE EASTERLY PORTION OF LOT 1 OF CITY OF MERCER ISLAND SHORT PLAT, RECORDING NUMBER 198303109004.

SURVEYOR'S NOTES

1. THE PURPOSE OF THIS SURVEY IS TO DETERMINE THE LOCATION OF THE BOUNDARIES AND PROVIDE TOPOGRAPHIC INFORMATION OF THE PARCEL AS DESCRIBED HEREON.

2. THIS SURVEY WAS MADE BY FIELD TRAVERSE USING A LEICA 1203 3" ROBOTIC TOTAL STATION AND GS14RTK GPS WITH RESULTING CLOSURES EXCEEDING THE MINIMUM ACCURACY STANDARDS AS SET FORTH BY WAC 332-130.

3. THE BOUNDARY CORNERS AND LINES DEPICTED ON THIS MAP REPRESENT DEED LINES ONLY. THEY DO NOT PURPORT TO SHOW OWNERSHIP LINES THAT MAY OTHERWISE BE DETERMINED BY

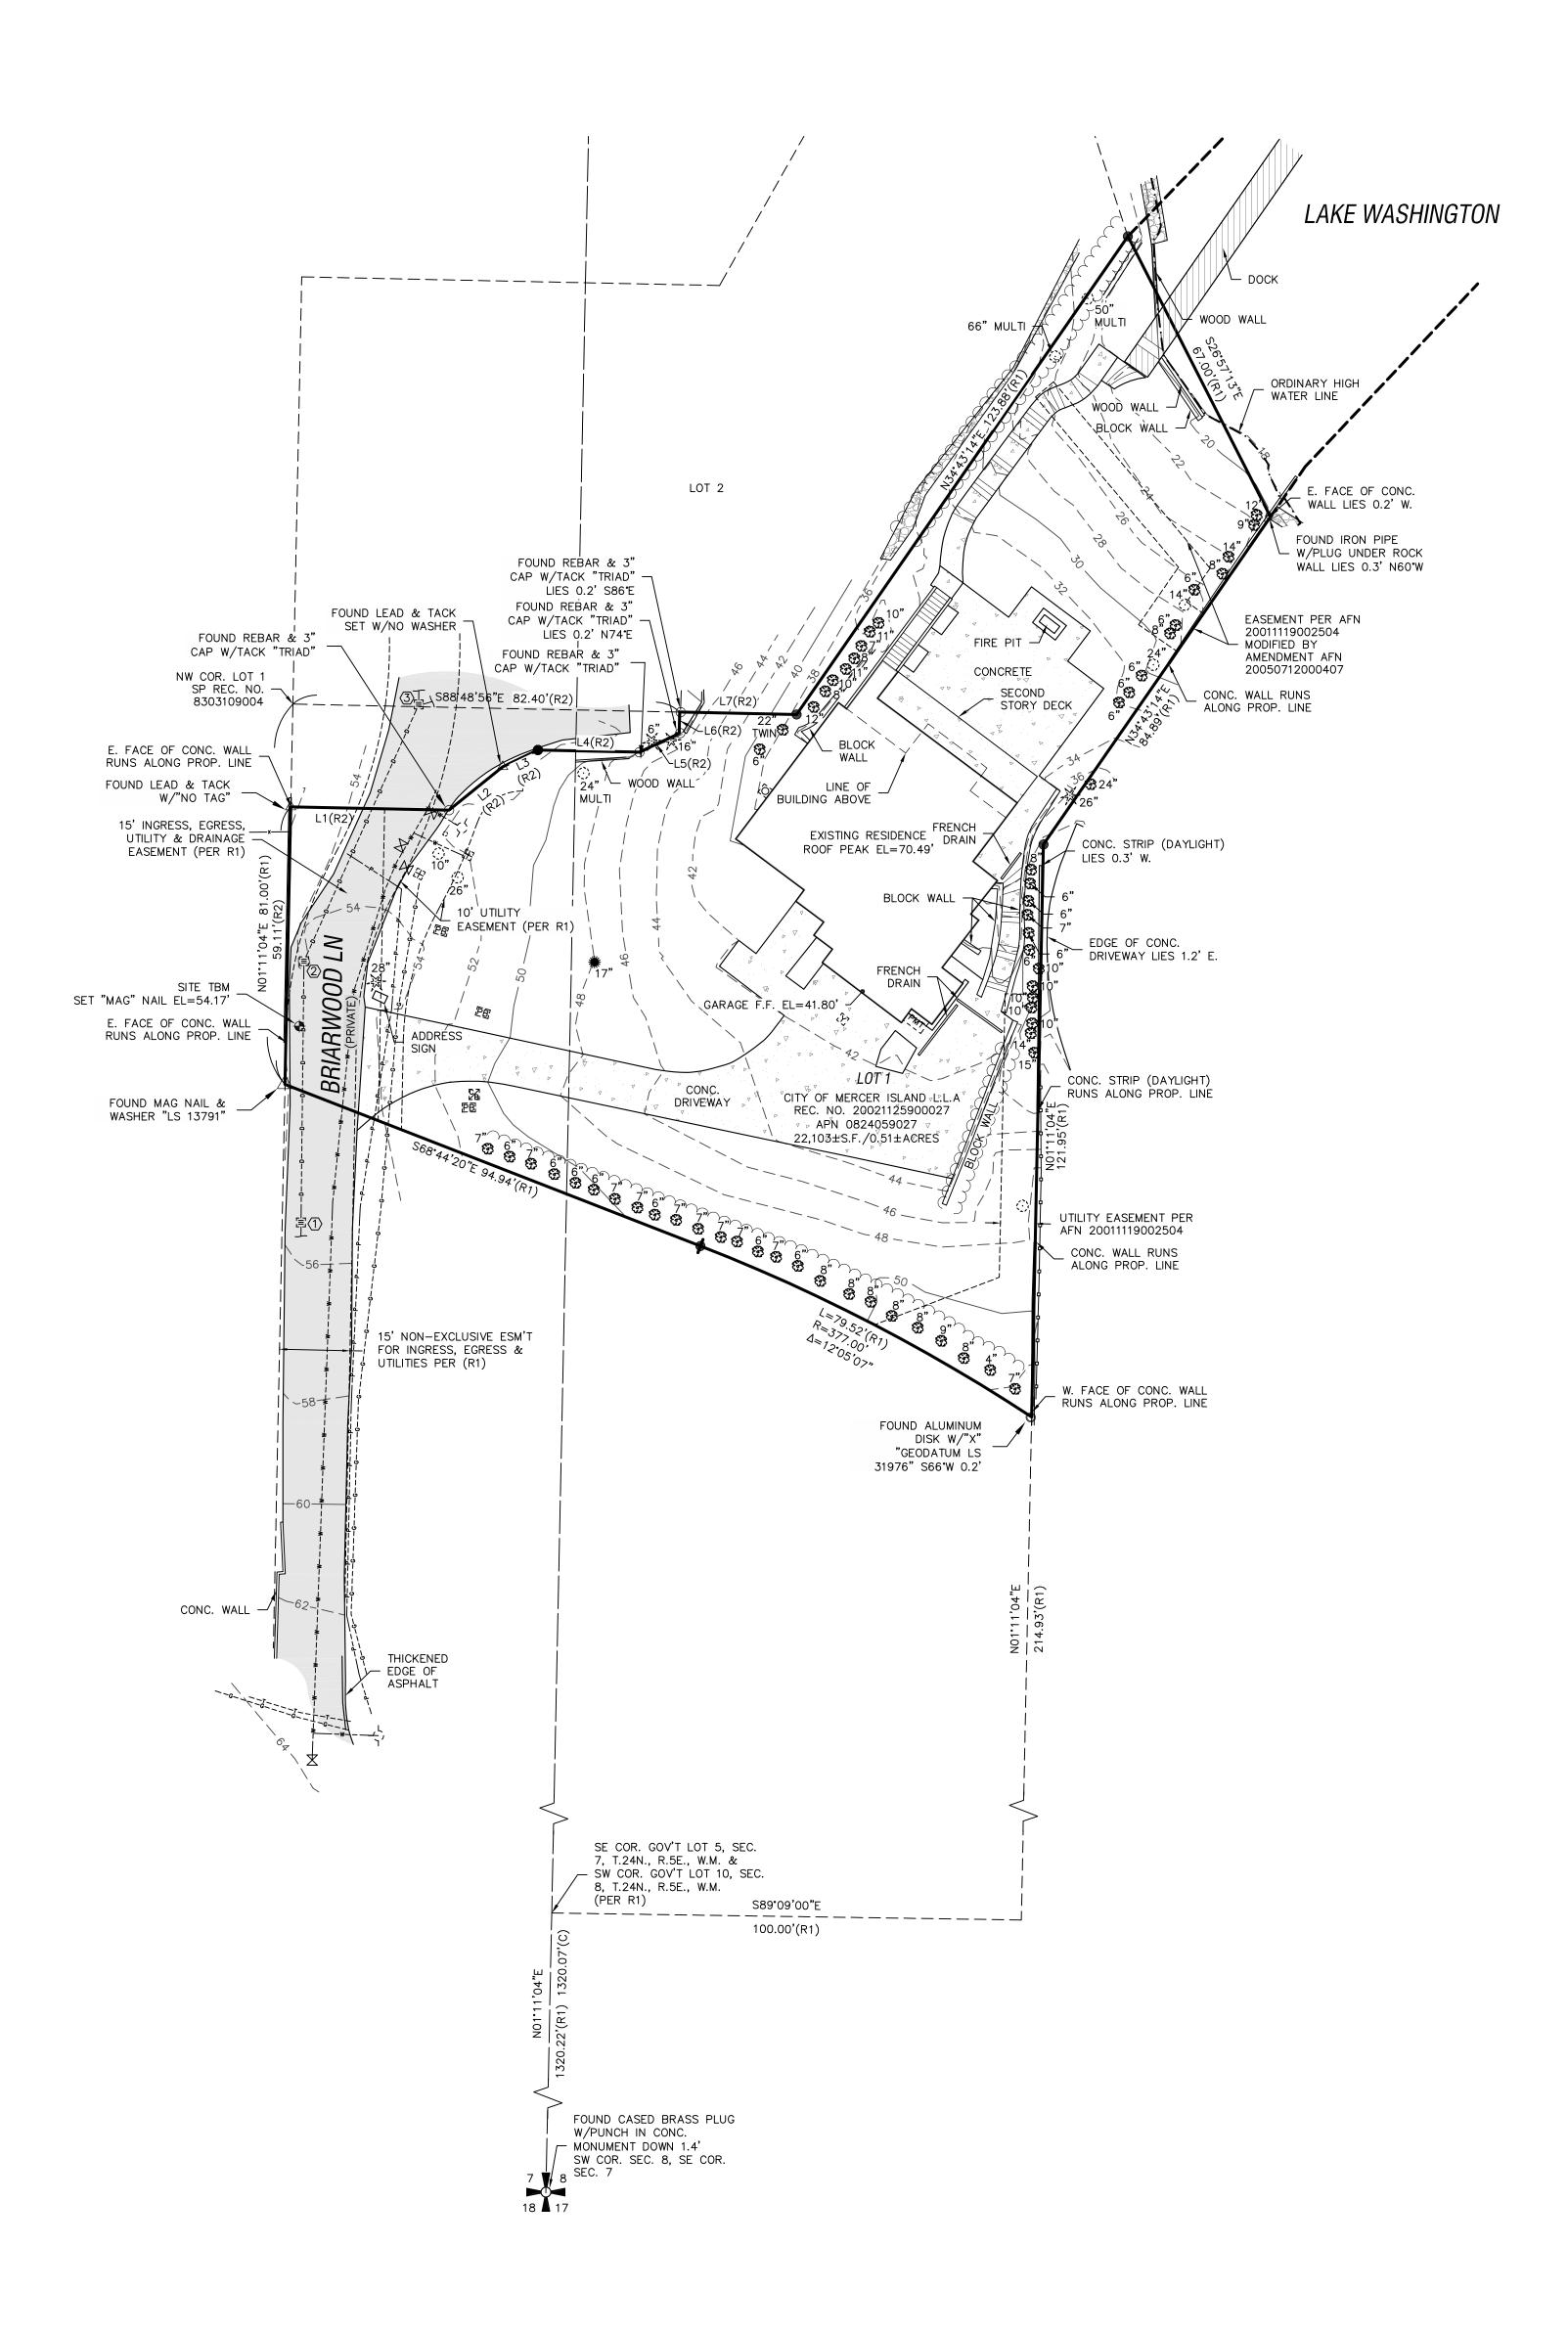
4. THE LEGAL DESCRIPTION IS PER RECORDS OF KING COUNTY RECORDER'S OFFICE, RECORDING NO. 20190419000135, DATED APRIL 19, 2019. A TITLE REPORT HAS NOT BEEN PROVIDED AT THIS TIME, THEREFORE NO INVESTIGATION WAS DONE PERTAINING TO EXISTING ENCUMBRANCES

5. FIELD WORK FOR THIS PROJECT WAS PERFORMED IN MARCH, 2020 AND IS THEREFORE A REFLECTION OF THE CONDITIONS AT THAT TIME. ALL MONUMENTS WERE VISITED OR SET IN

MARCH, 2020. THIS SITE CONTAINS IMPROVEMENTS NOT LOCATED OR SHOWN AS A PART OF

6. THIS SURVEY DOES NOT PURPORT TO SHOW ALL EASEMENTS OF RECORD.

RELATING TO THE SUBJECT PARCEL SHOWN AND DESCRIBED HEREON.



HORIZONTAL DATUM

NAD 1983(2011); PER RTK GPS TIES AND THE WASHINGTON STATE REFERENCE NETWORK (WSRN). UNITS OF MEASUREMENT ARE U.S. SURVEY FEET.

VERTICAL DATUM

NAVD 1988 PER RTK GPS TIES AND THE WASHINGTON STATE REFERENCE NETWORK (WSRN). UNITS OF MEASUREMENT ARE U.S. SURVEY FEET.

REFERENCE SURVEYS

R1) CITY OF MERCER ISLAND SHORT PLAT, RECORDING NO. 8303109004 R2) CITY OF MERCER ISLAND LOT LINE ADJUSTMENT,

RECORDS OF KING COUNTY RECORDER'S OFFICE

RECORDING NO. 20021125900027

FOUND SECTION CORNER (AS SHOWN)

● SET REBAR & CAP EMW LS #44651 O FOUND REBAR & CAP "TRIAD"

△ FOUND LEAD W/TACK

◆ FOUND IRON PIPE (AS SHOWN) SET "MAG" NAIL SITE TEMPORARY BENCHMARK (TBM)

 GUARD POST GAS METER

[PMT] POWER METER

[PB] POWER PULL BOX

国 STORM DRAIN CATCH BASIN

Y YARD DRAIN (s) SEWER MANHOLE

☑ IRRIGATION CONTROL BOX

⟨ FIRE HYDRANT

出 WATER METER

₩ WATER VALVE

DECIDUOUS TREE रिके CEDAR TREE

· EVERGREEN TREE (R) DISTANCE PER REFERENCE

(C) DISTANCE AS CALCULATED

LS LICENSED LAND SURVEYOR ASPHALT SURFACE

CONCRETE SURFACE

ROCKERY

LINE TYPE LEGEND

WOOD FENCE STORM DRAIN LINE

EDGE OF VEGETATION

STORM DRAIN STRUCTURE TABLE

ORDINARY HIGH WATER LINE

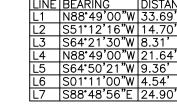
1 CATCH BASIN RIM EL=55.39' (W) 10" DI I.E.=51.19'

(N) 10" DI I.E.=50.99' ② CATCH BASIN

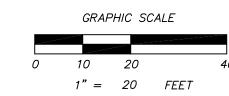
RIM EL=53.94' (S) 10" DI I.E.=49.79' (N) 10" DI I.E.=49.59'

③ CATCH BASIN RIM EL=52.99' (N) 12" DI I.E.=48.74' (S) 10" DI I.E.=48.99'

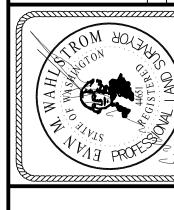
(E) 8" DI I.E.=48.99"



THE EXISTING UTILITIES AS SHOWN ARE ONLY APPROXIMATE AND ARE BASED ON THE BEST AVAILABLE INFORMATION. IT SHALL BE THE CONTRACTOR'S RESPONSIBILITY TO VERIFY THE SIZE, TYPE, LOCATION, AND DEPTH OF ALL EXISTING UTILITIES PRIOR TO STARTING CONSTRUCTION, AND INFORM THE DESIGN ENGINEER OF ANY DISCREPANCIES. Call Before You D**I**g 1-800-424-5555









City of Mercer Island Development Services

9611 SE 36th Street Mercer Island, WA 98040 Inspection Request Line 236-3587 General Information 236-5300

BUILDING PERMIT

SF ADD

Permit No. 9908-047

Project No.

Main Permit No.

							
Site Address: 9820 SE	35TH PL	 		Valuation:	84,444.00	Parcel No.	824059027
Owner: SIEGEL RA	SIEGEL RALPH E+ALICIA A Description of Work: 1110 SF ADDITION TO EXISTING HOME & REMODEL						E & REMODEL
Mailing 9820 SE 35' Address: Mercer Isla		WA 98	040				
Phone: (206)232-11	27						•
			L	egal Descrip	tion		
Lot:		Block:		P	Plat:		
Contractor: MILLER	& MILLE	CR		Address:		•	
						•	
Phone: (425)644-2	253	State	Contractor 1	Lic: MILLEMO	C0550L	MI Business Lie	c#:
Type of Const.: BUILD	ING C	Occ Load:		No. Storie	es:	0.00 Map Lo	c.:
Sprinkler Req'd:	Reason:			Building SF:	0.00	Decks SF:	0.00
Fire Alarm Req'd:	Reason:			Garage SF:	0.00	Total SF:	
Associated Perm	iits:						
	FEES		Receip	t#&Date	C	omments	
Surcharge		4.50		88 10/1/1999			
Building Permit Fee		834.15		88 10/1/1999			
Land Clearing		55.00		88 10/1/1999		•	
Energy Code Plan Check Deposit		55.00 632.29		88 10/1/1999 75 8/6/1999			,
Plan Check Deposit		632.29	498	1/1/-4713			
				1/1/-4713			•
				1/1/-4713			
				1/1/-4713			
				1/1/-4713			
	•			1/1/-4713	ł		
TOTAL FEE	\$	1,580.94					
TOTAL FEES PA		1,580.94					
TOTAL FEES DU		0.00					
the applicability of private cov	enants to t	his permit. Co	mpliance with		nants is the sole		s not responsible for reviewing the applicant/owner.
Signature of Owner/Contr	actor/Autl	horized Agent	İ.		Date		•

FILE COPY

Project No.
Main Permit No.

Permit No.

9908-047

APPROVED NOT APPROVED INSPECTION **INSPECTORS** INSPECTORS COR NOT COMMENTS DATE DATE NAME NAME LAND CLEARING S TEMP POWER 1 GRADING T EROSION CONTROL 1/40 SNCW E Pre Con 126/19 SOILS SETBACK F PILING/STRUCTURAL FILL 0 2/13 -00 FOOTINGS/REBAR U WALLS/REBAR Ν FOUNDATION/ROOF DRAINAGE D DAMP PROOFING Α T 1 0 N UNDER SLAB ELECTRICAL S UNDER SLAB PLUMBING L UNDER SLAB DUCT WORK Α SLAB REINFORCING WIRE 19/16/55 12 8 11/00/2 ROUGH ELECTRICAL ₿ 4/18 SHOWER PANOKONS ROUGH PLUMBING PRV D GAS PIPING WATER SERVICE
HVAC EQUIP. & DUCTS
COMB. AIR/VENTING
ROOF DRAINS (INTERIOR) G Wan n Aprilow O S ٧ C STORMWATER SOURCE CONTROL 4/18 218 S ACARM WIRING STRUCTURAL FRAMING (Per EOR Letter F GLU-LAM BEAMS/TRUSSES \$/1/60 VZ R 3/11 Km GLAZING/MSUCATION PVA 4/170/ VENTILATION/ CATHEY CRAWL SPACE FIRE RATED CONSTRUCTION М 4/1/20 0 Ν OK TO COVER G MAXXXATION ON GROWN BOURD G.W.B. NAILING 4/26 21 MASONARY М HANDICAPPED ACCESS ı S FIRE DAMPERS/SPRINKLERS C PRE-FAB FIREPLACE/STOVES Precised to built 7/4/00 SVaul SANITARY SEWER CONNECTION U D.C.V.A. CHECK VALVE OFF SITE DRAINAGE T L ELECTRICAL PLUMBING H.V.A.C. OPERATION N FIRE DETECTORS/ALARMS Α BUILDING L SITE DRAINAGE/RESTORATION S P EC 1 A L REFUND BY DATE 8 DATE **AMOUNT** INSPECTOR DATE ' APPROVED BY 0 N D



City of Mercer Island Development Services

9611 SE 36th Street Mercer Island, WA 98040 Inspection Request Line 236-3587 General Information 236-5300

BUILDING PERMIT

SF ADD Permit No. 9908-047

Project No.
Main Permit No.

Site Address: 9820 SE	35TH P	L	-	Valuation:	84,44	4.00	Parcel No.	824059027
1				4	Description of Work: REVISION 11/15/99			
Mailing 9820 SE 35 Address: Mercer Isla		WA 98	040					
Phone: (206)232-11	27							
]	Legal Descr	iption			
Lot:		Block:			Plat:			
Contractor: MILLER	& MILL	ER		Address	s:			
							·	
Phone: (425)644-2	2253	State	Contractor	Lici MILLE	MC0550L	MI I	Business Lic	#:
Type of Const.: BUILD	ING	Occ Load:		No. Sto	ries:	0.00	Map Loc	·.:
Sprinkler Reg'd:	Reason	:		Building SF:	0.00	0 De	cks SF:	0.00
Fire Alarm Req'd:	Reasor	1:		Garage SF:	0.00	0 То	tal SF:	
Associated Perm	its:							
					<u> </u>			
	FEES	<u> </u>	Receip	t # & Dat	e	Comi	nents	
Surcharge		4.50	5073					
Building Permit Fee		834.15	5073					
Land Clearing Energy Code		55.00 55.00	5073 5073		İ			
Plan Check Deposit		632.29	4987		İ			
Bldg. Revision Fee		47.00	5143					
Bldg. Revision Fee		150.00	5181				•	
TOTAL FEE	\$	1,777.94						
TOTAL FEES PA		-,						
TOTAL FEES DU	E \$	0.00						
Domesit oursings if work is not a		1 21 100 1		·	0.1 701			

Permit expires if work is not commenced within 180 days or ceases for more than 180 days. The City of Mercer Island is not responsible for reviewing the applicability of private covenants to this permit. Compliance with private plat covenants is the sole responsibility of the applicant/owner.

Signature of Owner/Contractor/Authorized Agent

Date

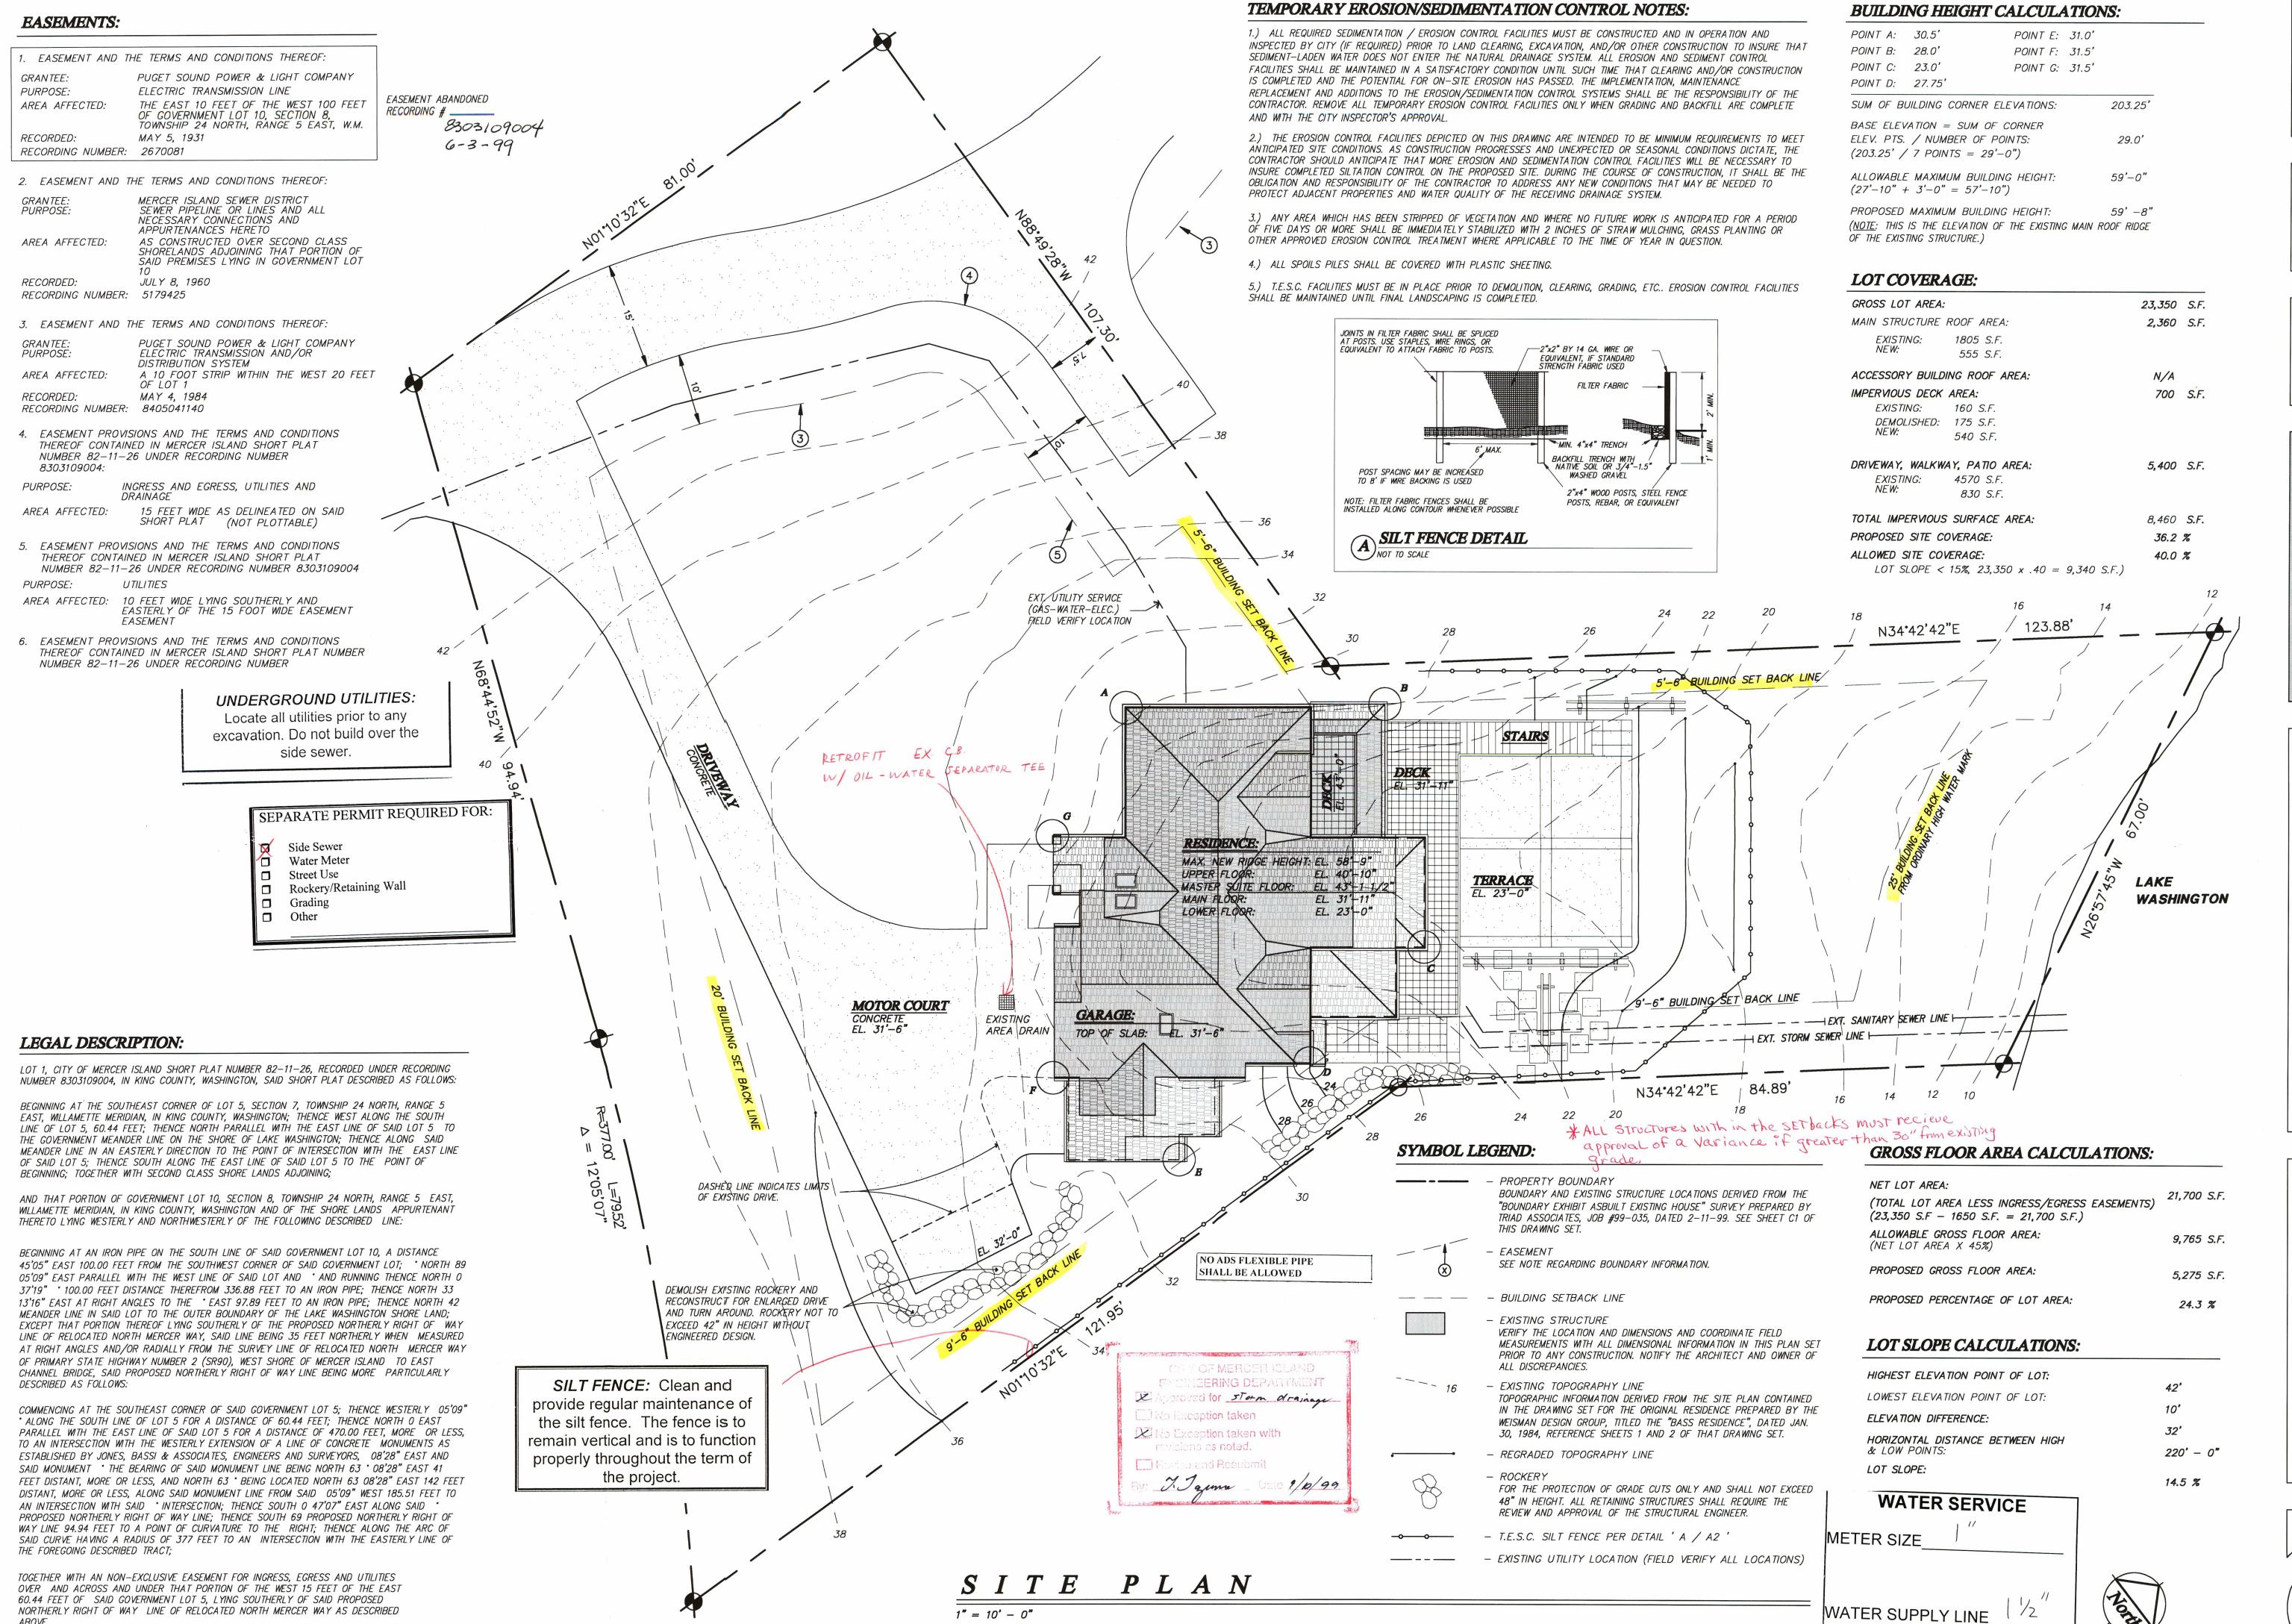
Project No.

Main Permit No.

Permit No.

9908-047

APPROVED NOT APPROVED INSPECTORS INSPECTORS INSPECTION COR NOT COMMENTS DATE NAME OATE NAME LAND CLEARING TEMP POWER S ļ GRADING T EROSION CONTROL Ε SOILS SEIBACK PILING/STRUCTURAL FILL FOOTINGS/REBAR 0 U WALLS/REBAR Ν FOUNDATION/ROOF DRAINAGE D DAMP PROOFING Α T, 1 0 Ν UNDER SLAB ELECTRICAL
UNDER SLAB PLUMBING
UNDER SLAB DUCT WORK S L Α VAPOR BARRIER/INSULATION ₿ SLAB REINFORCING В ROUGH ELECTRICAL ROUGH PLUMBING L GAS PIPING
WATER SERVICE
HVAC EQUIP. & DUCTS D G S COMB. AIR/VENTING V ROOF DRAINS (INTERIOR)
STORMWATER SOURCE CONTROL C S STRUCTURAL FRAMING F GLU-LAM BEAMS/TRUSSES R FRAMING GLAZING/INSULATION М VENTILATION/ (ATTIC/CRAWL SPACE)
FIRE RATED CONSTRUCTION ı Ν OK TO COVER G G.W.B. NAILING MASONARY М HANDICAPPED ACCESS FIRE DAMPERS/SPRINKLERS S С PRE-FAB FIREPLACE/STOVES SANITARY SEWER CONNECTION D.C.V.A. CHECK VALVE U Ţ OFF SITE DRAINAGE ١ L ELECTRICAL F PLUMBING H.V.A.C. OPERATION N FIRE DETECTORS/ALARMS Α BUILDING L SITE DRAINAGE/RESTORATION S P E C Ĺ Α REFUND BY DATE DATE В AMOUNT INSPECTOR DATE APPROVED UY 0 Ν D



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Site

August 3, 1999

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